MOORE COUNTY PLANNING BOARD THURSDAY, APRIL 7, 2022, 6:00 PM MOORE COUNTY HISTORIC COURTHOUSE – 2nd FLOOR

CALL TO ORDER - 6 PM

INVOCATION – (Member Volunteer)

PLEDGE OF ALLEGIANCE – (Member Volunteer)

MISSION STATEMENT – (Member Volunteer)

I. PUBLIC COMMENT PERIOD (Procedures are attached)
Please sign up on the Public Comment Sign In sheet near the door

I. APPROVAL OF CONSENT AGENDA

All items listed below are considered routine and will be enacted by one motion. No separate discussion will be held except by a member of the Planning Board:

- A. Approval of Meeting Agenda
- B. Approval of Minutes of March 3, 2022
- C. Consideration of Abstentions

II. PUBLIC HEARINGS

- 1. Conditional Rezoning Request: Rural Agricultural (RA) to Rural Agricultural Conditional Zoning (RA-CZ) Jaimie Walters
- 2. Conditional Rezoning Request: Rural Agricultural (RA) to Rural Agricultural Conditional Zoning (RA-CZ) Jaimie Walters
- 3. General Use Rezoning: Residential and Agricultural-40 (RA-40) to Highway Commercial (B-2) Jaimie Walters

III. PLANNING DEPARTMENT REPORTS - Debra Ensminger

IV. BOARD COMMENT PERIOD - Chairman

V. UPCOMING EVENTS

- Tuesday, April 19, 2022, 5:30 PM Board of Commissioners Meeting to be held at the Historic Courthouse in Carthage
- Tuesday, May 3, 2022, 10:30 AM Board of Commissioners Meeting to be held at the Historic Courthouse in Carthage
- Thursday, May 7, 2022, 6:00 PM Planning Board Meeting to be held at the Historic Courthouse in Carthage

VI. ADJOURNMENT

Special accommodations for individuals with disabilities or impairments will be made upon request to the extent that reasonable notice is **given** to the County.

PUBLIC COMMENT PROCEDURES MOORE COUNTY PLANNING BOARD

The Moore County Planning Board is committed to allowing members of the public an opportunity to offer comments and suggestions for the efficient and effective administration of government. In addition to public hearings, a special time is set aside for the purpose of receiving such comments and suggestions. All comments and suggestions addressed to the Board during the Public Comment Period shall be subject to the following procedures:

- 1. The Public Comment period will be held at the beginning of the Board meeting. The comment period will be limited to a maximum of thirty minutes
- 2. Persons who wish to address the Board during the Public Comment Period will register on a sign-up sheet available on the table outside the entrance door to the Meeting Room indicating contact information and topic. Sign-up sheets will be available beginning 30 minutes before the start of the meeting. No one will be allowed to have his/her name placed on the list by telephone request to County Staff.
- 3. Each person signed up to speak will have three (3) minutes to make his/her remarks. Each person signed up to speak will only be entitled to the time allotted to each speaker and one additional time period which may be yielded to him/her by another individual who has also signed up to speak on a particular topic.
- 4. Speakers will be acknowledged by the Board Chairperson in the order in which their names appear on the sign-up sheet. Speakers will address the Board from the lectern at the front of the room and begin their remarks by stating their name and address.
- 5. Public comment is not intended to require the Board to answer any impromptu questions. Speakers will address all comments to the Board as a whole and not one individual member. Discussions between speakers and members of the audience will not be allowed.
- 6. Speakers will be courteous in their language and presentation. Matters or comments which are harmful, discriminatory or embarrassing to any citizens, official or employee of Moore County shall not be allowed. Speaker must be respectful and courteous in their remarks and must refrain from personal attacks and the use of profanity.
- 7. Only one speaker will be acknowledged at a time. If the time period runs out before all persons who have signed up get to speak, those names will be carried over to the next Public Comment Period.
- 8. Any applause will be held until the end of the Public Comment Period.
- 9. Speakers who have prepared written remarks or supporting documents are encouraged to leave a copy of such remarks and documents with the Chairperson.
- 10. Information sheets outlining the process for the public's participation in Board meetings will also be available in the rear of the Meeting Room.
- 11. Action on items brought up during the Public Comment Period will be at the discretion of the Board.

Adopted on the 4th day of February, 2010 by a <u>8</u> to <u>1</u> vote of the Moore County Planning Board.

MOORE COUNTY PLANNING BOARD PUBLIC HEARINGS PROCEDURES

The Moore County Planning Board serves the public as well as the Board of Commissioners. During each public hearing a special time has been set aside for the purpose of receiving comments and suggestions. To insure that comments and suggestions are productive and not unnecessarily long, procedural rules for conducting public hearings are necessary. The following procedural rules will be utilized during public hearings of the Moore County Planning Board:

- 1. Anyone who would like to address the Board during a public hearing should register on the appropriate sign-up sheet indicating their name and address. Sign-up sheets will be available on the table outside the entrance door to the Meeting Room 30 minutes before the start of the meeting. Information sheets outlining the process for the public's participation in Board meetings and public hearings will also be available. No one will be allowed to have his/her name placed on the list by telephone request to County Staff.
- 2. Each speaker will be called by the Chairman to the lectern, will state their name and address clearly into the record before providing their comments.
- 3. Speakers will address all comments to the Board as a whole and not to any one individual member. Speakers will be respectful, courteous, refrain from personal attacks and the use of profanity.
- 4. Any applause will be held until the end of the public hearing.
- 5. Speakers who have prepared written remarks or supporting documents are encouraged to leave a copy of such remarks and documents with the Secretary.
- 6. Action on items brought up during the public hearing will be at the discretion of the Board.

Adopted on the 5th day of May, 2011 by a <u>9</u> to <u>0</u> vote of the Moore County Planning Board

MINUTES MOORE COUNTY PLANNING BOARD THURSDAY, MARCH 3, 2022, 6:00 PM MOORE COUNTY HISTORIC COURTHOUSE – 2nd FLOOR

Board Members Present:

Joe Garrison (Chairman), Jeffrey Gilbert, Bobby Hyman, Tucker McKenzie, Farrah Newman, Amy Lynn

Board Members Absent:

John McLaughlin

Staff Present:

Debra Ensminger, Planning Director; Stephanie Cormack, Admin Officer; Jaimie Walters, Senior Planner; Tron Ross, Associate County Attorney

CALL TO ORDER

Chairman Joe Garrison called the meeting to order at 6:00 pm.

INVOCATION

Chairman Joe Garrison offered the invocation.

PLEDGE OF ALLEGIANCE

Chairman Joe Garrison led in citing of the Pledge of Allegiance.

MISSION STATEMENT

Vice Chair Bobby Hyman read the Moore County Mission Statement.

PUBLIC COMMENT PERIOD

The following individuals signed up to speak during the public comment period.

• Debra D'Angelo; 333 Major Rd., Carthage NC. See attached Exhibit A of Ms. D'Angelo comments for record.

APPROVAL OF THE CONSENT AGENDA

- A. Approval of Meeting Agenda
- B. Approval of Minutes of January 6, 2022
- C. Consideration of Abstentions

Vice Chair Bobby Hyman made a motion for approval of the consent agenda and approval of the minutes of January 6, 2022, meeting. Board Member Amy Lynn seconded the motion and the motion passed unanimously 6-0.

PUBLIC HEARING

Public Hearing #1 – Conditional Rezoning Request: Rural Agricultural (RA) to Rural Agricultural Conditional Zoning (RA-CZ) – Beulah Hill Church Rd. – Jaimie Walters

Senior Planner Jaimie Walters presented a request by Cellco Partnership d/b/a Verizon Wireless is requesting a Conditional Rezoning from Rural Agricultural (RA) to Rural Agricultural Conditional Zoning (RA-CZ) to construct a 195' monopole tower for a Wireless Communication Facility on an approximately 0.23-acre portion of one parcel of approximately 677.65 acres located on Beulah Hill Church Road, owned by Hainoa, LLC, per Deed Book 4904 Page 237 and further described as ParID 00026293 in Moore County Tax Records.

Mrs. Walters went over the items within the packet regarding the request, explaining the rezoning request is only for a use of the tower and no additional structures.

With no further questions from the board, Chairman Garrison opened the Public Hearing.

Chairman Garrison asked if there would be a bond included with this submittal.

Mrs. Walters confirmed a bond is required with the application submittal.

Chairman Garrison inquired about the access point and how far off of Beulah Hill Church Rd would it be.

Mrs. Walters confirmed there would be a new access road which would be approximately 300 feet from Beulah Hill Church Rd. to include a buffer composed of existing vegetation as well as fencing.

Board Member Gilbert inquired if there were any churches within a mile of the request.

Mrs. Walters could not confirm however could verify there were no churches adjacent to the property.

The following have signed up to speak during the Public Hearing.

- Victoria Farmer; Verizon Representative from Tennessee
 - o Ms. Farmer explained the need for a tower is to fill a known coverage gap and improve network, the tower is designed for 4 other providers besides Verizon.
 - The location determination was established by current tower locations and property availability which was conducted by a research group.
 - o The lease will be for 30 years in which Verizon will provide any upkeep needed.
 - The tower is not a 5G tower however will have 5G capability and any future network needs as technology changes.

- James Bell; 1909 Vass Carthage Rd. Carthage, adjacent property owner
 - o Mr. Bell feels this is a great need and could benefit many in the area.

With no further discussion or public comment Chairman Garrison closed the Public Hearing.

With no further comments Board Member Amy Lynn made a motion to approve the attached Moore County Planning Board Land Use Plan Consistency Statement and authorize its chairman to execute the document as required by North Carolina General Statute 160D-604. The motion was seconded by Vice Chair Bobby Hyman; the motion passed unanimously 6-0.

Vice Chair Bobby Hyman made a motion to recommend approval to the Moore County Board of Commissioners of the Conditional Rezoning from Rural Agricultural (RA) to Rural Agricultural Conditional Zoning (RA-CZ) to construct a 195' monopole tower for a Wireless Communication Facility on an approximately 0.23-acre portion of one parcel of approximately 677.65 acres located on Beulah Hill Church Road, owned by Hainoa, LLC, per Deed Book 4904 Page 237 and further described as ParID 00026293 in Moore County Tax Records; The motion was seconded by Board Member Farrah Newman; the motion passed unanimously 6-0.

PLANNING DEPARTMENT REPORTS

Ms. Ensminger reminded the board there would be a meeting on April 7th.

BOARD COMMENT PERIOD

Chairman Garrison thanked Moore County staff for all their hard work.

ADJOURNMENT

With no further comments Vice Chair Bobby Hyman made a motion to adjourn the March 3, 2022, regular meeting. The motion was seconded by Board Member Amy Lynn; meeting adjourned at 6:35 p.m., the motion passed unanimously 6-0.

Respectfully submitted by,

Stephanie Cormack

March 3, 2022 Debra D'Angelo 333 Major Rd. Carthage (908) 672-9439

RE: Operation of Contractor business in RA-40 area in Major Sands, 315 Major Rd. Operation of landfill and land clearing and other debri management facility without permit at 315 Major RD.

Zoning Complaints started October 4, 2021 made by next door neighbor Debra D'Angelo 333 Major Rd, (also owns two other vacant lots in Major Sands) against

Stocum Contracting LLC, Erin Stocum, Lewis Jacob Stocum, LLC License application lists 315 Major Rd. as address for business. Operating contractor Yard in Major Sands at 315 Major Rd.' Zoning = RA -40

Contractor Yard not permitted.

Rudy's Home Improvement - Rudy Breighner of 269 Major Rd., adjacent property, is part of the business and routinely dumps land clearing debris at 315 Major Rd.

These businesses are also operating landfill and debris management facility at 315 Major Rd. without permit.

Advertise mulch for sale, mulching operations performed at 315 Major Rd.

Assault & Battery on January 6, 2022, in which neighbor Debra D'Angelo while walking her dogs past 315 Major Rd, had her nose and cheekbone broken by an employee of Stocum Contracting.

Ms. D'Angelo had to move out of her house due to constant threats and physical assaults due to the conflict over the operation of the out of compliance contracting business.

After serious injury reported to Joel Strickland, a letter was sent on January 13, 2022 informing Ms. Roberts, property owner and wife of Lewis Jacob Stocum, both agents of Stocum Contracting LLC, that the operation of the contractor yard is in violation of zoning per Section 8.96 of the Unified Development Ordinance.

To date, dumping of land clearing debris and operation of Stocum Contracting and business by Rudy Breighner continues at 315 Major Rd.

Photos and videos of land clearing debris being dumped within the past week are available.

This is the second time huge piles of debris have been stacked up on the property. THe last piles were burned for over a week on the premises.

Agenda Item: ____ Meeting Date: April 7, 2022

MEMORANDUM TO THE PLANNING BOARD

FROM: Debra Ensminger

Planning and Inspections Director

DATE: March 4, 2022

SUBJECT: Conditional Rezoning Request: Rural Agricultural (RA) to Rural

Agricultural Conditional Zoning (RA-CZ) - Cool Springs Rd

PRESENTER: Jaimie Walters

REQUEST

Milestone Towers LPIV is requesting a Conditional Rezoning from Rural Agricultural (RA) to Rural Agricultural Conditional Zoning (RA-CZ) to construct a 255' self-support lattice tower for a Wireless Communication Facility on an approximately 0.11-acre portion of one parcel of approximately 139.23 acres located on Cool Springs Road, owned by Jordan Three, LLC, per Deed Book 4092 Page 40 and further described as ParID 00003428 in Moore County Tax Records.

Public notification consisted of publishing a legal notice in the local newspaper for two consecutive weeks, notification by mail to adjacent property owners, and placing public hearing signs on the property.

BACKGROUND

The entire parent property is undeveloped timberlands. Adjacent properties include agricultural uses and undeveloped properties.

While the parcel does have some freshwater forested/shrub wetlands, none are located within the rezoning area. The parcel is within a half-mile of a Voluntary Agricultural District. The parcel is also within the AE - 1% (100-year) Flood Zone, however the rezoning area, while not in the flood zone, is adjacent to the flood line. The submitted application meets all of the UDO requirements in Section 8.101 (Wireless Communications Facility).

COMMUNITY MEETING

The community meeting was conducted at the Moore County Sports Complex Multi-Purpose Room on March 16, 2022, between 6:00pm and 7:00pm. Adjacent properties were notified by certified return receipt mail, sent on March 3, 2022. Please refer to attached report for more details.

CONDITIONAL ZONING (CZ)

Conditional rezoning affords a degree of certainty in land use decisions not possible when rezoning to a general district. Conditional Zoning Districts are established to provide for flexibility in the development of property while ensuring that the development is compatible

with neighboring uses. Pursuant to NCGS 160D-703, conditional zoning districts requires the approval of a rezoning by the Moore County Board of Commissioners and approval of a site-specific development plan allowing for the development of specific land uses.

Parallel conditional zoning districts are restricted to those uses (meaning either one or multiple uses) listed in the corresponding general use zoning district.

The request shall be in compliance with all relevant portions of the UDO, except that variations from these standards may be approved by the Board of Commissioners if the site plan is submitted and determined to be suitable for the request, is consistent with the intent of the standards, and ensures compatibility with land uses on surrounding properties.

Specific additional conditions applicable to the rezoning request may be proposed by the applicant, the Planning Board, or Board of Commissioners. Only those conditions mutually approved by the county and the applicant may be incorporated into the permit requirements. If a proposed condition is unacceptable to the owner, the petition can be withdrawn, and the proposed rezoning cannot go forward. Likewise, if a condition is unacceptable to the Board of Commissioners, the petition can be denied and there is no rezoning.

Per NCGS 160D-703(b), conditions and site-specific standards shall be limited to those that address the conformance of development and use of the site to County ordinances and officially adopted plans and those that address the impacts reasonably expected to be generated by the development or use of the site.

ZONING DISTRICT COMPATIBILITY

The requested rezoning to Rural Agricultural Conditional Zoning (RA-CZ) is consistent with the existing uses located near the property, including agricultural uses, as the underlying zoning district will remain Rural Agricultural (RA). The surrounding area is zoned Rural Agricultural (RA).

CONSISTENCY WITH THE 2013 MOORE COUNTY LAND USE PLAN

The future land use map identifies the property as Rural Agricultural Classification. The requested zoning to Rural Agricultural Conditional Zoning (RA-CZ) is compatible with the Rural Agricultural Land Use Classification as the underlying district will remain Rural Agricultural (RA) and the request is limited to the wireless communication facility use. Wireless Communication Facility service is in demand in a largely rural area.


The Land Use Plan states the primary use of the Rural Agricultural Land Use Classification is to support rural residential life associated with agricultural uses (e.g., row crops, forestry, horticulture, grazing, poultry, dairy, swine operations, and intensive agricultural uses in certain areas) and other rural activities.

The Moore County Unified Development Ordinance states the Rural Agricultural (RA) district is intended to encourage the continuance of agricultural uses as well as to ensure that residential development of appropriate intensities that are consistent with the suitability of land, availability of public services, and that are compatible with surrounding development, will occur at appropriate densities to provide a healthful environment. The RA District is also intended to accommodate rural commercial activities where the use of site-specific development plans,

individualized development conditions, vegetative buffers, larger lots, and the compatibility of adjacent land uses are considered to provide suitable locations for rural commerce and other rural activities.

The rezoning request aligns with the following recommendation as included in the attached Land Use Plan Consistency Statement, including Action 1.5.2: Support new developments that utilize existing or implement planned infrastructure that most economically preserves open space and important historical, natural and cultural features.

MOORE COUNTY FUTURE LAND USE MAP

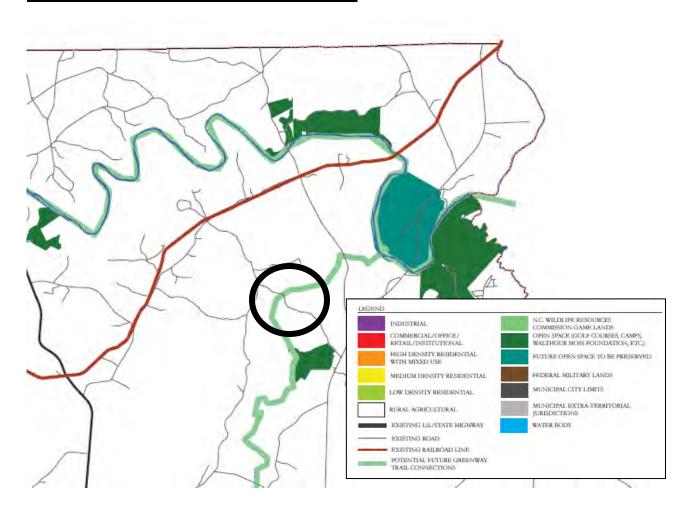

RECOMMENDATION

Staff recommends the Moore County Planning Board make two separate motions:

Motion #1: Make a motion to adopt the attached **Approval** or **Denial** Moore County Planning Board Land Use Plan Consistency Statement and authorize its Chairman to execute the document as required by North Carolina General Statute 160D-604.

Motion #2: Make a motion to recommend **Approval** or **Denial** to the Moore County Board of Commissioners of the Conditional Rezoning from Rural Agricultural (RA) to Rural Agricultural Conditional Zoning (RA-CZ) to construct a 255' self-support lattice tower for a Wireless *Cool Springs Road – Conditional Rezoning – Staff Report*

Communication Facility on an approximately 0.11-acre portion of one parcel of approximately 139.23 acres located on Cool Springs Road, owned by Jordan Three, LLC, per Deed Book 4092 Page 40 and further described as ParID 00003428 in Moore County Tax Records.


ATTACHMENTS

- Pictures of Property and Adjacent Properties
- Vicinity Map
- Land Use Map
- Rezoning Map
- Planning Board Consistency Statement Approval
- Planning Board Consistency Statement Denial
- Submitted Conditional Rezoning Application
- Submitted Wireless Communications Facilities Application
- Submitted Site Specific Development Plan
- Community Meeting Report
- Deed Book 4092 Page 40

Subject Property



View of Subject Property along Cool Springs Rd.

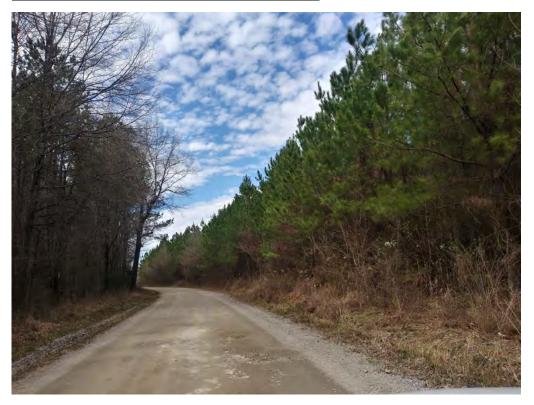


Cool Springs Road - Conditional Rezoning - Staff Report





Cool Springs Road - Conditional Rezoning - Staff Report

Adjacent property - Undeveloped

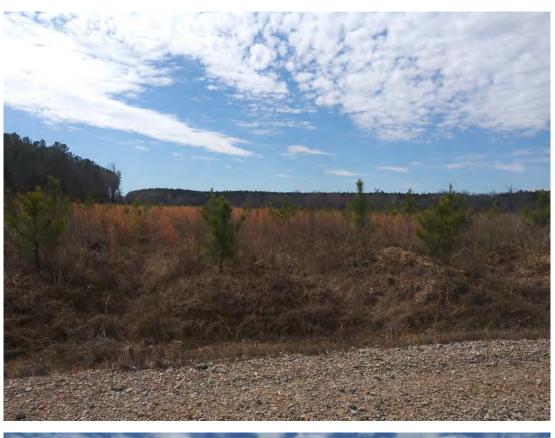




Cool Springs Road - Conditional Rezoning - Staff Report


Adjacent property - Undeveloped






Cool Springs Road - Conditional Rezoning - Staff Report

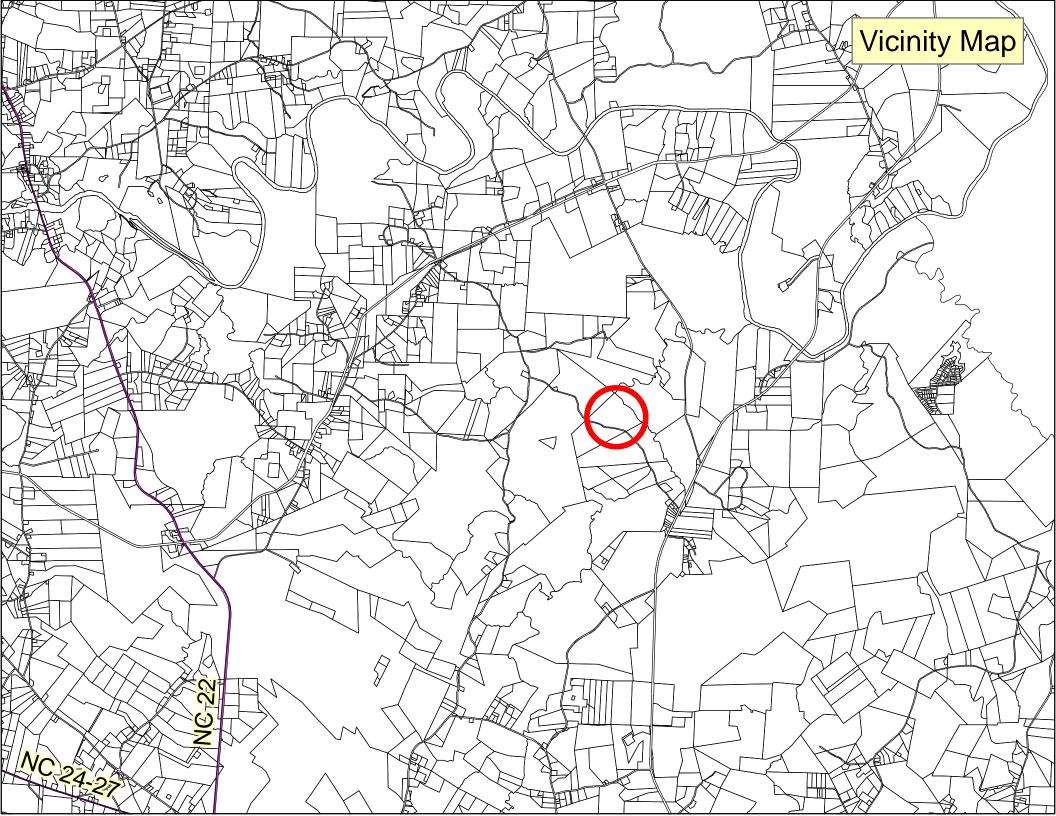

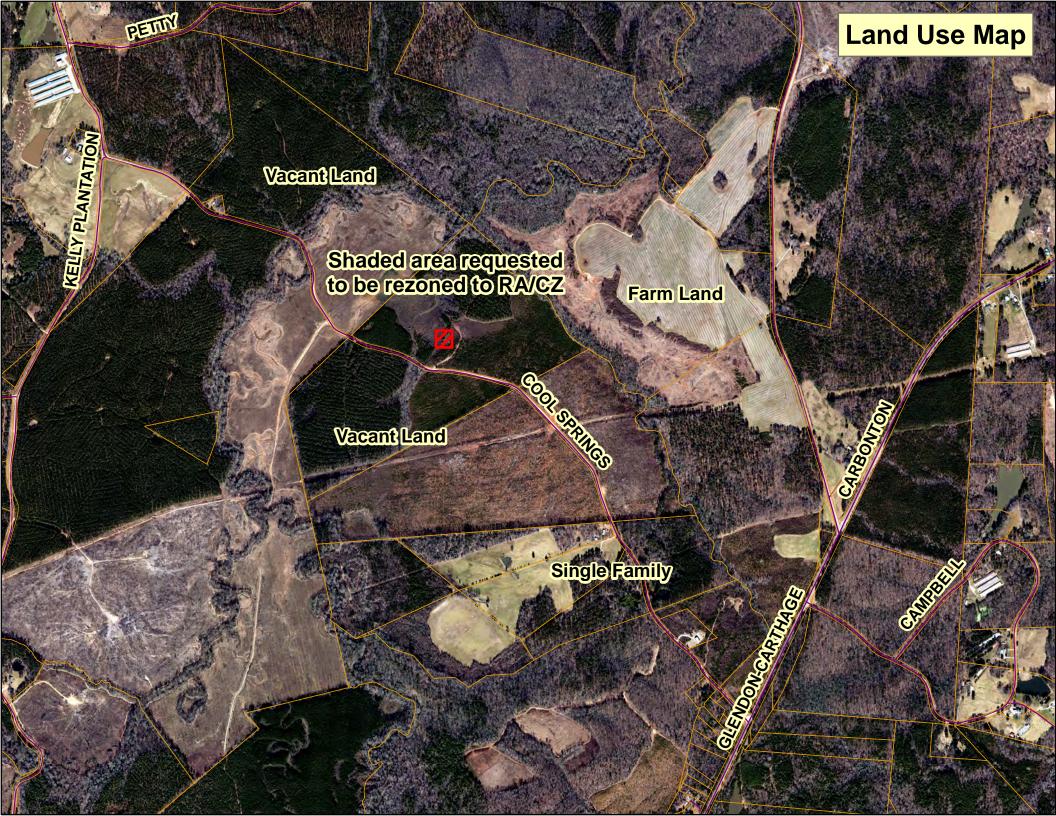

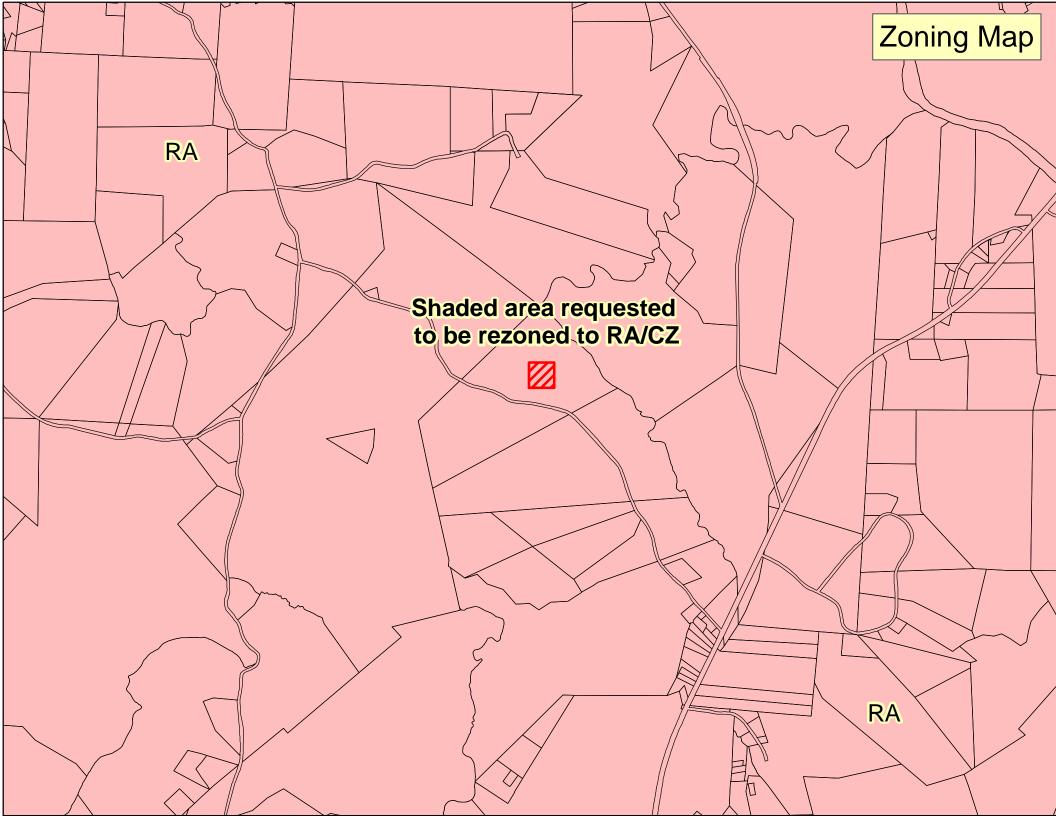

Moore County Planning Board Land Use Plan Consistency Statement Conditional Rezoning Request Rural Agricultural (RA) to Rural Agricultural Conditional Zoning (RA-CZ)

The Moore County Planning Board finds that:

1. The rezoning request is consistent with the following goal as listed in the 2013 Moore County Land Use Plan:

Goal 1: Preserve and Protect the Ambiance and Heritage of the County of Moore (inclusive of areas around the municipalities)

- Action 1.5.2: Support new developments that utilize existing or implement planned infrastructure that most economically preserves open space and important historical, natural and cultural features.
- 2. The rezoning request is reasonable and in the public interest considering the property is located adjacent to existing roads and the underlying zoning district will remain in harmony with surrounding zoning.
- 3. Contributing factors in the rezoning approval are in response to managing the demand of wireless communication service in a largely rural area. This request will also limit the rezoning to maximum area necessary to achieve the development.

Therefore, the Moore County Planning Board recommends **APPROVAL** of the Conditional Rezoning from Rural Agricultural (RA) to Rural Agricultural Conditional Zoning (RA-CZ) to construct a 255′ self-support lattice tower for a Wireless Communication Facility on an approximately 0.11-acre portion of one parcel of approximately 139.23 acres located on Cool Springs Road, owned by Jordan Three, LLC, per Deed Book 4092 Page 40 and further described as ParID 00003428 in Moore County Tax Records.

Joe Garrison, Chair	Date	
Moore County Planning Board		

<u>Land Use Plan Consistency Statement</u> Conditional Rezoning Request Rural Agricultural (RA) to Rural Agricultural Conditional Zoning (RA-CZ)

The Moore County Planning Board finds that:

1. The rezoning request is consistent with the following goal as listed in the 2013 Moore County Land Use Plan:

Goal 1: Preserve and Protect the Ambiance and Heritage of the County of Moore (inclusive of areas around the municipalities)

- Action 1.5.2: Support new developments that utilize existing or implement planned infrastructure that most economically preserves open space and important historical, natural and cultural features.
- 2. The proposed rezoning is not reasonable and not in the public interest because the proposed rezoning will have an unreasonable impact on the surrounding community.

Therefore, the Moore County Planning Board recommends **DENIAL** of the Conditional Rezoning from Rural Agricultural (RA) to Rural Agricultural Conditional Zoning (RA-CZ) to construct a 255' self-support lattice tower for a Wireless Communication Facility on an approximately 0.11-acre portion of one parcel of approximately 139.23 acres located on Cool Springs Road, owned by Jordan Three, LLC, per Deed Book 4092 Page 40 and further described as ParID 00003428 in Moore County Tax Records.

Joe Garrison, Chair	 Date	
Moore County Planning Board		



Inspections/Permitting: (910) 947-2221 Planning: (910) 947-5010

Fax: (910) 947-1303

Conditional Rezoning Application

Application Date: February 17, 2022			
Address of Property: Parcel ID/PIN - 00003428/86700671721			
Applicant: Jonathan L. Yates for Milestone Towers LPIV	and Jordan Two, LLC	Phone: (843) 414-9754
Applicant Address: 105 Broad St., 3rd Floor	City: Charleston	St: sc	Zip: 29401
Owner: Jordan Two, LLC		Phone:	
Owner Address: PO Box 98	City: Mount Gilead	St: NC	Zip: 27306
Current Zoning District: RA	Proposed Zoning Distric	: RA	
Current Use(s): Timber Tract	Proposed Use(s): Wirele	ess Communicatio	ns Facility
Proposed rules, regulations, condition(s) for the proposed opment or use of the site:	d district that address the impacts ex	pected to be ge	enerated by the devel-
Non-applicable.			
Statement of reasonableness of the proposed conditional zoning. The statement shall include, but not be limited to the following: 1. The conditional rezoning compatibility with the County Land Use Plan and other adopted plans of the County. 2. The conditional rezoning compatibility with the existing land uses on abutting and neighboring tracts.			
 The benefits and detriments of the conditional surrounding community. 			
1. Goal #1 of the Growth Management Policy of the 2020 Mo	oore County Land Use Plan is to preser	ve and protect the	ambiance and heritage
of Moore County. The recommendations and actions within	this goal broadly describe being mindfu	d of the intensity o	of any proposed land use.
This 72-acre timber tract provides a perfect location for the proposed wireless communications facility. The proposed wireless communications			
facility will benefit the community and maintain the "ambiance and heritage" of Moore County.			
2. The proposed wireless communications facility will be compatible with the existing land uses on abutting and neighborhood lands due to the			
size of the Jordan Four, LLC property and the facility's careful placement on the property.			
3. The proposed wireless communications facility will benefit the surrounding community by providing necessary and effective wireless			
infrastructure for both voice and broadband.			

I (We), the undersigned, certify that all statemen (our) knowledge, and do hereby agree to follow County of Moore Zoning Administrator.		
Jordan Two, LLC		
Applicant/Owner Signature	Date	
By: R.B. S. L.	2/14/2022	
Applicant/Owner Signature	Date	
Robert B. Jordan, IV	Applicant Signature	Date 02.17.22
Office Use Only:	Apolt	38693
PARID: 00003428	-	
gainie L. Walfers	2-18-22	
Received By	Date	



Inspections/Permitting: (910) 947-2221

Planning: (910) 947-5010 Fax: (910) 947-1303

WIRELESS COMMUNICATION FACILITIES (WCF) FREESTANDING NON-CONCEALED

Applicant Information		
Applicant Name:Jonathan L. Yates for M		
Address: 105 Broad St., 3rd Floor	City: Charleston	State: <u>SC</u> Zip: <u>29401</u>
Office Phone: (843) 414-9754	Cell Phone: (843) 813-0103	Fax:
Email: ily@hellmanyates.com		
Applicant Classification: Commer	cial Wireless Provider 🛮 Gov	ernmental User 🛪 Private Business User
Is this a joint application by two or m	nore wireless service provider	rs? 🗆 YES 🐧 NO
If this is a joint application, please at	tach contact information fo	r each additional applicant.
Parcel Information ParlD #: 00003428/86700671721	Zoning District: RA	
		State: <u>NC</u> Zip: 28327
Landowner Information		
Landowner Name: <u>Jordan Two, LLC</u>	Phon	e:
		State: <u>NC</u> Zip: 27036
	On / Pious Grand	51016. <u>116</u> 215. 27030
WCF Owner Information		
Owner Name: Milestone Towers LPIV	Contact Name	9: Matthew Penning
		State: <u>VA</u> Zip: <u>20190</u>
		Fax:
Email: <u>matt@milestonetowers.com</u>		
WCF Facility Information		
Street Address: 734 Cool Springs Rd.	City: Carthage	State: <u>NC</u> Zip: <u>28237</u>
Latitude: 35' 26' 47.19"N	Longitude: 79	
Support structure height: 255	Ground eleva	tion (ASML): 251 ft.
Support structure description: Mo		upporting Lattice Tower 🛮 Guyed Tower 🗈 Other
Height of proposed co-location (AG		Additional co-locations available? 🕱 YES 🗆 NO

Number of co-location slots available: Five



Inspections/Permitting: (910) 947-2221

Planning: (910) 947-5010 Fax: (910) 947-1303

APPLICATION REQUIREMENTS

Please check each item per the Moore County Unified Development Ordinance Section 8.101(B):

- Site Plan. In addition to the site plan requirements per Section 4.2, the following shall be included: details of existing and proposed facilities and fall zone radius labeled "NO BUILD ZONE."
- Radio Frequency. A statement from a registered engineer that the WCF will be maintained and operated in accordance with all applicable Federal Communications Commission (FCC) rules regarding radio frequency emissions and interference and if there is interference with public safety communications, the applicant shall utilize procedures set forth by the FCC and the party causing the interference shall reimburse the County for all costs associated with resolving the interference.
- Structural Analysis. Signed and sealed by a NC Registered Professional Engineer that the support structure upon completion of the applicant's installation has the structural integrity to accommodate the proposed equipment and complies with all applicable Federal and State building, fire, structural, electrical, and safety codes.
- Lighting. Applicant shall provide documentation that lighting shall not exceed the Federal Aviation Administration (FAA) minimum standards (minimum intensity and longest duration between flashes) and shall utilize allowed downward shielding to minimize visual impact to pedestrians and reduce the potential attraction to migratory birds. Strobe lights during daylight hours and red lights during nighttime hours unless specifically prohibited by the FAA. A WCF may utilize a security light controlled by a motion-detector sensor at or near the entrance to the facility.
- Owner Authorization. Proof that a property and/or antenna support structure owner's agent has appropriate authorization to act upon the owner's behalf if applicable.
- Insurance. Proof of certificates of insurance of general liability insurance in the amount of at least \$1,000,000 covering any liability arising out of its construction or operation of the WCF.
- Bond. Applicant shall submit a performance bond or letter of credit from an accepted bank in the amount of \$20,000 or a bond equal to the written estimate from a qualified tower removal contractor to guarantee that the facility will be removed when no longer in use.
- US Fish and Wildlife Service submitted information, if applicable. □ Yes □ No
 National Environmental Policy Act (NEPA) checklist, if applicable. □ Yes □ No
 State Historic Preservation Office (SHPO) letter, if applicable. □ Yes □ No
 Federal Aviation Administration (FAA) approval, if applicable. □ Yes □ No
- Buffer. Refer to Section 7.11. Grading shall be limited to necessary area.
- Minimum Antennas. Wireless support structures (WSS) up to 80 feet –2 antennas minimum. WSS between 81 and 100 feet 3 antennas minimum. WSS 101 and 125 feet 4 antennas minimum. WSS 126 feet or taller 5 antennas minimum.
- Safety. All support structures shall be certified to comply with the safety standards contained in the Electronics Industries Association /Telecommunications Industries Association (EIA/TIA) document 222-F, or current standard, "Structural Standards For Steel Antenna Towers and Supporting Structures," or current standard, as amended, by a Registered North Carolina Professional Engineer. The use shall be totally enclosed by a security fence a minimum (6) feet high with 3-strand barbed wire or razor wire.



Inspections/Permitting: (910) 947-2221

Planning: (910) 947-5010 Fax: (910) 947-1303

- Setbacks. One foot for every 1 foot in linear height from any property line. WCF shall be a minimum 2,640 feet from any designated National Register of Historic Places.
- Height. Any WSS shall be 195 feet or less in height. The Moore County Board of Commissioners may permit a taller tower only if undisputable evidence is provided at application that the WCF service area will be so substantially compromised that there would be a requirement of additional WCFs within a distance of two (2) miles.
- Necessity. For all new WSS applications, a certification from the applicant's RF engineer that it is not reasonably feasible (technically or commercially impractical or the owner of the WSS is unwilling to enter a contract at fair market value) to co-locate new antennas and equipment on an existing WSS within the geographic search area.

I (We), the undersigned, certify that all statements furnished in this application are true to the b (our) knowledge, and do hereby agree to follow all reasonable requests or information as design County of Moore Zoning Administrator.	est of my nated by the
Jordan Two, LCC	
Applicant/Owner Signature Date	
By: 8.8 1 2/40/200	
Applicant/Owner Signature Date	
Robert B. Jordan, IV Applicant Signature AT the	Date 62.17.22
Office Use Only:	
PARID: 00003428	38693
Comul J. Walters 2-18-22	
Date Date	



February 17, 2022

To: STONEWOOD_DR

Transmitted via email to matt@milestonetowers.com

RE: Verizon – Stonewood Dr 427405 - Macro Site Located at: Glendon Carthage Rd., Carthage, NC 28327

This is in response to your inquiry to Verizon concerning interference to your existing telecommunications devices and services related to Verizon's proposed facilities at [Glendon Carthage Rd., Carthage, NC 28327]. Verizon provides Commercial Mobile Radio Services ("CMRS") under licenses granted by the Federal Communication Commission ("FCC"). Pursuant to these licenses, Verizon is authorized to operate its CMRS network in many geographic areas throughout the nation, including the above noted location. The FCC exclusively regulates all technical aspects of Verizon operations and network and preempts all state and local regulation of radiofrequency transmissions. The FCC rules protect co-channel and adjacent licensees against harmful interference.

The above noted proposed Verizon facility is compliant with all applicable FCC requirements. The points below cover Verizon's practices pertinent to complying with the FCC requirements:

1. Verizon locates its transmitting antenna(s) in order to maximize vertical and horizontal separation from other operator's systems to minimize interference potential.

2. All equipment at the proposed facility is designed and certified to operate within the frequencies

licensed to Verizon by the FCC, and to operate in a manner approved by the FCC..

3. The power levels generated by the facility's radios and corresponding effective radiated power (ERP) from the transmitting antenna(s) are within the limitations specified by Part 22 (for cellular), Part 24 (for PSC), Part 27 (for 700 MHz or AWS), Part 96 (for CBRS), Part 30 (UMFUS/mmWave) or Part 101 (for microwave) of the Commission's Rules.

Verizon is committed to providing state of the art wireless services that benefit your community. In the unlikely event that interference does occur, Verizon agrees to fully cooperate with the entity experiencing interference to identify and correct, to the extent reasonably possible, any issues caused by the Verizon installation.

Please contact your local Verizon resource below if you have additional site-specific questions.

Contact Name	Contact Email	Contact Phone
Kelly Quate	SE-Regulatory@verizonwireless.com	704-574-5273

Sincerely,

Jignesh Choksi

Manager-RF System Design

gnesh Choksi

Verizon



February 11, 2022

Matt Penning Milestone Towers 1801 Reston Parkway, #101 Reston, VA 20190

RE: 255' Self-Supporting Tower for Jordan Lumber, NC

Dear Mr. Penning,

Upon receipt of order, we propose to design and supply the above-referenced tower for a Basic wind speed of 114 mph without ice and 30 mph with 1.5" ice, Risk Category II, Exposure Category C, and Topographic Category 1, in accordance with the Telecommunications Industry Association Standard ANSI/TIA-222-G, "Structural Standards for Steel Antenna Towers and Antenna-Supporting Structures", using structural steel, to support loading for Verizon Wireless and (4) additional carriers.

When designed according to this standard, the wind pressures and steel strength capacities include several safety factors. Therefore, it is highly unlikely that the tower will fail structurally in a wind event where the design wind speed is exceeded within the range of the built-in safety factors.

Should the wind speed increase beyond the capacity of the built-in safety factors, to the point of failure of one or more structural elements, the most likely location of the failure would be within one or more of the tower members in the upper portion. This would result in a buckling failure mode, where the loaded member would bend beyond its elastic limit (beyond the point where the member would return to its original shape upon removal of the wind load).

Therefore, it is likely that the overall effect of such an extreme wind event would be localized buckling of a tower section. Assuming that the wind pressure profile is similar to that used to design the tower, the tower is most likely to buckle at the location of the highest combined stress ratio in the upper portion of the tower. This would result in the portion of the tower above the failure location "folding over" onto the portion of the tower below the failure location and would effectively result in a fall radius less than or equal to the height of the tower. Please note that this letter only applies to the above-referenced tower designed and manufactured by Sabre Industries.

Sincerely,

David Hill, P.E. Design Engineer II SEAL 051984

OTHER DESIGNATION OF THE PROPERTY OF THE PROPERTY



703.620.2556 12110 Sunset Hills Rd. Suite 600, Reston, VA 20190

Moore County February 9, 2022

Planning & Community Development Jamie Walters, MPA, CZO. Senior Planner 1048 Carriage Oaks Drive Carthage, NC 28327

Subject Compliance with FAA Determination

Ms. Walters.

At the time of this letter, Milestone Towers (Milestone) has not received a Final Determination from the Federal Aviation Authority (FAA) as to what (if any) level of obstruction marking/lighting will be required for the proposed 255 tall self-support tower at the Jordan Lumber property on Cool Springs Road in Carthage.

An application [2022-ASO-952-OE] was filed with the FAA on January 10, with an expected Final Determination date of April 30 The letter will be provided to your office upon receipt.

In the interim, please accept this letter as evidence that Milestone, the applicant and developer for this project, agrees to provide only the required level of obstruction marking/lighting as specified by FAA to ensure safe airspace navigation. To confirm - Milestone will not voluntarily outfit the tower with obstruction marking/lighting that exceeds the FAA standards or what is required at this site by the any other controlling governmental airport authority (local or state) Should you have any questions, please do not hesitate to contact me.

Sincerely,

Matt Penning,

Thurst

Director of Development | Milestone Towers matt@milestonetowers.com

703 865-4697

140MILESDEV

ACORD.

CERTIFICATE OF LIABILITY INSURANCE

DATE (MM/DD/YYYY) 2/15/2022

THIS CERTIFICATE IS ISSUED AS A MATTER OF INFORMATION ONLY AND CONFERS NO RIGHTS UPON THE CERTIFICATE HOLDER. THIS CERTIFICATE DOES NOT AFFIRMATIVELY OR NEGATIVELY AMEND, EXTEND OR ALTER THE COVERAGE AFFORDED BY THE POLICIES BELOW. THIS CERTIFICATE OF INSURANCE DOES NOT CONSTITUTE A CONTRACT BETWEEN THE ISSUING INSURER(S), AUTHORIZED PRESENTATIVE OR PRODUCER, AND THE CERTIFICATE HOLDER.

ORTANT: If the certificate holder is an ADDITIONAL INSURED, the policy(ies) must have ADDITIONAL INSURED provisions or be endorsed. If SUBROGATION IS WAIVED, subject to the terms and conditions of the policy, certain policies may require an endorsement. A statement on this certificate does not confer any rights to the certificate holder in lieu of such endorsement(s).

PRODUCER McGriff Insurance Services 5850 Waterloo Road, Suite 240 Columbia, MD 21045	CONTACT CARD Humphrey PHONE (A/C, No, Ext): 410 480-4454 E-MAIL ADDRESS: KMHumphrey@McGriff.com	866-548-4197
410 480-4400 INSURED Milestone Development Inc. Milestone Tower Limited Partnership IV	INSURER(S) AFFORDING COVERAGE INSURER A: Hanover Insurance Company INSURER B: Allmerica Financial Alliance Ins Co INSURER C: Citizens Insurance Co of America	NAIC # 22292 10212 31534
12110 Sunset Hills Road Suite 100 Reston, VA 20190 COVERAGES CERTIFICATE NUMBER	INSURER D : INSURER F :	

THIS IS TO CERTIFY THAT THE POLICIES OF INSURANCE LISTED BELOW HAVE BEEN ISSUED TO THE INSURED NAMED ABOVE FOR THE POLICY PERIOD INDICATED. NOTWITHSTANDING ANY REQUIREMENT, TERM OR CONDITION OF ANY CONTRACT OR OTHER DOCUMENT WITH RESPECT TO WHICH THIS CERTIFICATE MAY BE ISSUED OR MAY PERTAIN, THE INSURANCE AFFORDED BY THE POLICIES DESCRIBED HEREIN IS SUBJECT TO ALL THE TERMS, EXCLUSIONS AND CONDITIONS OF SUCH POLICIES. LIMITS SHOWN MAY HAVE BEEN REDUCED BY PAID CLAIMS. ADDL SUBR TYPE OF INSURANCE POLICY EFF POLICY EXP (MM/DD/YYYY) (MM/DD/YYYY) **POLICY NUMBER** LIMITS Α X COMMERCIAL GENERAL LIABILITY ZHQ665536112 10/08/2021 10/08/2022 EACH OCCURRENCE \$1,000,000 X OCCUR CLAIMS-MADE DAMAGE TO RENTED PREMISES (Ea occurrence) \$100,000 MED EXP (Any one person) s 10,000

PERSONAL & ADV INJURY s 1,000,000 GEN'L AGGREGATE LIMIT APPLIES PER GENERAL AGGREGATE \$2,000,000 PRO-JECT POLICY LOC PRODUCTS - COMP/OP AGG \$2,000,000 OTHER: C TOMOBILE LIABILITY ABQ6656048 10/08/2021 10/08/2022 COMBINED SINGLE LIMIT (Ea accident) 1.000.000 ANY AUTO BODILY INJURY (Per person) OWNED AUTOS ONLY SCHEDULED AUTOS NON-OWNED BODILY INJURY (Per accident) X HIRED AUTOS ONLY PROPERTY DAMAGE **AUTOS ONLY** \$ (Per accident) s A X UMBRELLA LIAB X OCCUR UHQ665551912 10/08/2021 10/08/2022 EACH OCCURRENCE \$5,000,000 EXCESS LIAB CLAIMS-MADE AGGREGATE \$5,000,000 DED X RETENTION \$0 WORKERS COMPENSATION В WKQ6800981 AND EMPLOYERS' LIABILITY 10/08/2021 10/08/2022 X PER STATUTE OTH-ANY PROPRIETOR/PARTNER/EXECUTIVE N E.L. EACH ACCIDENT N/A \$500,000 (Mandatory in NH) If yes, describe under DESCRIPTION OF OPERATIONS below E.L. DISEASE - EA EMPLOYEE \$500,000 E.L. DISEASE - POLICY LIMIT \$500,000 Professional Lib LHQ948599910 10/08/2021 10/08/2022 Per Claim: \$1,000,000 Aggregate: \$2,000,000

DESCRIPTION OF OPERATIONS / LOCATIONS / VEHICLES (ACORD 101, Additional Remarks Schedule, may be attached if more space is required)

RE: Jordan Lumber Tract

If required by written contract, Jordan Lumber Tract is named as Additional Insured on the General Liability, subject to policy provisions.

CERTIFICATE HOLDER	CANCELLATION
Jordan Lumber Two, LLC 9096 Cool Springs Road Carthage, NC 28327	SHOULD ANY OF THE ABOVE DESCRIBED POLICIES BE CANCELLED BEFORE THE EXPIRATION DATE THEREOF, NOTICE WILL BE DELIVERED IN ACCORDANCE WITH THE POLICY PROVISIONS.
	AUTHORIZED REPRESENTATIVE
	Dariel J. Soul

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Tower Removal Bond

KNOW ALL PERSONS BY THESE PRESENTS: T	hat we Milestone Tower Limited Partnership IV
a sorporation daily organized under the laws of	the State of DF as Principal and
The Onlo Casually Histitatice Company	, as Surety, are held and firmly bound unto
County of Moore, North Carolina	as Obligae in the emanut of
Twenty Thousand Dollars and 00/100	(\$ 20,000.00) for the
successors and assigns, jointly and severally firmly	bind ourselves, our heirs, executors, administrators, by these presents, the liability of the Surety being
of the penal sum of this bond regardless of the	e number of years the bond is in effect.
Whereas, the Principal has obtained written approva of a wireless communication tower located at 0003428.3	I from the Obligee for the construction and erection mber fract 9096, Moore County Parcel ID 5.446442-79.415428, Cool Springs Road, Glendon, NC 27325
	HES WITH the maintenance replacement removed an
relocation of the tower from the aforementioned ad-	dress within 30 days upon receipt of prejeton mating
from the Obligee, to remove, replace, modify, or obligation is void otherwise to remain in full force and	relocate the tower from said memines the st.
1. It shall be a condition precedent to any rig	ht of recovery hereunder that in the event of any
detault of the part of the rincipal, a written	Statement of the narticular facts of such default shall
be, within Thirty (30) days, delivered to Surei 175 Berkeley Street, Boston, MA 02116	ty at it Home Office located at
by registered mail to the Surety and the	Surety shall not be obligated to perform Principals
obligation until sixty (00) days after Surety's	receint of such statement
or overnight courier service to 1048 Carriage	Oglo Pring Cottons No. 2007
(Obligee). Such termination shall not affect	t liability incurred under this obligation prior to the
checuve date of such termination.	
3. No action, suit, or proceeding shall be main	ntained against the Surety on this bond unless the
action is brought within twelve (12) months of 4. Regardless of the number of years this bond n	r the cancellation date of this bond. nay be renewed; in no event shall the liability of the
barety exceed the penal sum of this bond.	
5. It is understood that the non-renewal of this	bond by the Surety, or failure or inability of the
this bond.	constitute a loss recoverable by the Obligee under
-	
Signed, sealed, and witnessed this day of	February , 2022
	Milestone Tower Limited Partnership IV
	Principal
Metall	(emba =
rracorp.	Pro-
Witness	Ву:
MTY INSUR.	The Ohio Casualty Insurance Company
Sale Consultation of the C	Surety
(\frac{1}{2}\)	But All of Mile
WE CHAMPS !!	LeeAnne K. Michaud Attorney-In-Fact
	, Auothey-m-ract

Surety Phone No. 617-357-9500

This Power of Attorney limits the acts of those named herein, and they have no authority to bind the Company except in the manner and to the extent herein stated. Not valid for mortgage, note, loan, letter of credit, bank deposit, currency rate, interest rate or residual value guarantees. For bond and/or Power of Attorney (POA) verification inquiries, please call 610-832-8240 or email HOSUR@libertymutual.com



Liberty Mutual Insurance Company The Ohio Casualty Insurance Company West American Insurance Company

POWER OF ATTORNEY

KNOWN ALL PERSONS BY THESE PRESENTS: That The Ohio Casualty Insurance Company is a corporati Mutual Insurance Company is a corporation duly organized under the laws of the State of Massachusetts, an the laws of the State of Indiana (herein collectively called the "Companies"), pursuant to and by authority here of the city of Columbia, state of MD its true and lawful attorney-in-fact, with full power an surety bond:	id West American Insurance Company is a corporation duly organized under
Principal Name: Milestone Tower Limited Partnership IV	
Obligee Name: County of Moore, North Carolina	
Surety Bond Number: 017249667	Bond Amount: See Bond Form
IN WITNESS WHEREOE this Power of Attendoubles have been been a	

IN WITNESS WHEREOF, this Power of Attorney has been subscribed by an authorized officer or official of the Companies and the corporate seals of the Companies have been affixed thereto this 12th day of March, 2021







The Ohio Casualty Insurance Company Liberty Mutual Insurance Company West American Insurance Company

David M. Carey, Assistant Secretary

STATE OF PENNSYLVANIA COUNTY OF MONTGOMERY

SS

On this 12th day of March, 2021, before me personally appeared David M. Carey, who acknowledged himself to be the Assistant Secretary of Liberty Mutual Insurance Company, The Ohio Casualty Company, and West American Insurance Company, and that he, as such, being authorized so to do, execute the foregoing instrument for the purposes therein contained by signing on behalf of the corporations by himself as a duly authorized officer

IN WITNESS WHEREOF, I have hereunto subscribed my name and affixed my notarial seal at King of Prussia. Pennsylvania. on the day and year first above written.



Commonwealth of Pennsylvania - Notary Seal Teresa Pastella, Notary Public Montgomery County My commission expires March 28, 2025 Commission number 1126044

By: Teresa Pastella
Teresa Pastella, Notary Public

Member, Pennsylvania Association of Notaries

This Power of Attorney is made and executed pursuant to and by authority of the following By-laws and Authorizations of Liberty Mutual Insurance Company. The Ohio Casualty Insurance Company, and West American Insurance Company which resolutions are now in full force and effect reading as follows:

ARTICLE IV - OFFICERS - Section 12. Power of Attorney. Any officer or other official of the Corporation authorized for that purpose in writing by the Chairman or the President, and subject to such limitation as the Chairman or the President may prescribe, shall appoint such attorneys-in-fact, as may be necessary to act in behalf of the Corporation to make, execute, seal, acknowledge and deliver as surety any and all undertakings, bonds, recognizances and other surety obligations. Such attorneys-in-fact, subject to the limitations set forth in their respective powers of attorney, shall have full power to bind the Corporation by their signature and execution of any such instruments and to attach thereto the seal of the Corporation. When so executed, such instruments shall be as binding as if signed by the President and attested to by the Secretary. Any power or authority granted to any representative or attorneyin-fact under the provisions of this article may be revoked at any time by the Board, the Chairman, the President or by the officer or officers granting such power or authority

ARTICLE XIII - Execution of Contracts - SECTION 5. Surety Bonds and Undertakings. Any officer of the Company authorized for that purpose in writing by the chairman or the president. and subject to such limitations as the chairman or the president may prescribe, shall appoint such attorneys-in-fact, as may be necessary to act in behalf of the Company to make, execute, seal, acknowledge and deliver as surety any and all undertakings, bonds, recognizances and other surety obligations. Such attorneys-in-fact subject to the limitations set forth in their respective powers of attorney, shall have full power to bind the Company by their signature and execution of any such instruments and to attach thereto the seal of the Company. When so executed such instruments shall be as binding as if signed by the president and attested by the secretary

Certificate of Designation - The President of the Company, acting pursuant to the Bylaws of the Company, authorizes David M. Carey, Assistant Secretary to appoint such attorneys infact as may be necessary to act on behalf of the Company to make, execute, seal, acknowledge and deliver as surety any and all undertakings, bonds, recognizances and other surety

Authorization - By unanimous consent of the Company's Board of Directors, the Company consents that facsimile or mechanically reproduced signature of any assistant secretary of the Company, wherever appearing upon a certified copy of any power of attorney issued by the Company in connection with surety bonds, shall be valid and binding upon the Company with the same force and effect as though manually affixed

I, Renee C. Llewellyn, the undersigned. Assistant Secretary, of Liberty Mutual Insurance Company. The Ohio Casualty Insurance Company, and West American Insurance Company do hereby certify that this power of attorney executed by said Companies is in full force and effect and has not been revoked.

IN TESTIMONY WHEREOF. I have hereunto set my hand and affixed the seals of said Companies this 9th day of February







Renee C. Llewellyn, Assistant Secretary

2022

WIRELESS NETWORK CONSULTING

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LLC

Jordan Lumber - Milestone Towers

TOWER HEIGHT ANALYSIS

Proposed Site


- [†] 255' Self Support Tower
 - 734 Cool Springs Road Carthage, NC 28327
 - Latitude: 35.44644 N (NAD83)
 - Longitude: -79.41543 W (NAD83)
 - Ground Elevation: 253' (NAVD88)
 - Anchor tenant is Verizon
 - Antenna Centerline at 250' AGL

Why a taller site?


- Radio Frequencies in the Commercial Wireless space operate on line of site.
- The higher the antennas above the ground the larger the area of coverage
- There is significant distance between the proposed site and the neighbors due to the rural environment
- A taller site is needed to provide enough coverage to overlap with neighbor sites
- Other towers in the area are over 300' AGL

Colocation Heights

- If a 195' AGL tower is all that is allowed, it will increase the need for additional sites in the county to provide coverage
- The 195' height would place the lowest potential commercial wireless mounting height at 160' AGL
- Lower heights mean that more towers will be needed for the carriers on the (2) lower platforms
- There would be a need for additional towers within a distance of 2 miles

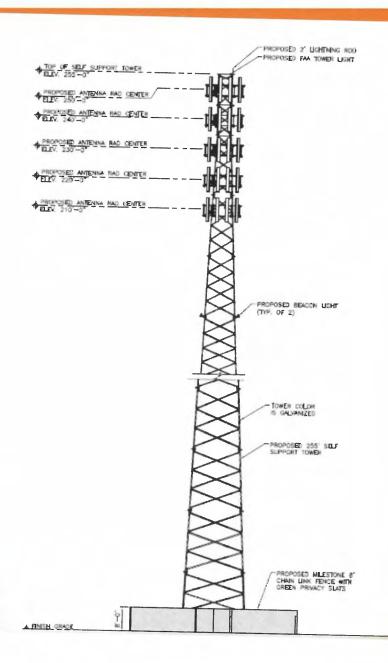


Surrounding Tower Locations

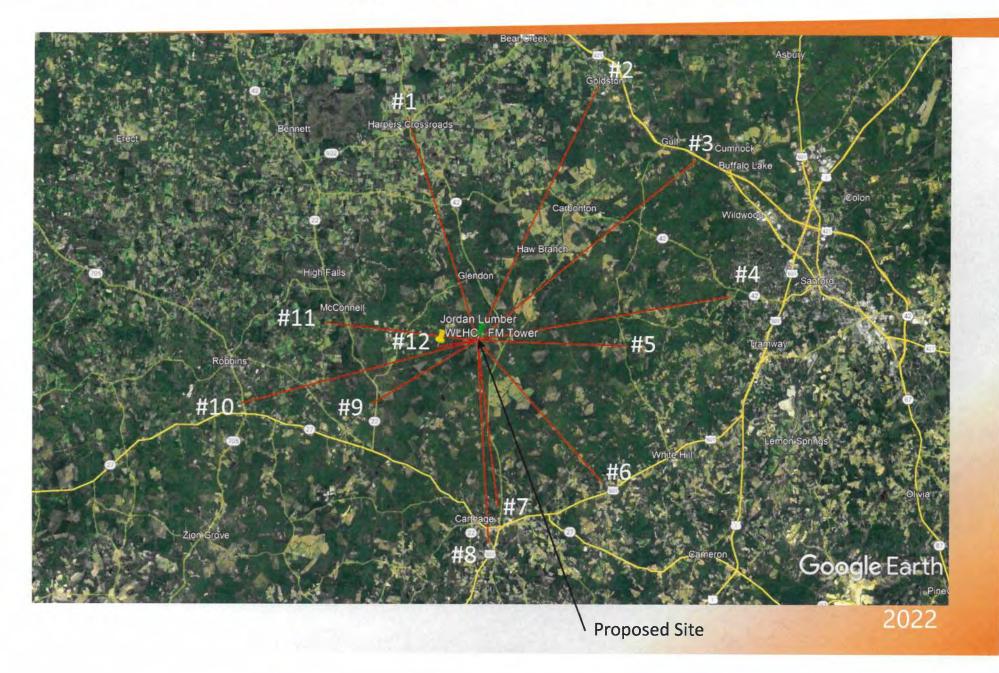


Surrounding Tower Locations


```
#1 – 9.13 miles – Chatham County – 300' AGL
#2 – 10.91 miles – Chatham County – 300' AGL
#3 - 11.02 miles - SBA Towers - 300' AGL
 #4 - 9.98 miles - ATC Towers - 251' AGL
#5 - 5.88 miles - WFJA FM - 497' AGL
#6 - 7.73 miles - CCATT LLC - 300' AGL
#7 - 6.49 miles - NC Highway Patrol - 340' AGL
#8 - 7.85 miles - ATC Towers - 402' AGL
#9 – 4.48 miles – US Cellular – 250' AGL
#10 - 9.52 miles - ATC Towers - 300' AGL
#11 - 5.98 miles - ATC Towers - 300' AGL
#12 - 1.58 miles - WLHC FM - 385' AGL
```


Terrain impact on coverage

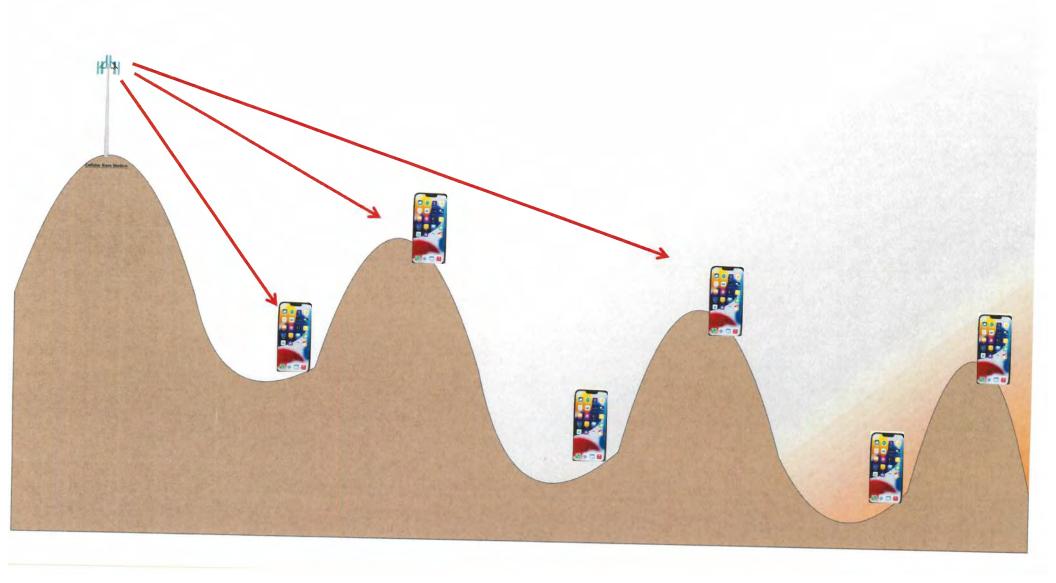

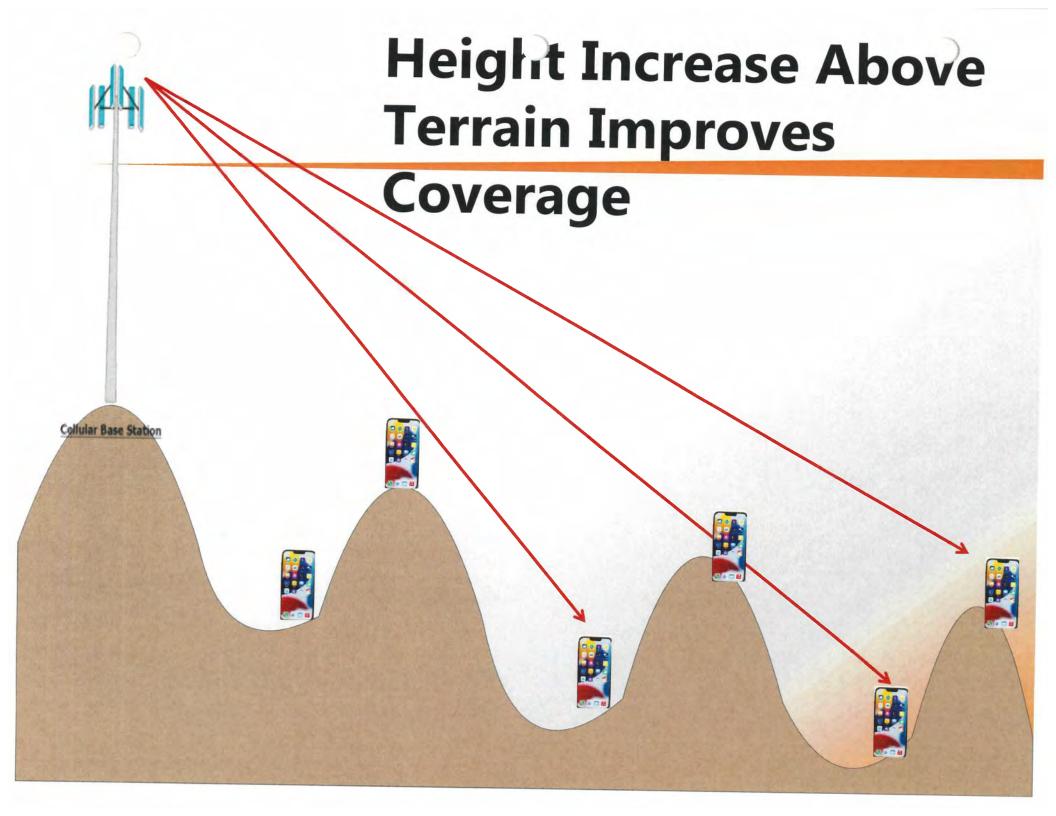



RSRP Coverage - Current

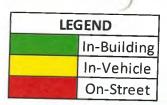

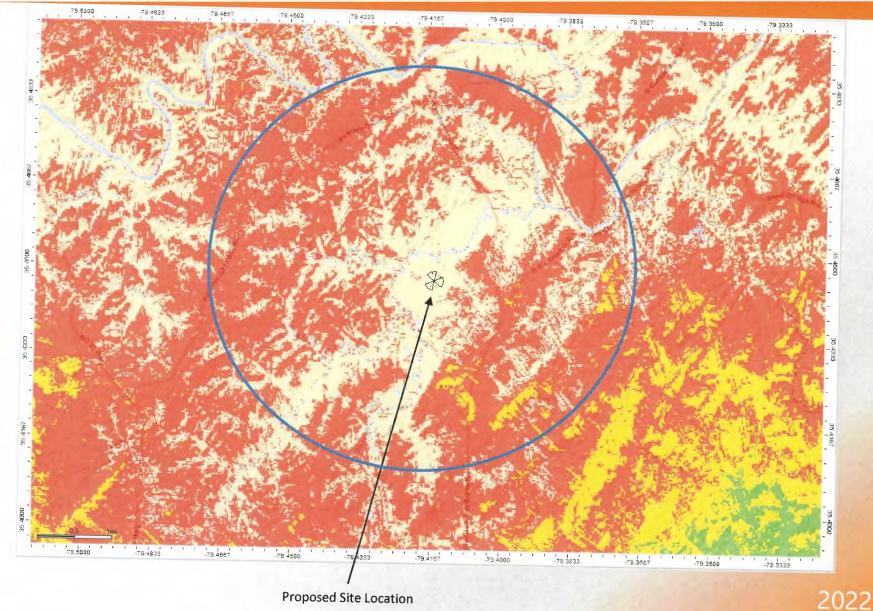

RSRP Coverage – 250'

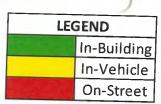


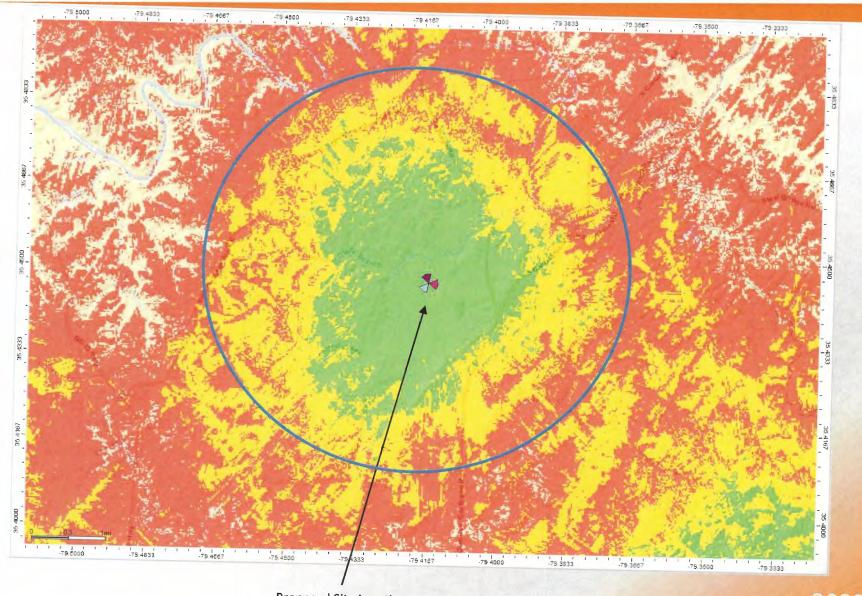


Proposed Site Location


2022


RSRP Coverage – 190'

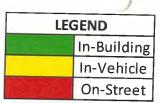

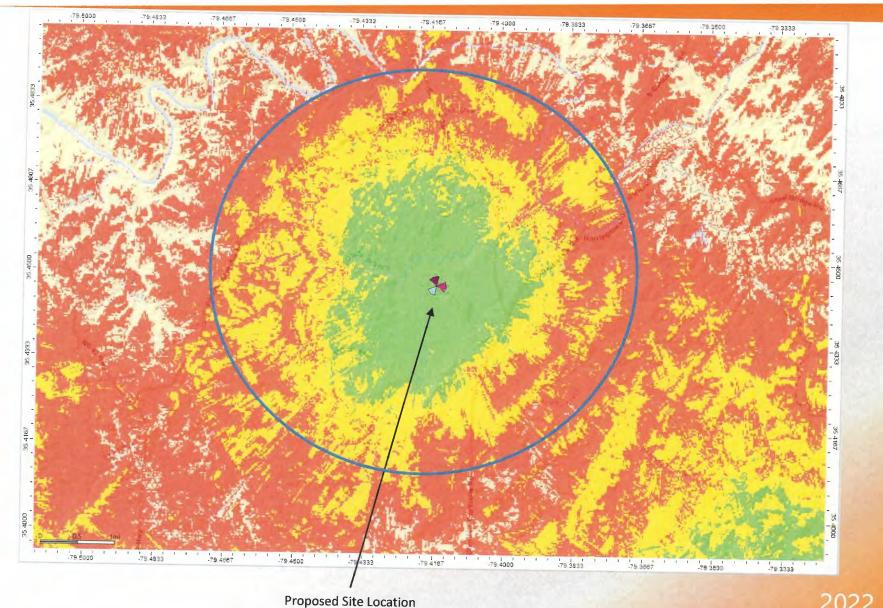

RSRP Coverage – 150'

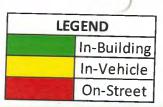

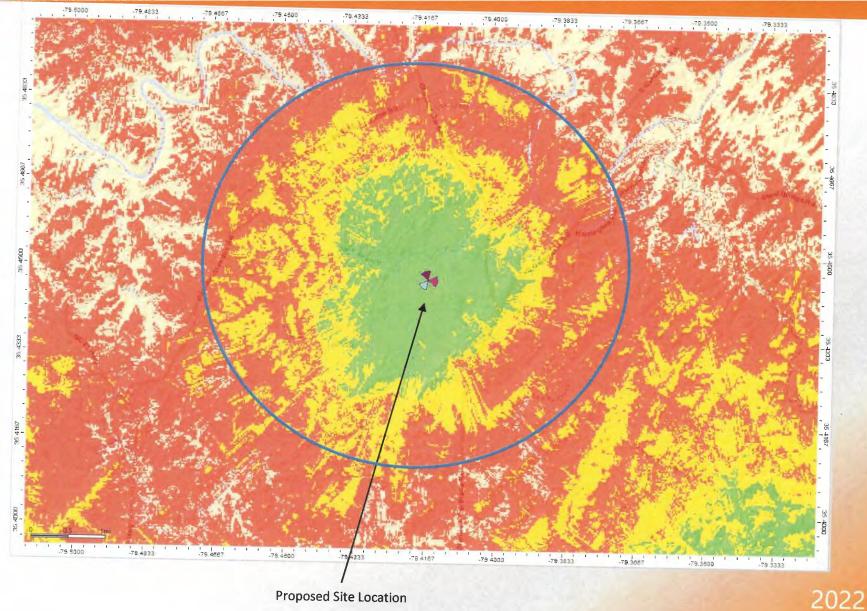

WIRELESS NETWORK CONSULTING

Jordan Lumber – Milestone Towers

RF DESIGN ANALYSIS



Coverage vs Capacity

- Capacity is providing bandwidth or processing capacity to service the customers in the area.
 - Areas where large numbers of users are in a specific geographic areas
 - Areas where users are demanding higher data rates for services
 - Areas with a large amount of indoor users
- Coverage is Providing Service where service does not exist, calls drop, or "no service".
 - Areas where there are farther apart
 - Areas where terrain or buildings block signals
 - Areas where indoor service is low or nonexistent

Proposed Site

- † 255' Self Support Tower
 - 734 Cool Springs Road Carthage, NC 28327
 - Latitude: 35.44644 N (NAD83)
 - Longitude: -79.41543 W (NAD83)
 - Ground Elevation: 253' (NAVD88)
 - Anchor tenant is Verizon
 - Antenna Centerline at 250' AGL

Why here?

- Poor coverage in and around S Carbonton Road and Glendon Carthage Road.
- The need to be located close to the intersection of those two roads and provide service North and South along those roads
- The area has low throughput for not only Verizon but other carriers as well

Objective of new site

Coverage

- Provide additional capacity and coverage S Carbonton Road and Glendon Carthage Road
- Provide coverage in the rural area surrounding the above named roads

Why is this site important?

- 96% of Americans own a Cellular Phone
- 57% of American Homes rely exclusively on cellular phones
- 84% or more of 9-1-1 emergency calls are made from wireless devices

Ionizing vs Non-Ionizing

- There are two (2) types of Energy/Radio Waves
 - Ionizing
 - These are waves that can effect human DNA
 - Examples are:
 - Gamma rays
 - X-Rays
 - This is one of the reasons the nurse steps out of the room and you wear a lead overcoat when you get X-Rays at the dentist.
 - Non- Ionizing
 - These are waves do not effect human DNA
 - Examples are:
 - Car Radios
 - Television
 - Wi-Fi Access points and routers
 - Bluetooth headsets
 - Cellphones and Smartphones
 - Lightbulbs
 - Wireless Baby Monitors
 - TV remotes
 - Absorption of waves is proximity based, the closer you are to the antenna the more non-ionizing energy is absorbed. You will absorb 50% of the FCC's General Public limit with your smartphone next to your ear versus less than 10% of the FCC's General Public limit from the antennas when you are standing 20' away from the proposed tower.
 - The further you walk away from the tower it decreases even more.


General Public & Occupational limits

- The FCC isolated two (2) groups relative to access around wireless antennas
- † The first group is called Occupational
 - This refers to areas where workers would be allowed (general public cannot access) but the workers would not have knowledge about antennas (An example would be an Air Conditioner Repair Technician). Barriers or signage may be needed to alert the worker when close to the antennas.
 - Examples are:
 - Rooftop access behind a locked door
 - Compound access behind a locked gate
 - The FCC determined the safe value and then lowered by a factor of 10 and that is the value the wireless carriers use in the studies
 - The exposure levels are averaged over 6 minutes


The second group is called General Public

- Uncontrolled access (General Public)
 - This group is for areas with general public access, the public would not have a knowledge of an antenna being close to them
 - Examples are:
 - Sidewalks
 - Parks
 - Public accessed buildings
- The FCC determined the safe value and then lowered by a factor of 50 and that is the value the wireless carriers use in the studies
- The exposure levels are averaged over 30 minutes
- Compare the value for a tower which is 1mW to the power of a smartphone which is 200mW of power.

Sites

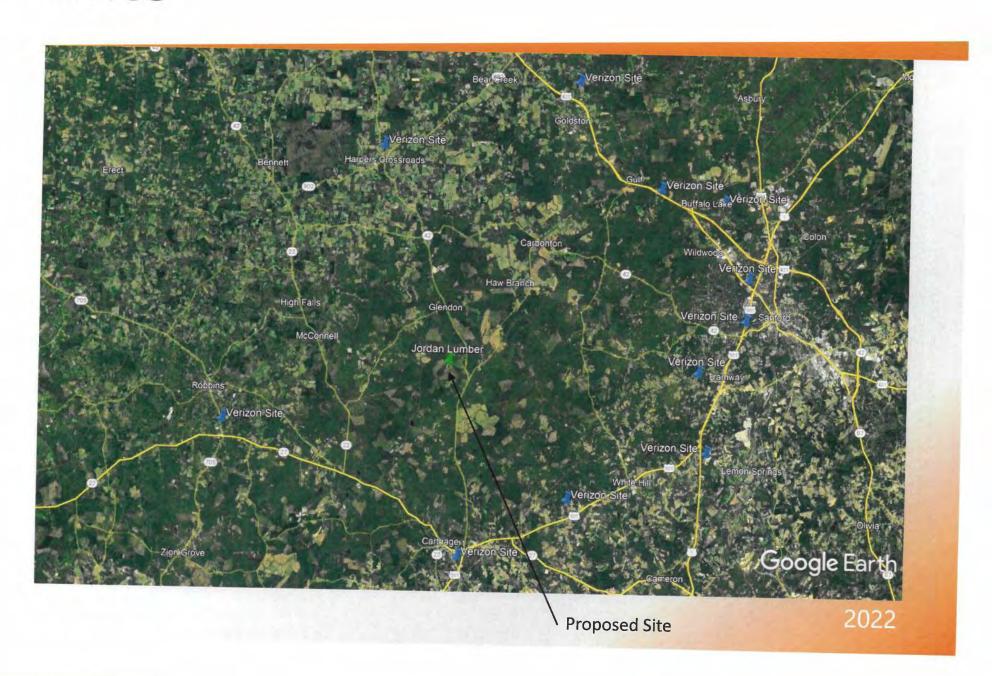

Surrounding Tower Locations

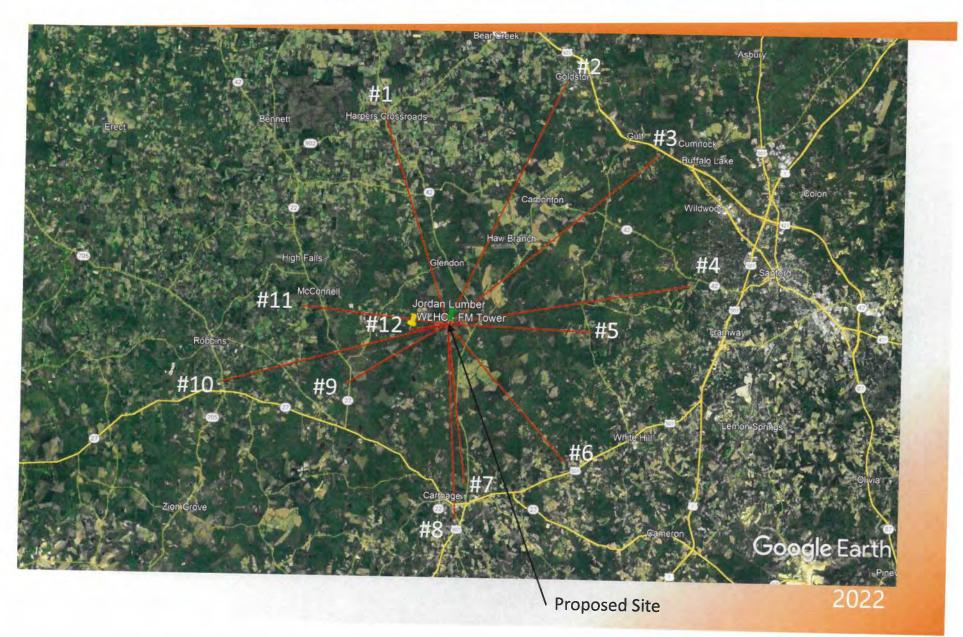

Surrounding Tower Locations

```
#1 – 9.13 miles – Chatham County – 300' AGL
  #2 - 10.91 miles - Chatham County - 300' AGL
† #3 – 11.02 miles – SBA Towers – 300' AGL
#4 - 9.98 miles - ATC Towers - 251' AGL
#5 - 5.88 miles - WFJA FM - 497' AGL
#6 - 7.73 miles - CCATT LLC - 300' AGL
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#10 - 9.52 miles - ATC Towers - 300' AGL
#11 - 5.98 miles - ATC Towers - 300' AGL
#12 - 1.58 miles - WLHC FM - 385' AGL
```

RootMetrics – Coverage Map



- Area showing bad, poor and fair coverage around the proposed site location
- Data collected by RootMetrics drive test vehicles and end users
- Source:
 <u>https://webcoveragemap.r</u>
 <u>ootmetrics.com/en-US</u>


RootMetrics - Throughput Map



- Large area where mobiles cannot connect along Hwy 1006 and slow throughput
 - Data collected by RootMetrics drive test vehicles and end users
- Source:


https://webcoveragemap.rootmetrics.com/en-US

CellMapper.net - Coverage Map

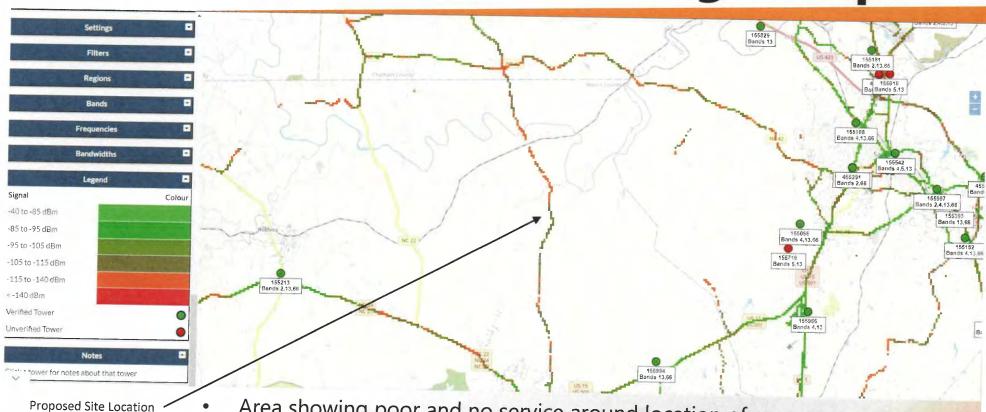

- Area showing poor and no service around location of proposed site
- Data collected by Cellmapper.net Crowdsource data from end users
- Source: https://www.cellmapper.net/

Open Signal – Quality Map

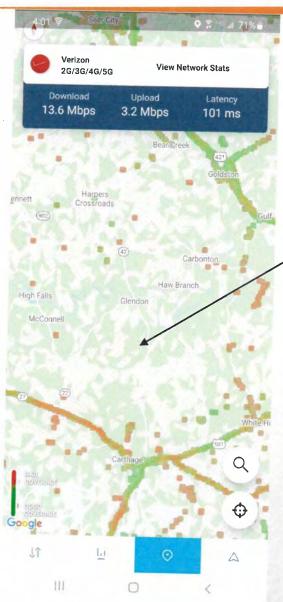

This map show mobiles reporting quality of their connections to the network. This is crowdsource data from Verizon users made available by the OpenSignal App:

https://www.opensignal.com/apps#section-osapp

Green data points show good coverage and Red data points show bad coverage

Note the lack of mobiles being able to make connection to report in the area

Open Signal – Quality Map T-Mobile and AT&T




These maps show mobiles reporting quality of their connections to the network. This is crowdsource data from T-Mobile and AT&T users made available by the OpenSignal App:


https://www.opensignal.com/apps#section-os-app


Green data points show good coverage and Red data points show bad coverage

Notice that both maps zoomed in on the area (left –T-Mobile, right AT&T show that both T-Mobile and AT&T have a significant portion of the users cannot connect. It also shows that the other carriers may be open to locating on the tower as well.

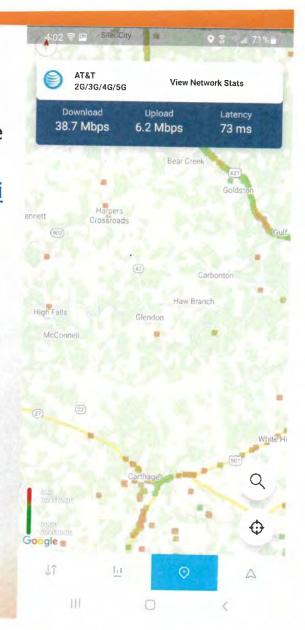

RSRP Coverage - Current

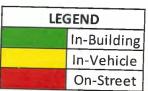


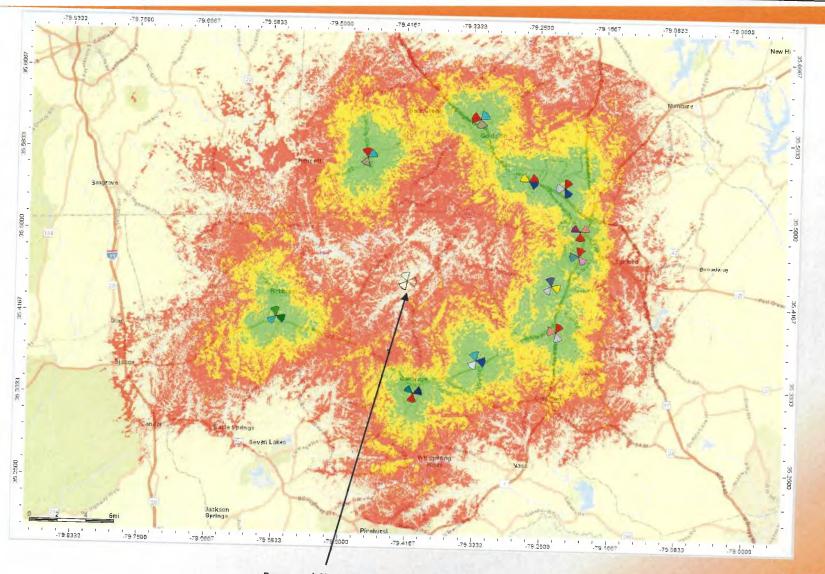


Proposed Site Location

2022

RSRP Coverage - Proposed

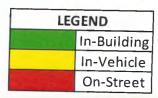


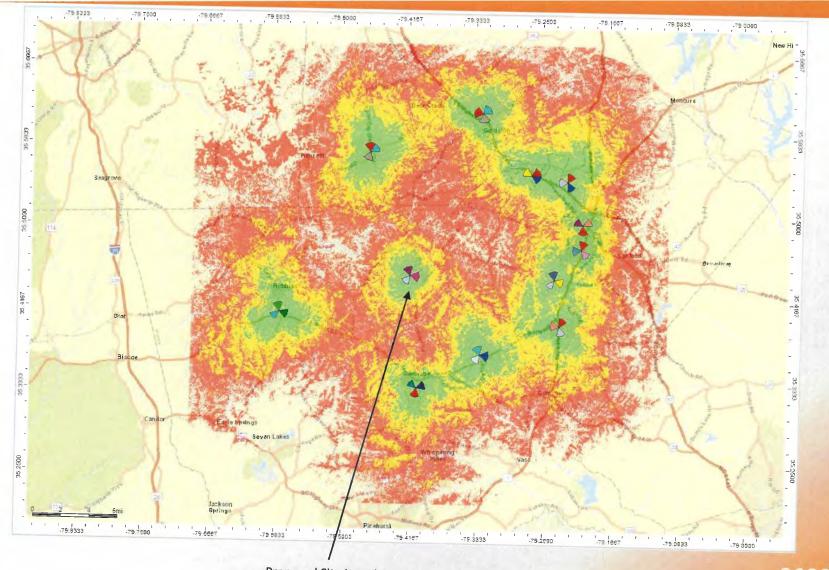


Proposed Site Location

2022

Best Server - Current

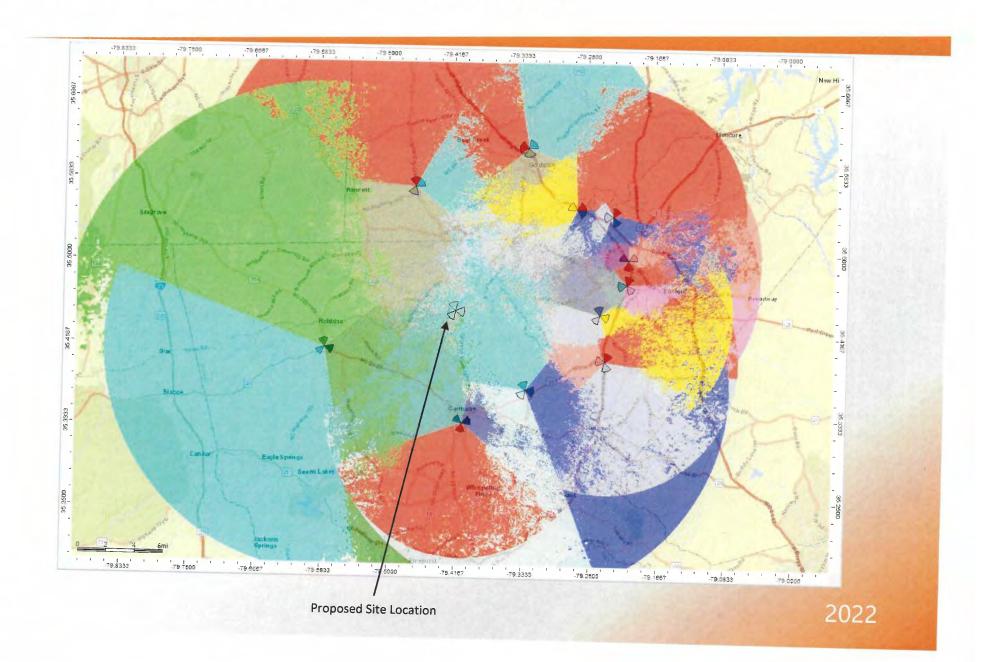

RSRP Coverage - Proposed

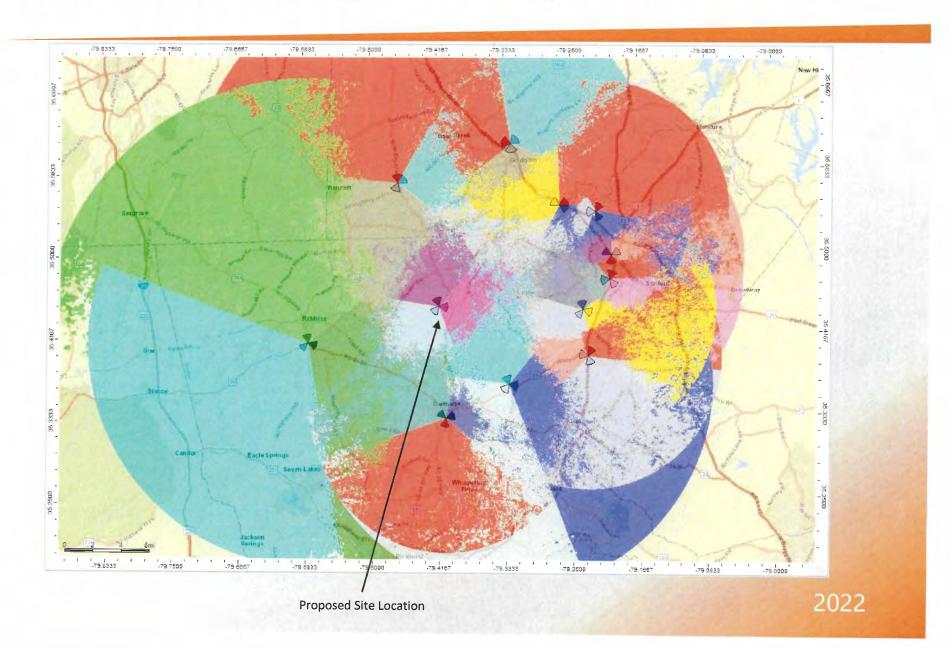



SITE NAME: JORDAN LUMBER STRUCTURE TYPE: 255' SELF SUPPORT TOWER verizon^v

PREPARED FOR




MILESTONE TOWERS 12110 SUNSET HILLS ROAD #600 RESTON, VA 20190

SITE NAME:

JORDAN LUMBER

SITE ADDRESS: COOL SPRINGS RD CARTHAGE, NC 28327 MOORE COUNTY

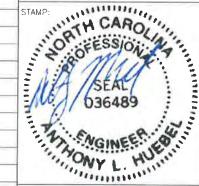



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SHEET TITLE

COVER SHEET

SHEET NUMBER:

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PROJECT INFORMATION **DRIVING DIRECTIONS** SITE NAME: JORDAN LUMBER FROM RALEIGH-DURHAM INTERNATIONAL AIRPORTS E911 ADDRESS: COOL SPRINGS RD GET ON 1-40 W FROM AIRPORT BLVD 6MIN(2.9MI) / CARTHAGE, NC 28327 FOLLOW NC-540 W AND US-1 S TO NC-42 W/WICKER ST IN SANFORD TAKE EXIT 66 FROM 35 446442" (35' 26' 47 19"N) US-1 S 36MIN(41.6MI) / TAKE STEEL BRIDGE RD TO COOL SPRINGS RD IN MOORE COUNTY LONGITUDE: ~79.415428' (79' 24' 55.54"W) 21MIN(15MI) / DESTINATION WILL BE ON THE RIGHT. GROUND ELEVATION: 253' AMSL JURISDICTION: MOORE COUNTY STRUCTURE TYPE: 255' SELF SUPPORT TOWER PARCEL ID/PIN: 00003428/86700671721 PARENT PARCEL: 72.35 ACRES TOTAL LEASE AREA: 0:13 ACRES ACCESS/UTILITY EASEMENT: 0.24 ACRES

SCOPE OF WORK THE WIRELESS COMMUNICATIONS FACILITY IS NOT INTENDED FOR

INSTALLATION OF NEW WIRELESS COMMUNICATION FACILITY, 70 X70' FENCED COMPOUND WITH 255' SELF SUPPORT TOWER AND ELECTRICAL SERVICE DEMARC FOR FUTURE

APPLICANT:

MILESTONE TOWERS LIMITED PARTNERSHIP IV D/B/A MILESTONE TOWER 12110 SUNSET HILLS ROAD #600 RESTON, VA 20190

CONTACTS

PROPERTY OWNER:

JORDAN TWO, LLC MOUNT GILEAD, NC 27306

PROJECT MANAGER:

MATT PENNING DIRECTOR OF DEVELOPMENT

12110 SUNSET RD #600,

PHONE: (703) 865-4697

RESTON, VA 20190

APPLICABLE CODES & STANDARDS

- 2018 NORTH CAROLINA BUILDING CODE
- ANSI/TIA-222-G-2-2009

CURRENT ZONING: RA

- 2017 NC ELECTRICAL CODE (2017 NEC) 2018 NORTH CAROLINA ENERGY CONSERVATION CODE
- CITY/COUNTY ORDINANCES

ARCHITECT/ENGINEER:

EMAIL: matt@milestonetowers.com

MOUNTAIN LTD ENGINEERING 20008 CHAMPION FOREST DR., STE 1203 SPRING, TX 77379 CONTACT: TONY HUEBEL EMAIL: thuebel@mountainItd.com



POWER COMPANY:

DUKE ENERGY PHONE: (800) 777-9898



SITE ACCESS PROCEDURES

AERIAL MAP

N1.0 GENERAL NOTES N1.1 GENERAL NOTES N1.2 GENERAL NOTES N1.3 APPENDIX B N1_4 APPENDIX B ARCHITECTURAL / CIVIL PLANS SITE SURVEY (BY OTHERS) A0_0 OVERALL SITE PLAN OVERALL SITE PLAN W/ AERIAL IMAGE A0.2 PROPOSED GRADING & EROSION CONTROL PLAN A1-0 COMPOUND PLAN A2.0 TOWER ELEVATION

A3_0

A3_1

A3 2

A3_3

T1.0

SHEET INDEX

DRAWING SCALES ARE FOR 22"X34" SHEETS UNLESS OTHERWISE

SITE GENERAL ARRANGEMENT PLANS

COVER SHEET

SITE DETAILS

FENCE DETAILS

SILT FENCE DETAILS


SIGNAGE DETAILS

NOTED

VICINITY MAP

LINE AND SYMBOL LEGEND

TRANSFORMER

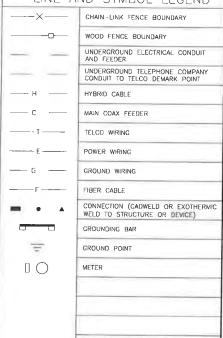

1.0 GENERAL REQUIREMENTS:

1.1 PURPOSE AND INTENTS

- A. THE DRAWINGS AND SPECIFICATIONS ARE INTENDED TO BE FULLY EXPLANATORY AND SUPPLEMENTARY HOWEVER, SHOULD ANYTHING BE SHOWN, INDICATED OR SPECIFIED ON ONE AND NOT THE OTHER, IT SHALL BE DONE THE SAME AS IF SHOWN, INDICATED OR SPECIFIED IN BOTH, SHOULD THERE BE ANY DISCREPANCIES BETWEEN REQUIREMENTS SHOWN IN BOTH, THE MORE STRINGENT REQUIREMENTS SHALL
- B. THE INTENTION OF THE DOCUMENTS IS TO INCLUDE ALL LABOR AND MATERIALS REASONABLY NECESSARY FOR THE PROPER EXECUTION AND COMPLETION OF THE WORK AS STIPULATED IN THE CONTRACT
- THE PURPOSE OF THE CONSTRUCTION SPECIFICATIONS IS TO INTERPRET THE INTENT OF THE DRAWINGS AND TO DESIGNATE THE METHOD OF THE PROCEDURE, TYPE AND QUALITY OF MATERIALS REQUIRED TO COMPLETE THE WORK

1.2 CONFLICTS:

- VERIFY ALL MEASUREMENTS AT THE SITE BEFORE ORDERING MATERIAL OR DOING ANY WORK, NO EXTRA CHARGE OR COMPENSATION WILL BE ALLOWED DUE TO DIFFERENCES BETWEEN ACTUAL DIMENSIONS OR DIMENSIONS SHOWN ON PLANS SUBMIT NOTICE OF ANY DISCREPANCY IN DIMENSIONS OR OTHERWISE TO TOWER OWNER FOR RESOLUTION BEFORE PROCEEDING WITH THE WORK:
- NO PLEA OF IGNORANCE OF CONDITIONS THAT EXIST OR OF DIFFICULTIES OF CONDITIONS THAT MAY BE ENCOUNTERED, OR OF ANY OTHER RELEVANT MATTER CONCERNING THE EXECUTION OF THE WORK WILL BE ACCEPTED AS AN EXCUSE FOR ANY FAILURE OR OMISSION ON THE PART OF THE CONTRACTOR TO FULFILL EVERY DETAIL OF ALL THE REQUIREMENTS OF THE CONSTRUCTION DOCUMENTS GOVERNING THE WORK

1.3 CLEANING:

KEEP THE SITE FREE FROM ACCUMULATION OF WASTE AND RUBBISH CAUSED BY EMPLOYEES AT THE COMPLETION OF THE WORK. REMOVE ALL WASTE AND NON-CONSTRUCTION MATERIAL INCLUDING ALL CONTRACTOR TOOLS AND SURPLUS MATERIAL AND LEAVE SITE CLEAN AND READY FOR USE

1.4 CODES:

CONTRACTOR SHALL BE RESPONSIBLE FOR FOLLOWING ALL LAWS, REGULATIONS AND RULES PROMULGATED BY FEDERAL STATE AND LOCAL AUTHORITIES WITH JURISDICTION OVER THE SITE, THIS RESPONSIBILITY IS IN EFFECT REGARDLESS OF WHETHER THE LAW, ORDINANCE, REGULATION OR RULE IS MENTIONED IN THESE

1.5 LICENSING:

HAVE AND MAINTAIN A VALID CONTRACTORS LICENSE FOR THE LOCATION IN WHICH THE WORK IS TO BE PERFORMED FOR JURISDICTIONS THAT LICENSE INDIVIDUAL TRADES, THE TRADESMAN OR SUBCONTRACTORS PERFORMING THOSE TRADES SHALL BE LICENSED RESEARCH AND COMPLY WITH LICENSING LAWS. PAY LICENSE FEES, AND SELECT AND INFORM SUBCONTRACTORS REGARDING THESE LAWS

FOLLOW ALL APPLICABLE RULES AND REGULATIONS OF THE OCCUPATIONAL SAFETY AND HEALTH ADMINISTRATIONS, AND STATE LAWS BASED IN THE FEDERAL OCCUPATIONAL SAFETY AND HEALTH ACT THESE REGULATIONS INCLUDE BUT ARE NOT LIMITED TO REGULATIONS DEALING WITH TOWER CONSTRUCTION AND SAFETY, EXCAVATIONS AND TRENCHING, AND WORK IN CONFINED SPACES. ENSURE THAT EMPLOYEES AND SUBCONTRACTORS WEAR HARD HATS AT All TIMES DURING CONSTRUCTION.

1_7 PHOTOS:

PROVIDE PHOTOGRAPHIC EVIDENCE OF ALL SCOPE RELATED WORK, INCLUDING BUT NOT LIMITED TO GROUNDING AND TRENCHING AFTER PLACEMENT OF UTILITIES PRIOR TO BACKFILL

1.8 BUILDING PERMITS:

TOWER OWNER WILL SUBMIT CONSTRUCTION DOCUMENTS TO THE JURISDICTIONAL AUTHORITY FOR PLAN CHECK AND REVIEW CONTRACTOR WILL SUBMIT LICENSING AND WORKMAN'S COMPENSATION INFORMATION TO THE JURISDICTION AS REQUIRED TO OBTAIN THE BUILDING PERMIT. CONTRACTOR SHALL COORDINATE AND SCHEDULE REQUIRED INSPECTIONS AND POST REQUIRED PERMITS AT THE JOB SITE, COMPLY WITH SPECIFIC PROJECT-RELATED REQUESTS AND SUGGESTIONS MADE BY BUILDING INSPECTOR AND INFORM CONSTRUCTION MANAGER OF ANY SUCH WORK THAT MAY BE BEYOND THE SCOPE OF THE CONTRACT OR DEVIATE FROM THE CONSTRUCTION DOCUMENTS:

1.9 ZONING REGULATIONS AND CONDITIONAL USE PERMITS:

TOWER OWNER WILL SUBMIT FOR AND OBTAIN ALL ZONING AND CONDITIONAL USE PERMITS. SOME USE PERMITS MAY HAVE SPECIFIC REQUIREMENTS RELATED TO THE CONSTRUCTION SUCH AS NOISE REGULATIONS, HOURS OF WORK, ACCESS LIMITATIONS, ETC. THE CONSTRUCTION MANAGER WILL INFORM THE CONTRACTOR OF THESE REQUIREMENTS AT THE PRE-BID MEETING OR AS SHOWN IN CONSTRUCTION DOCUMENTS

1 10 TOWER SECURITY:

JOB SITE MUST BE FENCED, TEMPORARILY OR PERMANENTLY WITHIN 24 HOURS OF ERECTION. DO NOT ALLOW THE GATE ACCESSING THE TOWER AREA TO REMAIN OPEN OR UNATTENDED AT ANY TIME FOR ANY REASON, KEEP THE GATE CLOSED AND LOCKED WHEN NOT IN USE

1 12 SITE CONTROL:

- THE CONTRACTOR IS COMPLETELY RESPONSIBLE FOR CONTAINMENT OF SEDIMENT AND CONTROL OF EROSION AT THE SITE. ANY DAMAGE TO ADJACENT OR DOWNSTREAM PROPERTIES WILL BE CORRECTED BY THE CONTRACTOR AT NO EXPENSE TO TOWER OWNER.
- THE CONTRACTOR IS TO MAINTAIN ADEQUATE DRAINAGE AT ALL TIMES. DO NOT ALLOW WATER TO STAND OR POND ANY DAMAGE TO STRUCTURES OR WORK ON THE SITE CAUSED BY INADEQUATE MAINTENANCE OF DRAINAGE PROVISIONS WILL BE THE RESPONSIBILITY OF THE CONTRACTOR AND ANY COST ASSOCIATED WITH REPAIRS FOR SUCH DAMAGE WILL BE AT THE CONTRACTOR'S EXPENSE.
- ALL WASTE MATERIAL SHALL BE PROPERLY DISPOSED OF OFF-SITE OR AS DIRECTED BY THE CONSTRUCTION MANAGER AND IN ACCORDANCE WITH JURISDICTIONAL AUTHORITIES

2.0 SITE PREPARATION:

2.1 SCOPE OF WORK INCLUDES:

- PROTECTION OF EXISTING TREES, VEGETATION AND LANDSCAPING MATERIALS WHICH MIGHT BE DAMAGED BY CONSTRUCTION ACTIVITIES
- TRIMMING OF EXISTING TREES AND VEGETATION AS REQUIRED FOR PROTECTION DURING CONSTRUCTION ACTIVITIES
- CLEARING AND GRUBBING OF STUMPS, VEGETATION, DEBRIS, RUBBISH, DESIGNATED TREES, AND SITE **IMPROVEMENTS**
- D TOPSOIL STRIPPING AND STOCKPILING
- TEMPORARY EROSION CONTROL, SILTATION CONTROL AND DUST CONTROL CONFORMING TO LOCAL REQUIREMENTS AS APPLICABLE
- F. TEMPORARY PROTECTION OF ADJACENT PROPERTY, STRUCTURES, BENCHMARKS AND MONUMENTS
- PROTECTION AND TEMPORARY RELOCATION, STORAGE AND RE-INSTALLATION OF DUSTING FENCING AND OTHER SITE IMPROVEMENTS SCHEDULED FOR REUSE
- H. REMOVAL AND LEGAL DISPOSAL OF CLEARED MATERIALS.
- 2.2 PRODUCTS AND MATERIALS (AS APPROVED BY CONSTRUCTION MANAGER OR AS NOTED III CONSTRUCTION DOCUMENTS)
- A MATERIALS USED FOR TREE PROTECTION, EROSION CONTROL, SILTATION CONTROL AND DUST CONTROL AS SUITABLE FOR SPECIFIC SITE CONDITIONS.

3.0 EARTH WORK:

3.1 SCOPE OF WORK INCLUDES:

- A. EXCAVATION, TRENCHING, FILLING, COMPACTION, AND GRADING FOR STRUCTURES, SITE IMPROVEMENTS AND
- MATERIALS FOR SUB-BASE DRAINAGE FILL, FILL, BACKFILL AND GRAVEL FOR SLABS, PAVEMENTS AND IMPROVEMENTS.
- C. ROCK EXCAVATION WITHOUT BLASTING.
- D. SUPPLY OF ADDITIONAL MATERIALS FROM OFFSITE AS REQUIRED.
- E. REMOVAL AND LEGAL DISPOSAL OF EXCAVATED MATERIALS AS REQUIRED.

3.2 QUALITY ASSURANCE:

A. COMPACTION:

- 1_ UNDER STRUCTURES, BUILDING SLABS, PAVEMENTS AND WALKWAYS WILL OBTAIN A 95 PERCENT COMPACTION AT A MAXIMUM DRY DENSITY AS DETERMINED BY ASTM 0-1557 OR WITHIN PLUS OR MINUS 3 PERCENT OF OPTIMUM MOISTURE
- B GRADING TOLERANCES OUTSIDE BUILDING CODES:
 - 1. LAWNS, UNPAVED AREAS AND WALKS PLUS OR MINUS 1 INCH.
 - 2. UNDER PAVEMENTS PLUS OR MINUS 1/2 INCH.
- C. GRADING TOLERANCE FOR FILL UNDER ALL CONCRETE APPLICATIONS: PLUS OR MINUS 1/2 INCH MEASURED WITH 10 FOOT STRAIGHTEDGE.
- 3.3 PRODUCTS AND MATERIALS (AS APPROVED BY CONSTRUCTION MANAGER OR AS NOTED IN CONSTRUCTION DOCUMENTS):
- A. SUBBASE MATERIAL GRADED MIXTURE OF NATURAL OR CRUSHED GRAVEL, CRUSHED STONE OR SLAG, AND NATURAL SAND
- WASHED MATERIAL EVENLY GRADED MIXTURE OF CRUSHED STONE OR GRAVEL WITH 95 PERCENT PASSING A 1 1/2 INCH SIEVE
- GRADING MATERIAL WILL CONSIST OF: SATISFACTORY NATIVE OR IMPORTED SOIL MATERIALS FREE OF CLAY, ROCK OR GRAVEL NOT LARGER THAN 2 INCHES IN ANY DIMENSION, DEBRIS, WASTE, FROZEN MATERIALS AND OTHER UNSUITABLE MATERIALS WILL NOT BE ALLOWED FOR USE IMPORTED MATERIALS SHALL HAVE A CLAY CONTENT NO MORE THAN 5 PERCENT.

PREPARED FOR





MILESTONE TOWERS 12110 SUNSET HILLS ROAD #600 RESTON, VA 20190

SITE NAME:

JORDAN LUMBER

SITE ADDRESS: COOL SPRINGS RD CARTHAGE, NC 28327 MOORE COUNTY





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SHEET TITLE:

GENERAL NOTES

SHEET NUMBER

- D. BACKFILL MATERIALS WILL CONSIST OF: SATISFACTORY NON-COHESIVE NATIVE OR IMPORTED SOIL MATERIALS FREE OF CLAY, ROCK OR GRAVEL NOT LARGER THAN 4 INCHES IN ANY DIMENSION, DEBRIS, WASTE, FROZEN MATERIALS, AND OTHER UNSUITABLE MATERIALS. IMPORTED MATERIAL SHALL HAVE A CLAY CONTENT OF NO MORE THAN 5 PERCENT.
- GRAVEL MATERIAL EVENLY GRADED MIXTURE OF CRUSHED STONE OR GRAVEL WITH 95 PERCENT PASSING A 1 1/2 INCH SIEVE
- E GEOTEXTILE FABRIC: AS PER CONSTRUCTION DOCUMENTS
- 3.4 CLEARING AND GRUBBING REMOVE ALL VEGETATION AND MATERIALS AS REQUIRED.

 REMOVE STUMPS COMPLETELY UNDER FOUNDATIONS AND ROADWAY. DISPOSE OF

 CLEARING AND GRUBBING OFF-SITE, OR IN AN ON-SITE LOCATION APPROVED BY
 CONSTRUCTION MANAGER:

3.5 STRIPPING:

STRIP NOT LESS THAN 3 INCHES OF SOD AND TOPSOIL FROM AREAS THAT WILL UNDERLAY GRAVEL PAVEMENT, NEW STRUCTURES OR NEW EMBANKMENTS. STOCKPILE STRIPPING ON—SITE FOR RE—USE IN FINAL LANDSCAPING.

3.6 COMMON EXCAVATION:

- A EXCAVATE TO DEPTH, LINES AND GRADES SHOWN ON THE PLANS OR AS OTHERWISE SPECIFIED.
- B. TEMPORARILY STOCKPILE ON-SITE EXCAVATION AT AN APPROVED LOCATION WITHIN THE WORK AREA UNTIL SITE GRADING IS COMPLETE STOCKPILE SHALL NOT EXCEED 15 FEET IN HEIGHT.
- C. LEGALLY DISPOSE OF EXCESS COMMON EXCAVATION OFF-SITE

3.7 EMBANKMENT:

- A. CONSTRUCT EMBANKMENT TO THE LINES AND GRADE SHOWN ON THE DRAWINGS
- B CONSTRUCT EMBANKMENT FROM ON-SITE EXCAVATION MATERIALS WHEN SUITABLE USE IMPORTED BACKFILL ONLY AFTER AVAILABLE ON-SITE EXCAVATION MATERIALS HAVE BEEN USED.
- C. CONSTRUCT IN LIFTS OF NOT MORE THAN 12 INCHES IN LOOSE DEPTH THE FULL WIDTH Of THE CROSS SECTION SHALL BE BROUGHT UP UNIFORMLY
- D. MATERIAL SHALL NOT BE PLACED IN LAYERS AND SHALL BE NEAR OPTIMUM MOISTURE CONTENT BEFORE ROLLING TO OBTAIN THE PRESCRIBED COMPACTION. WETTING DR ORYING OF THE MATERIAL AND MANIPULATION TO SECURE A UNIFORM MOISTURE CONTENT THROUGHOUT THE LAYER MAY BE REQUIRED. SUCH OPERATIONS SHALL BE INCLUDED IN THE APPROPRIATE BID ITEM. SHOULD THE MATERIAL BE TOO WET TO PERMIT PROPER COMPACTION. T IS THE CONTRACTOR'S RESPONSIBILITY TO UTILIZE MATERIAL WITH AN ACCEPTABLE MOISTURE CONTENT.
- E. DO NOT PLACE FROZEN MATERIAL IN THE EMBANKMENT AND DO NOT PLACE EMBANKMENT MATERIAL UPON FROZEN MATERIAL.
- CONTRACTOR SHALL BE RESPONSIBLE FOR THE STABILITY OF EMBANKMENTS AND THE REPLACEMENT OF ANY PORTION WHICH HAS BECOME DISPLACED DUE TO THE CONTRACTORS OPERATIONS
- G. START LAYERS IN THE DEEPEST PORTION OF THE FILL, AND AS PLACEMENT PROGRESSES, CONSTRUCT LAYERS APPROXIMATELY PARALLEL TO THE FINISHED GRADE LINE.
- H ROUTE EQUIPMENT, BOTH LOADED AND EMPTY, OVER THE FULL WIDTH OF EMBANKMENT TO ENSURE UNIFORMITY OF MATERIAL PLACEMENT.
- COMPACT EMBANKMENT UNDERLYING NEW GRAVEL PAVING FLOOR SLABS AND STRUCTURES TO A 95 PERCENT COMPACTION AT A MAXIMUM DRY DENSITY AS DETERMINED BY ASTM 0-1557 OR WITHIN PLUS OR MINUS 3 PERCENT OF OPTIMUM MOISTURE CONTENT. COMPACT NON-STRUCTURAL AREA EMBANKMENTS TO A MINIMUM OF 90 % OF ASTM 0-1557.

3.8 SITE GRADING

- A: USING ON-SITE EXCAVATION MATERIALS SHAPE, TRIM, FINISH AND COMPACT SURFACE AREAS TO CONFORM TO THE LINES, GRADES AND CROSS SECTIONS SHOWN ON THE DRAWINGS OR AS DESIGNATED BY THE CONSTRUCTION MANAGER.
- B. GRADE SURFACES TO DRAIN AND ELIMINATE ANY PONDING OR EROSION.
- C. ELIMINATE WHEEL RUTS BY REGRADING.
- D. COMPACT AREAS UNDERLYING NEW GRAVEL PAVING, FLOOR SLABS AND STRUCTURES TO A 95 PERCENT COMPACTION AT A MAXIMUM DRY DENSITY AS DETERMINED BY ASTM D-1551 OR WITHIN PLUS OR MINUS 3 PERCENT OF OPTIMUM MOISTURE CONTENT.
- E CONSTRUCT FINISHED SURFACE OF SITE GRADING AREAS WITHIN ONE INCH FROM SPECIFIED GRADE.

3.9 SUBGRADE PREPARATION:

- A SHAPE TOP OF SUBGRADE TO THE LINES AND GRADES SHOWN ON THE DRAWINGS
- B MAINTAIN TOP OF SUBGRADE TO A FREE-DRAINING CONDITION

- C. DO NOT STOCKPILE MATERIALS ON TOP OF SUBGRADE UNLESS AUTHORIZED BY CONSTRUCTION MANAGER
- D. COMPACT THE TOP 12 INCHES OF SUBGRADE TO A 95% COMPACTION AT A MAXIMUM DRY DENSITY AS DETERMINED BY ASTM 0-1557 OR WITHIN PLUS OR MINUS 3 PERCENT OF OPTIMUM MOISTURE CONTENT.
- C CONSTRUCT TOP OF SUBGRADE WITHIN ONE INCH OF ESTABLISHED GRADE AND CROSS-SECTION.

3 10 GEOTEXTILE FABRIC:

A. LAY GEOTEXTILE FABRIC OVER COMPACTED SUBGRADE AS PER CONSTRUCTION DOCUMENTS IN THE COMPOUND AREA AND UNDER LENGTH OF ROAD (WHEN REQUIRED), LAP ALL JOINTS TO A MINIMUM OF 36 INCHES

3 11 GRAVEL SURFACING:

- A CONSTRUCT GRAVEL SURFACING AREAS USING CRUSHED AGGREGATE BASE AND FINISH COURSES AS SPECIFIED BY CONSTRUCTION MANAGER OR CONSTRUCTION DOCUMENTS
- B SPREAD GRAVEL AND RAKE TO OBTAIN A UNIFORM SURFACE AREA.

4.0 TRENCHING:

CALL LOCAL UNDERGROUND UTILITY LOCATING SERVICE BEFORE ANY EXCAVATION OR TRENCHING.

4.1 MATERIALS:

FILL MATERIAL SHALL BE OBTAINED, WHEN POSSIBLE FROM MATERIALS EXCAVATED FROM TRENCHES. ON—SITE STRUCTURAL FILL SAND OR SLURRY SHALL BE APPROVED BY THE CONSTRUCTION MANAGER AND SHALL CONFORM TO LOCAL GOVERNING JURISDICTIONS AND UTILITY COMPANY REQUIREMENTS THE FILL MATERIAL SHALL CONTAIN NO ORGANIC MATERIAL OR ROCKS, NOR SHALL CONTAIN OBJECTIONABLE MATERIALS AND/OR MATERIALS DESIGNATED AS HAZARDOUS OR INDUSTRIAL BY THE ENVIRONMENTAL PROTECTION AGENCY (EPA) THE FILL MATERIAL SHALL CONTAIN FINES SUFFICIENT TO FILL ALL VOIDS IN THE MATERIAL COMPACTION OF BACKFILL OR BORROW SOIL SHALL BE PLACED IN 12 INCH LOOSE LIFTS WHEN UTILIZING HEAVY COMPACTION EQUIPMENT OR 6 INCH LOOSE LIFTS WHEN UTILIZING HAND OPERATED TAMPERS

4.2 PIPE DETECTION AND IDENTIFICATION:

A. UTILIZING WARNING TAPE: ALL ELECTRIC SERVICE TRENCHES SHALL BE MARKED WITH WARNING TAPE.

4.3 TRENCH EXCAVATION:

- A. DIG TRENCH TO LINES AND GRADES SHOWN ON THE PLANS OR AS DIRECTED BY CONSTRUCTION MANAGER
- B TRENCH LENGTH SHALL BE SUFFICIENT TO ALLOW FOR SATISFACTORY CONSTRUCTION AND INSPECTION OF THE PROJECT WITHOUT ENDANGERING OTHER CONSTRUCTION WORK OR ADJACENT FACILITIES
- C DISPOSE OF EXCESS AND UNSUITABLE EXCAVATION MATERIAL PROPERLY, AS DIRECTED BY CONSTRUCTION MANAGER.
- D. USE HAND METHODS FOR EXCAVATION THAT CANNOT BE ACCOMPLISHED WITHOUT ENDANGERING EXISTING OR NEW STRUCTURES OR OTHER FACILITIES

4.4 TRENCH PROTECTION:

- A. PROVIDE MATERIALS, LABOR AND EQUIPMENT NECESSARY TO PROTECT TRENCHES AT ALL TIMES.
- B SHEETING AND BRACING (MEET OR EXCEED OSHA REQUIREMENTS)

4.5 BACKFILLING:

- A TRENCH TO BE BACKFILLED DAILY
- B BACKFILL TRENCH WITH LIFTS UP TO 12 INCHES, LOOSE MEASURE
- C. PROTECT CONDUIT FROM LATERAL MOVEMENT, DAMAGE FROM IMPACT OR UNBALANCED LOADING TO AVOID DISPLACEMENT OF CONDUIT AND/OR STRUCTURES DO NOT FREE FALL BACKFILL INTO TRENCH UNTIL AT LEAST 12 INCHES OF COVER IS OVER THE CONDUIT

4 6 COMPACTION:

- A COMPACT BACKFILL TO A 95 PERCENT COMPACTION AT A MAXIMUM DRY DENSITY AS DETERMINED BY ASTM 0-1557 OR WITHIN PLUS OR MINUS 3 PERCENT OF OPTIMUM MOISTURE CONTENT
- F REQUIRED COMPACTION DENSITY HAS NOT BEEN OBTAINED, REMOVE THE BACKFILL FROM THE TRENCH OR STRUCTURE, REPLACE WITH APPROVED BACKFILL AND RECOMPACT AS SPECIFIED

C ANY SUBSEQUENT SETTLEMENT OF TRENCH OR STRUCTURE BACKFILL DURING MAINTENANCE PERIOD SHALL BE CONSIDERED THE RESULT OF IMPROPER COMPACTION AND SHALL BE PROMPTLY CORRECTED.

5.0 CHAIN LINK FENCES AND GATES:

5.1 GENERAL:

A PROVIDE CHAIN LINK FENCES AND GATES AS COMPLETE UNITS BY A SINGLE SUPPLY SOURCE INCLUDING NECESSARY ERECTION ACCESSORIES, FITTINGS AND FASTENERS

5.2 PRODUCTS AND MATERIA_S (AS APPROVED BY CONSTRUCTION MANAGER OR AS WITHIN CONSTRUCTION DOCUMENTS):

- A COMPOUND FABRIC 96 INCHES HIGH AND OVER WITH 2-INCH MESH SHALL BE KNUCKLED AT ONE SELVAGE AND TWISTED AT THE OTHER.
- B STEEL FARRIC-

COMPLY WITH CHAIN LINK FENCE MANUFACTURERS INSTITUTE (CLFMI) PRODUCT MANUAL FURNISH ONE PIECE OF FABRIC WIDTHS WIRE SIZE INCLUDES ZINC OR ALUMINUM COATING

C. FRAMEWORK AND ACCESSORIES:

- I. GENERAL REQUIREMENTS: EXCEPT AS INDICATED OTHERWISE CONFORM TO THE CHAIN LINK FENCE MANUFACTURERS INSTITUTE (CLFMI) PRODUCT MANUAL INDUSTRIAL STEEL GUIDE FOR FENCE RAILS, POSTS, GATES AND ACCESSORIES INCLUDING TABLE I
- D. SWING GATES:
 - 1. HINGES: NON LIFT-OFF TYPE OFFSET TO PERMIT ISO DEG GATE OPENING
 - 2 LATCH: STYMIFLOCK
- 3. KEEPER: PROVIDE KEEPER FOR VEHICLE CATES, WHICH AUTOMATICALLY ENGAGES GATE LEAF AND HOLDS IT IN OPEN POSITION UNTIL MANUALLY RELEASED.

E. CONCRETE.

PROVIDE CONCRETE CONSISTING OF PORTLAND CEMENT, ASTM C 150, AGGREGATES ASTM C 33, AND CLEAN WATER MIX MATERIALS TO OBTAIN CONCRETE WITH A MINIMUM OF 28-DAY COMPRESSIVE STRENGTH OF 3000 PSI.

6 0 LANDSCAPING:

A. FURNISH, INSTALL AND MAINTAIN LANDSCAPE WORK AS SHOWN AND OR REQUIRED WITHIN THE CONSTRUCTION DOCUMENTS OR AS SPECIFIED IN THE TOWER OWNERS CONSTRUCT ON SPECIFICATIONS

7.0 CONCRETE FORMWORK:

- A FORMS: SMOOTH AND FREE OF SURFACE IRREGULARITIES UTILIZE FORM RELEASE AGENTS
- B CHAMFER: EXPOSED EDGES OF ALL 10WER FOUNDATIONS SHALL RECEIVE A 3/4" BY 3/4" 45 DEGREE CHAMFER, OTHER EXPOSED EDGES SHALL RECEIVE A TOOLED RADIUS FINISH
- C. UPON COMPLETION, REMOVE ALL FORMS, INCLUDING THOSE CONCEALED OR BURIED.
- D REFER TO STRUCTURAL DRAWINGS FOR ADDITIONAL REQUIREMENTS

8.0 CONCRETE REINFORCEMENT:

REFER TO STRUCTURAL DRAWINGS FOR ALL REQUIREMENTS,

PREPARED FOR

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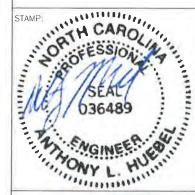


MILESTONE TOWERS
12110 SUNSET HILLS ROAD #600
RESTON, VA 20190

SITE NAME

JORDAN LUMBER

SHE ADDRESS: COOL SPRINGS RD CARTHAGE, NC 28327 MOORE COUNTY





DRAWN BY: IL

APPROVED BY: TH

DATE DRAWN: 01/03/22

REVISION

NO DESCRIPTION BY DATE

A ISSUED FOR REVIEW IL 01/03/22

0 ISSUED FOR REVIEW IL 02/15/22

GENERAL NOTES

SHEET NUMBER

SHEET TITLE.

9.0 CAST IN PLACE CONCRETE

FOR STRUCTURAL CONCRETE (FOOTINGS, FOUNDATIONS, ETC.), REFER TO STRUCTURAL DRAWINGS FOR REQUIREMENTS, FOR ANY MISCELLANEOUS CONCRETE, REFER TO SPECIFICATION BOOK OR OBTAIN REQUIREMENTS FROM CONSTRUCTION MANAGER.

- A ALL CONCRETE SHALL COMPLY WITH ASTM C94 UNLESS NOTED OTHERWISE
- B. MINIMUM COMPRESSIVE STRENGTH (F'C) AT 28 OATS: 5000 PSI FOR TOWER FOUNDATION AND 3500 PSI FOR ALL OTHER CONCRETE UNLESS SPECIFIED IN CONSTRUCTION DOCUMENTS.
- C AIR ENTRAINMENT:

PROVIDE 4 TO 8% AIR ENTRAINMENT FOR ALL CONCRETE SUBJECT TO FREEZE-THAW CYCLE.

D CONCRETE TESTING:

ALL FOUNDATION CONCRETE SHALL BE TESTED BY AN INDEPENDENT TESTING AGENCY CONTRACTED BY THE CONSTRUCTION MANAGER. ALL STRUCTURAL TOWER FOUNDATION CONCRETE FOUNDATION FOR EQUIPMENT OR BUILDING PADS ARE NOT REQUIRED TO BE TESTED, UNLESS OTHERWISE NOTED BY CONSTRUCTION MANAGER. PROVIDE A MINIMUM OF 5 CYLINDERS (2-7-DAY, 2-28-DAY, 1-SPARE) FOR EACH OATS POUR. OR FOR EVERY 50 YARDS PLACED, WHICHEVER 15 GREATER. ADDITIONAL TESTS OR CYLINDERS MAY BE REQUIRED BY CONSTRUCTION MANAGER. A SLUMP, AIR, AND TEMPERATURE TEST SHALL BE PERFORMED FOR FACH SET OF CYLINDERS CAST. PREFERABLY. TESTS SHALL BE PERFORMED AT THE LOCATION OF ANCHOR BOLTS (PIERS - FOR MAT & PIERS, CAISSONS TOP 1/3 OF CAISSON). TESTS SHALL ALSO BE REQUIRED FOR CONCRETE CONSIDERED BEING LESS THAN DESIRABLE BY CONCRETE SPECIFICATION STANDARDS. THE TESTING AGENCY HAS THE AUTHORITY TO NOT ACCEPT CONCRETE MEETING THESE SPECIFICATIONS FOR THE TOWER OWNER. THE CONTRACTOR IS RESPONSIBLE FOR COORDINATION OF THE TESTING AGENCY A MINIMUM OF 24 HOURS IN ADVANCE OF EACH FOUNDATION POUR TEST REPORTS SHALL BE FORWARDED TO THE TOWER OWNERS CONSTRUCTION MANAGER WITHIN 24 HOURS OF LAB TEST.

- E. VIBRATE ALL CONCRETE USING SUFFICIENT HIGH FREQUENCY LOW AMPLITUDE MECHANICAL IMMERSION TYPE VIBRATORS. INSERT VIBRATORS IN CONCRETE AT REGULAR INTERVALS AND OVER ENTIRE SURFACE TO SOLIDLY FILL CONCRETE MECHANICAL IMMERSION TYPE VIBRATORS. INSERT VIBRATORS IN CONCRETE AT REGULAR INTERVALS AND OVER ENTIRE SURFACE TO SOLIDLY FILL CONCRETE AROUND AND BETWEEN REINFORCEMENT BARS AND INTO CORNERS AND IRREGULARITIES. VIBRATE THOROUGHLY THROUGH EACH LIFT TO THE PREVIOUS LIFE REVERBERATION AS LATE AS THE RUNNING VIBRATOR WILL SINK THROUGH UPPER LAYERS OF ITS WEIGHT IS RECOMMENDED. DISCONTINUE VIBRATION WHEN RISING ENTRAPPED AIR BUBBLES STOP BREAKING THE LEVELING SURFACE. DO NOT OVER VIBRATE AS THIS MAY CAUSE SECREGATION.
- F FINISHING EXPOSED CONCRETE SURFACES:
 - 1 THESE PROVISIONS APPLY TO ALL EXPOSED AND ALL FORMED CONCRETE, EXTERIOR OR INTERIOR. UNLESS SPECIFICALLY DETAILED OTHERWISE, PERFORM PROCEDURES PRIOR TO APPLICATION OF ANY CURING COMPOUNDS.
 - ALL SURFACES: THOROUGHLY CLEAN OFF ALL STAINS, SPATTER AND LOOSE MATERIAL.
 - 3 FINS, RIDGES AND HIGH SPOTS: HONE SMOOTH WITH ABRASIVE POWER GRINDERS WHILE CONCRETE IS GREEN, IMMEDIATELY AFTER FORM REMOVAL.
 - 4 FORM TIE HOLES AND DEEP DEPRESSIONS: FLUSH THOROUGHLY WITH CLEAN WATER AND TAMP TO OVERFULL WITH DRYPACK. CURE 10 DAYS AND HONE FLUSH AND SMOOTH
 - 5 ROCK POCKETS, HONEYCOMB, SAND STREAKS, DEBRIS AND VOIDS: CUT OUT AT LEAST 1 INCH DEEP WITH SIDES PERPENDICULAR TO SURFACE. FLUSH THOROUGHLY WITH CLEAN WATER, COAT SURFACE WITH NEAT CEMENT PASTE AND TAMP TO OVERFULL WITH DRYPACK IN AT LEAST TWO LAYERS CURE FOR 10 DAYS AND HONE FLUSHED AND SMOOTH.
- G CONTRACTOR SHALL VERIFY ALL SIZES AND LOCATIONS OF ALL ELECTRICAL OPENINGS AND EQUIPMENT/BUILDING PADS WITH THE ELECTRICAL DRAWINGS AND SHOP DRAWINGS. IT SHALL BE THE RESPONSIBILITY OF THE CONTRACTOR TO PROVIDE ALL OPENINGS AND SLEEVES FOR PROPER DISTRIBUTION FOR ALL UTILITIES. CONTRACTOR SHALL REFER TO DRAWINGS OF OTHER TRADES AND VENDOR DRAWINGS FOR EMBEDDED ITEMS AND RECESSES NOT SHOWN ON STRUCTURAL DRAWINGS. PRIOR TO POURING CONCRETE THE INDEPENDENT TESTING AGENCY SHALL INSPECT ALL FOUNDATION STEEL AND FOUNDATION SUBGRADE

10.0 STRUCTURAL STEEL

MEET OR EXCEED MANUFACTURER'S RECOMMENDATIONS.

- A UNLESS OTHERWISE NOTED, ALL DETAILING, FABRICATION AND PLACING OF REINFORCING STEEL SHALL CONFORM TO THE MANUAL OF STANDARD PRACTICE FOR DETAILING REINFORCED CONCRETE STRUCTURES (ACI 315)
- B. ALL REINFORCING STEEL SHALL BE NEW BILLET STEEL, CONFORMING TO ASTM A-615 GRADE 60, DEFORMED.
- C HEATING AND WELDING OF BARS IS PROHIBITED WITH THE EXCEPTION OF WRITTEN APPROVAL BY THE STRUCTURAL ENGINEER
- D. ALL REINFORCEMENT BARS TO BE FREE FROM LOOSE RUST AND SCALE

- UNLESS OTHERWISE NOTED, ALL REINFORCEMENT SHALL HAVE A MINIMUM CONCRETE COVERAGE OF 3 INCHES THIS MAY REQUIRE SPACERS AND CHAIRS AS REQUIRED BY TESTING AGENCY OR CONSTRUCTION MANAGER
- SPLICES IN REINFORCEMENT STEEL ARE PROHIBITED, UNLESS APPROVED BY CONSTRUCTION MANAGER ALL SPLICES MUST THEN MEET ALL APPLICABLE ASTM STANDARDS FOR SPLICING

11.0 GROUNDING:

MEET ALL APPLICABLE CODES, REQUIREMENTS OF THE CONSTRUCTION DOCUMENTS AND TOWER OWNERS CONSTRUCTION SPECIFICATIONS

PREPARED FOR:






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GENERAL NOTES

SHEET NUMBER:

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CONTACT:	FPM	SAME	LKENSE =		ž.,,
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Civil Electrical Fire Alaim Plainshing Mechanical Sprinkler-Structural Structural	Монилиц I, ПУ	Anthony Hughel	036489	(\$22) 603.92	threbel/juncounrints com
Retaining Walls Other	9 High	int street a	UNIXI We see the		man ser i
2018 NC COD	1	ew Construction Time Interior Con tell Core tassed Construction enovation DDE: Prescript on: Level 1	mpletion i – Shelf Core	ран 🔲	
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	ancy Classification(5):	Cell Tosser		
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pecial Protision	(Chapter 5 - List Code	e Sections) N.A.		
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Appendix 8 for Building

6

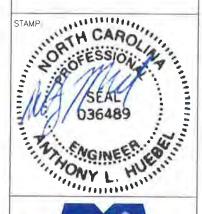	LIFE SAFETY SYSTEM REQUIREMENTS	
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	LIFE SAFETY PLAN REQUIREMENTS	
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	ery line locations (if not in the site plan)	
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	dictances (1606.2.1 & 2006.3.2(1))	
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2018 NC Administrative Code und Policies

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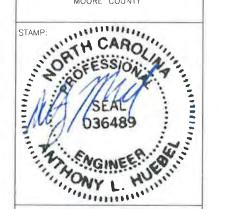


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APPENDIX B

SHEET NUMBER: N1.3

			(SECTION	1106)				
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Risk Category (Toble 1604.5)	Risk Category (Toble 1604.5)	B [] ([] D
SOIL BEARING CAPACITIES Field Test (provide copy of test report) gsf Prevumptive Bearing capacity psf	SOIL BEARING CAPACITIES Field Test (provide copy of test report) gsf Prevumptive Bearing capacity psf	S; Seg F Presumptive Historical Data Dual w Special Moment Frame Dual w Intermediate R. C. on Special Steel Liverted Pendulum Equivalent Lateral Force Dynamic
Field Test (provide copy of test report) gsf Precomptive Bearing capacity psf	Field Test (provide copy of test report) gsf Precomptive Bearing capacity psf	Wind

BUILDING CODE SUMMARY FOI MECHANIC	ENDIX B R ALL COMMERCIAL PROJECTS Aldesign ICL Sheets & Applicable)
MECHANICA	L SUMMARY
MECHANICAL SYSTEMS, SERVICE SYSTEMS AND I	EQUIPMENT
Thermal Zone water dry bulb Interior design conditions water dry bulb: NA summer dry bulb relative hamidity Building heating load: NA Mechanical Spacing Conditioning by stem Unitary description of tunt: NA heating efficiency cooling efficiency size category of unit Boiler Size category If oversized, state reason Chiller Size category II oversized state reason	NA NA
List equipment efficiencies:	

2018 APPENDIX B BUILDING CODE SUMMARY FOR ALL COMMERCIAL PROJECTS ELECTRICAL DESIGN (PROVIDE ON THE ELECTRICAL SHEETS IF APPLICABLE)
ELECTRICAL SUMMARY
ELECTRICAL SYSTEM AND EQUIPMENT
Method of Compliance: Energy Code Prescriptive Performance ASBRAE 901 Prescriptive Performance
Lighting schedule (each fixture type) lamp type required in fixture insuler of lamps in fixture ballar type used in the fixture number of ballact; in fixture total wratage per fixture total wratage per fixture total america wratage specified vs. allowed (whole building or space by space) total exterior wratage specified vs. allowed Addirional Efficiency Package Options (When using the 2018 NCECC) not required for ASHRAE 90.1) C406 2 More Efficient Mechanical Equipmen C406 3 Reduced Lighting Power Denamy C406 3 Reduced Lighting Power Denamy C406 5 On-Site Renewable Energy C406 6 On-Site Renewable Energy C406 6 Reduced Confort An System C406 8 Reduced Energy Use in Service Water Heating
018 NC Administrative Code and Pchares Appendix 8 for Building

PREPARED FOR:





MILESTONE TOWERS
12110 SUNSET HILLS ROAD #600
RESTON, VA 20190

SITE NAME

JORDAN LUMBER

SHE ADDRESS: COOL SPRINGS RD CARTHAGE, NC 28327 MOORE COUNTY






DR	AWN BY	IL		
AP	PROVED BY:	TH		
DA	TE DRAWN	01/03/2	2	
		REVISION		
NO	DESCRIPTION		BY	DATE
Α	ISSUED FOR	REVIEW	IL	01/03/2
0	ISSUED FOR	REVIEW	IL	02/15/2
SH	EET TITLE:			

APPENDIX B

SHEET NUMBER:

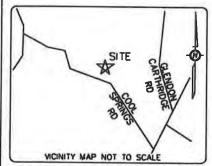

PARENT PARCEL INFORMATION: OWNER: JORDAN THREE LLC

PARCEL ID 00003428 PIN 867100671721 DEED BOOK 4092 PAGE 40

1-A INFORMATION

LATITUDE: 35° 26' 47.33" N LONGITUDE: 79° 24° 55.64" W

GROUND ELEVATION AT BASE OF PROPOSED TOWER 251,0"

ZONING: N/A

THIS PARCEL OF LAND LIES WITHIN FLOOD ZONE X&AE WHICH IS A SPECIAL FLOOD
HAZARD AREA AS PER F.I.R.M. PANEL
NUMBER: 3710866000J
EFFECTIVE DATE: 10/17/2006

LEGEND:
SET 5/8" REBAR, OR AS NOTED
OR AS NOT

:FOUND 1/2" REBAR, OR AS NOTED 0 :FOUND MONUMENT, OR AS NOTED

:RECORD DESCRIPTION DATA

:POINT OF TERMINUS P.O.T. :POINT OF BEGINNING P.O.B.

P.O.C. : POINT OF COMMENCEMENT

--- 0 ---: FENCE AS NOTED

--- OH ---: OVER HEAD UTILITY LINES

: WOOD UTILITY POLE

:ELECTRIC TRANSFORMER

: TELCO PEDESTAL


:HAND HOLE :NOT AVAILABLE N/A

:LANDS NOW/FORMERLY N/F

:FLOOD LIGHT

:UNDERGROUND FIBER MARKER

AREA	SQUARE FEET	ACRE
PARENT PARCEL	3,151,543	72.35
PROPOSED TOWER LEASE	4,900	0.11
PROPOSED PARKING AREA	1,000	0.02
PROPOSED ACCESS /UTILITY EASEMENT	10,312	0.24

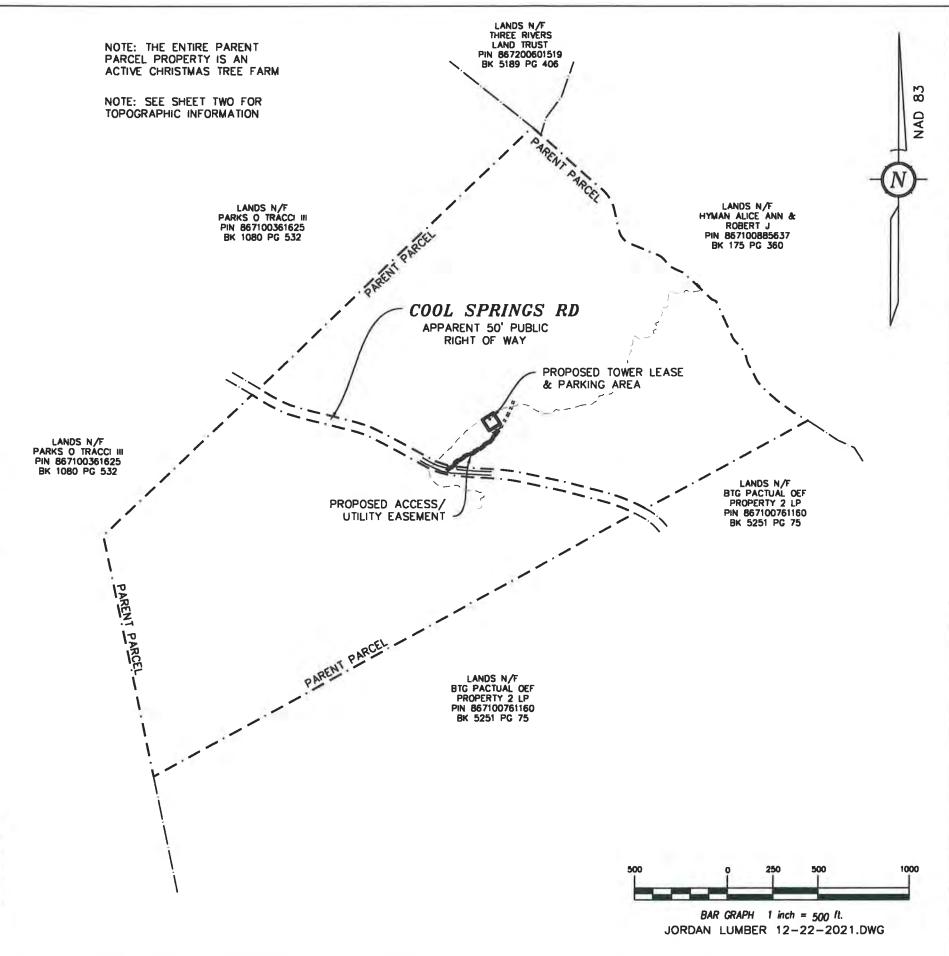

AS-BUILT SURVEY

A PARCEL OF LAND LYING IN THE TOWN OF CARTHAGE OF MOORE COUNTY

FOR: MOUNTAIN LTD ENGINEERING

NAME: JORDAN LUMBER

NUMBER: N/A

ADDRESS: COOL SPRINGS RD CARHRIDGE NC 28327 MOORE COUNTY



MOUNTAIN, LTD **ENGINEERING**

NATIONAL SURVEY BERVICES COORDINATION BY:

SURVEYING, INC.

13430 NW 104th Terrace, Suite A Alachua, FL 32615 Office:(386) 418-0500 Fax:(386) 462-9986 WWW.GEOLINEINC COM

SURVEY WORK PERFORMED BY:



Professional Land Surveying 10505 Leofeood Place Roleigh NC 27615 E-ME: roleigh arphyserotics (919) 280-8189 FAX 995-9616 Scn.com FMI C-2757

SURVEYOR'S NOTES

1. BASIS OF BEARING: AZ GRID CENTRAL ZONE NAD83


- 2. NO SUBSURFACE INVESTIGATION WAS PERFORMED TO LOCATE UNDERGROUND UTILITIES. UTILITIES SHOWN HEREON ARE LIMITED TO AND ARE PER OBSERVED EVIDENCE ONLY.
- 3. THIS SURVEY DOES NOT REPRESENT A BOUNDARY SURVEY OF THE PARENT PARCEL.
- 4. ALL VISIBLE TELECOM EQUIPMENT AND IMPROVEMENTS ARE CONTAINED WITHIN THE DESCRIBED AREA.
- 5. ALL SYMBOLS SHOWN HEREON NOT DEPICTED TO SCALE.


SURVEYOR'S CERTIFICATION HEREBY CERTIFY TO:


MURPHY GEOMATICS


LAND SURVEYOR -DATE:


FIELD DATE: 12/21/2021

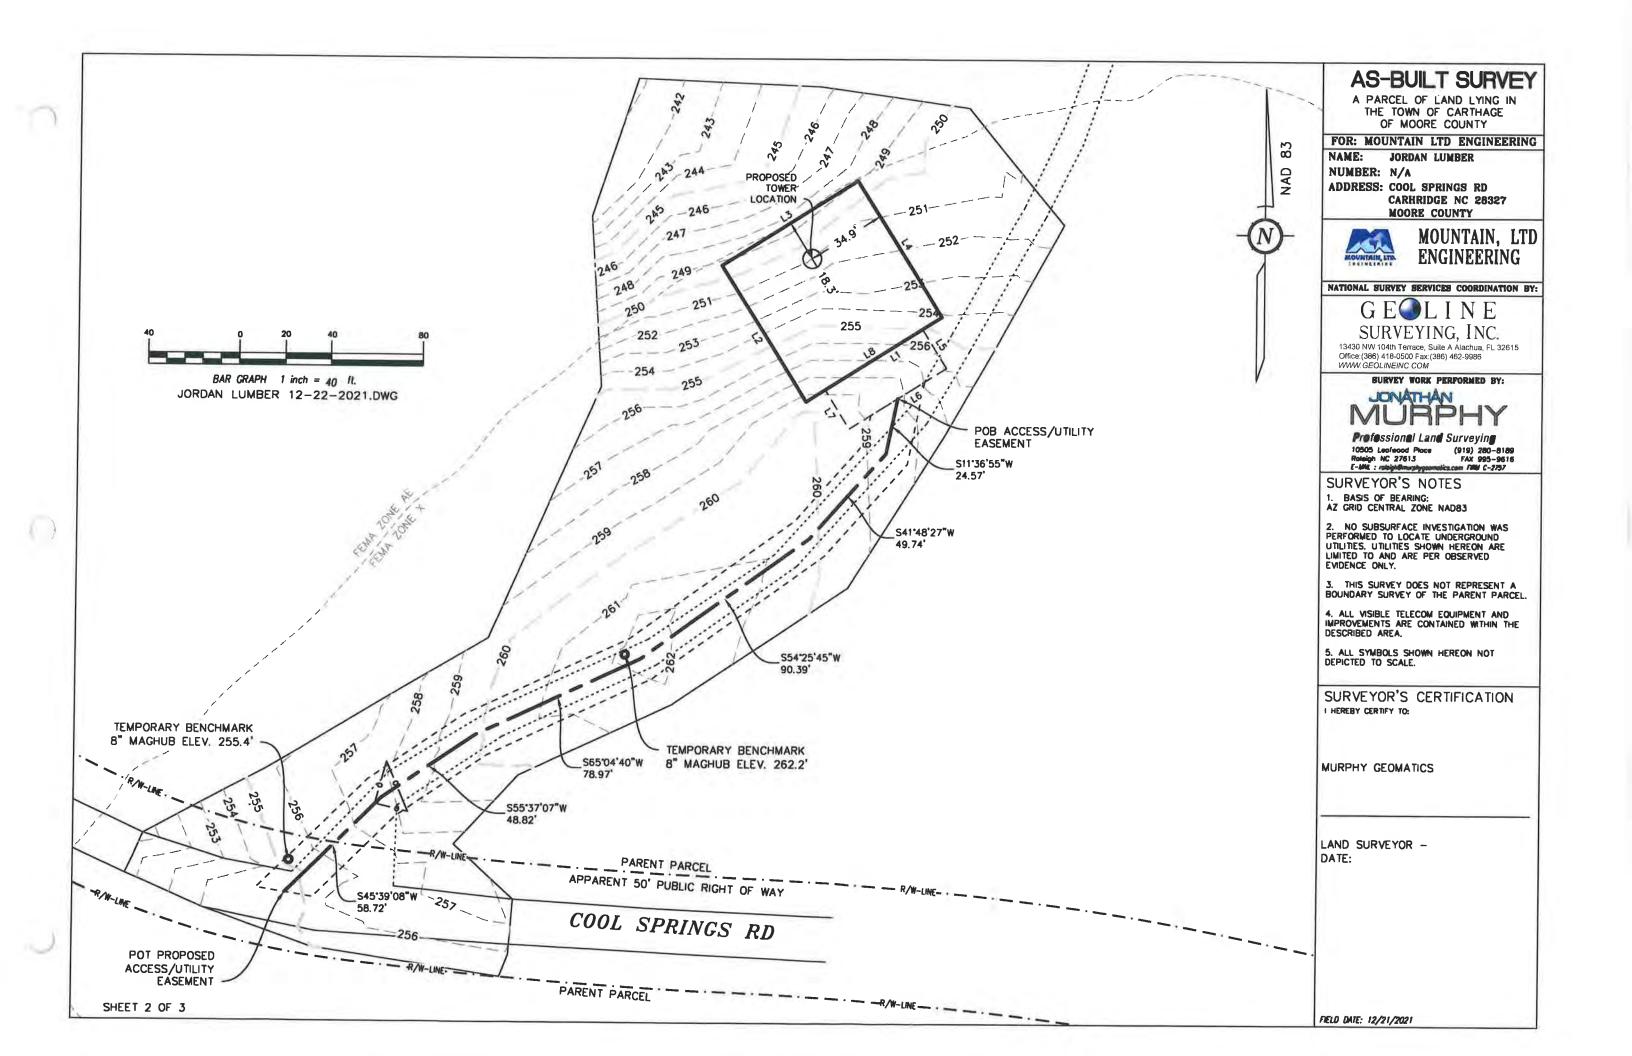


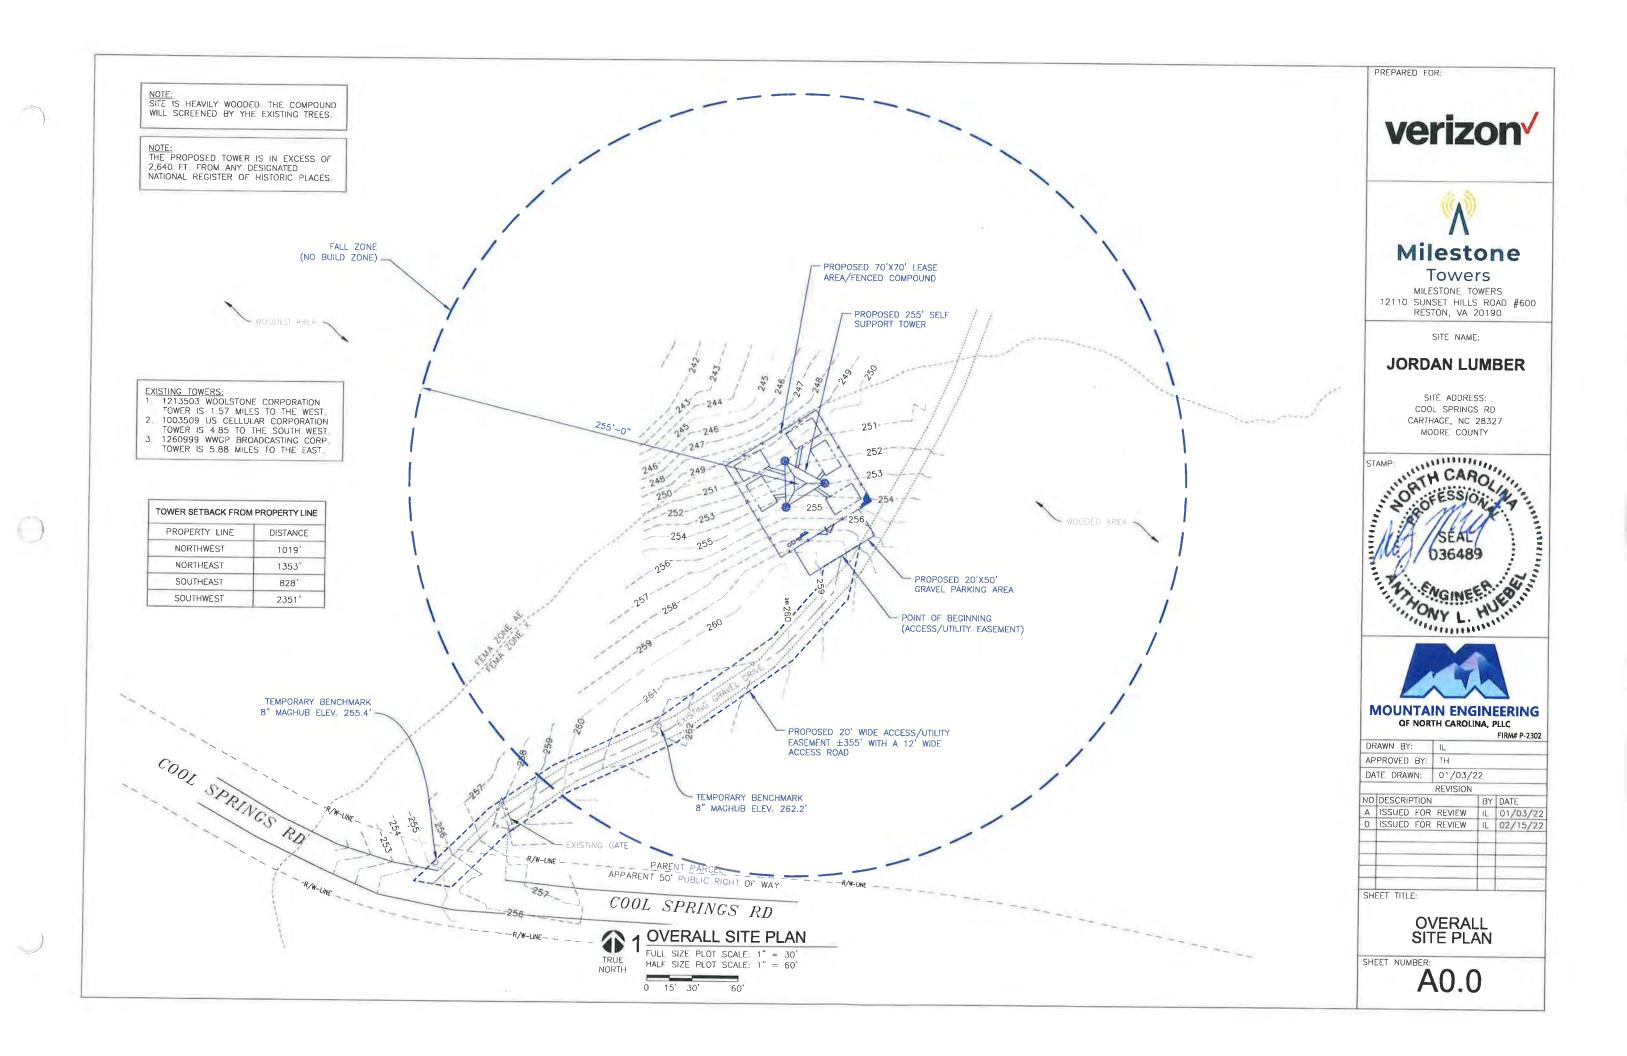

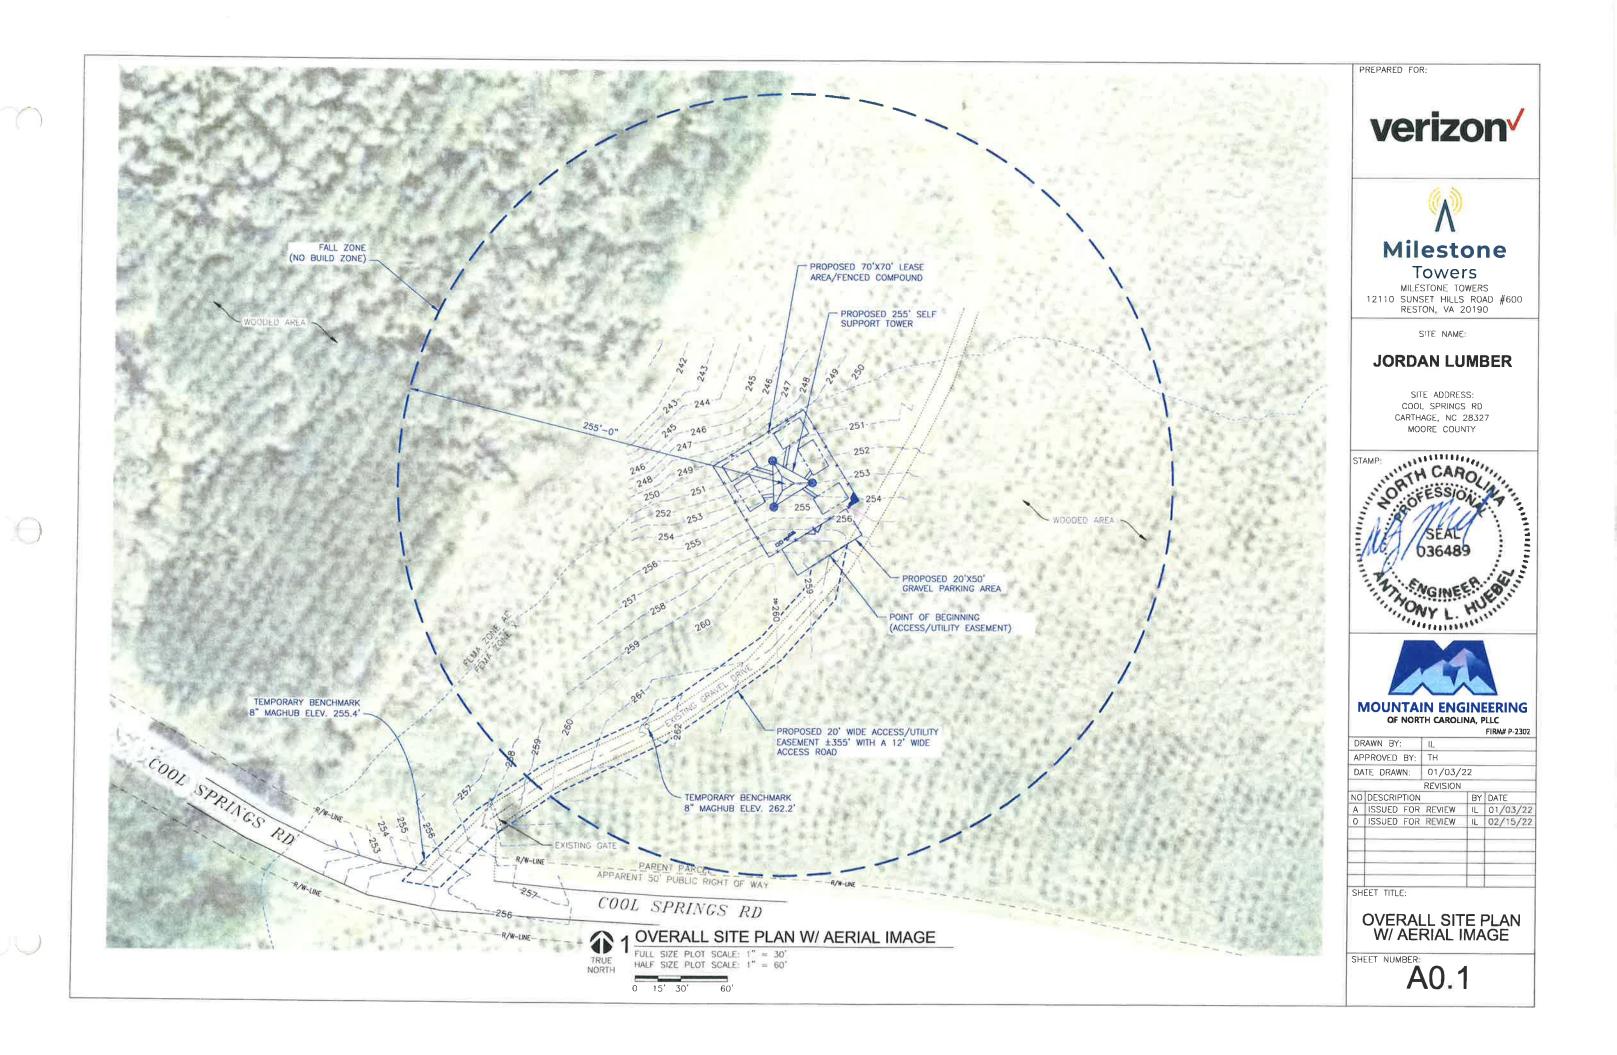

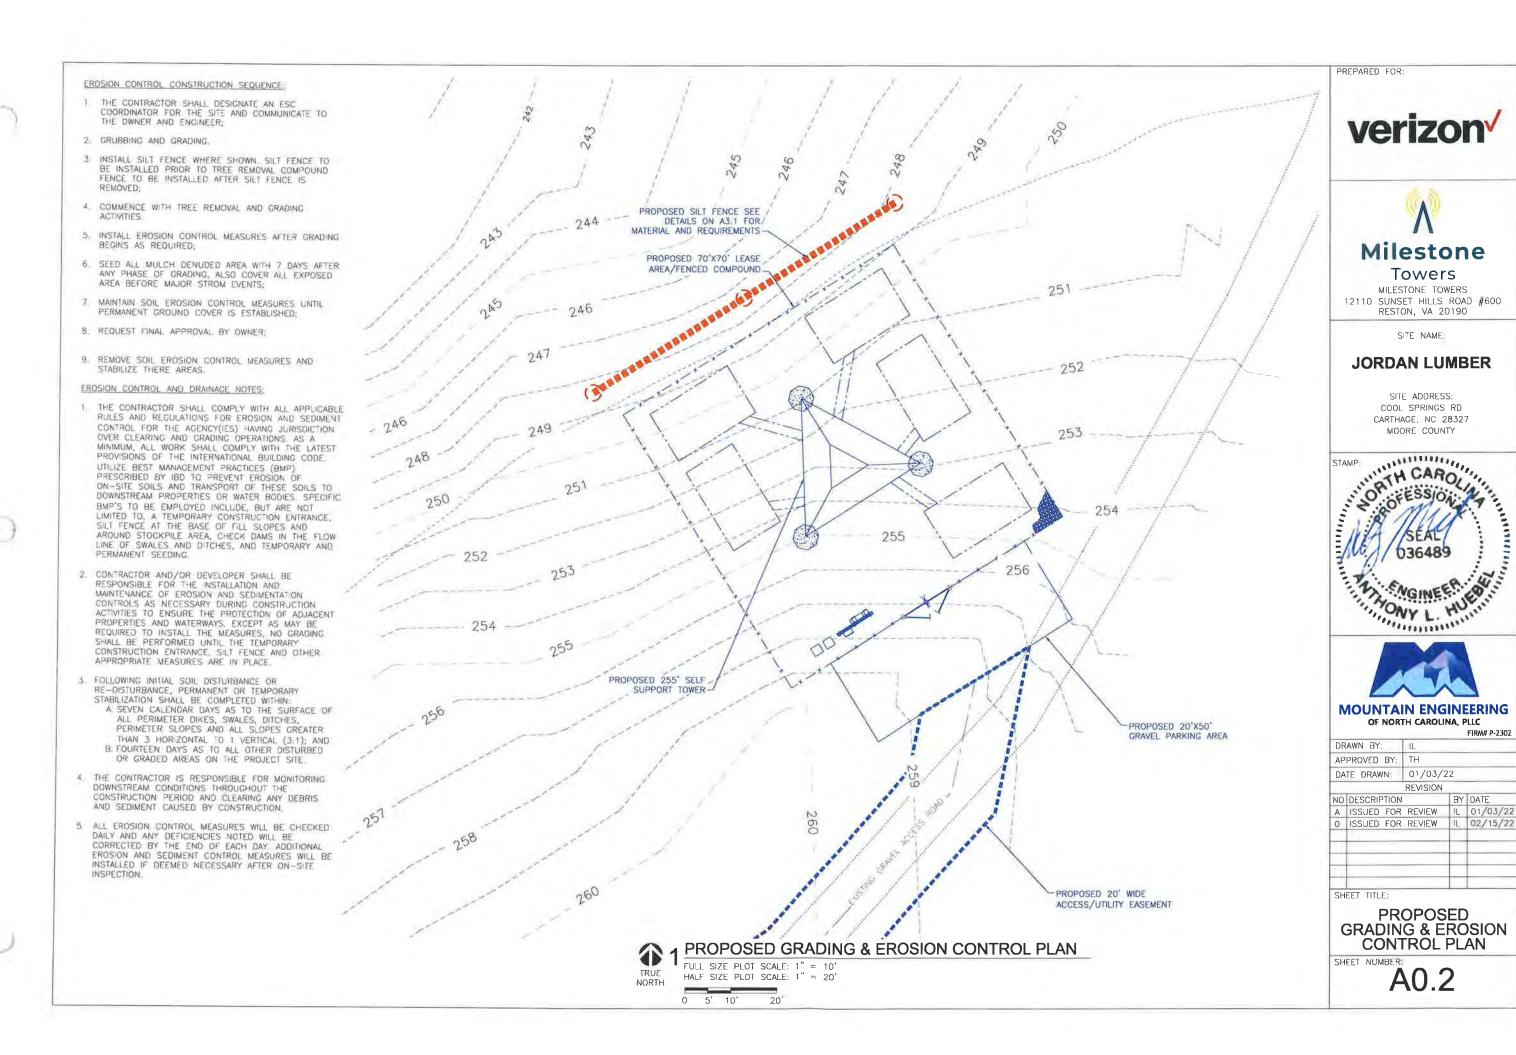

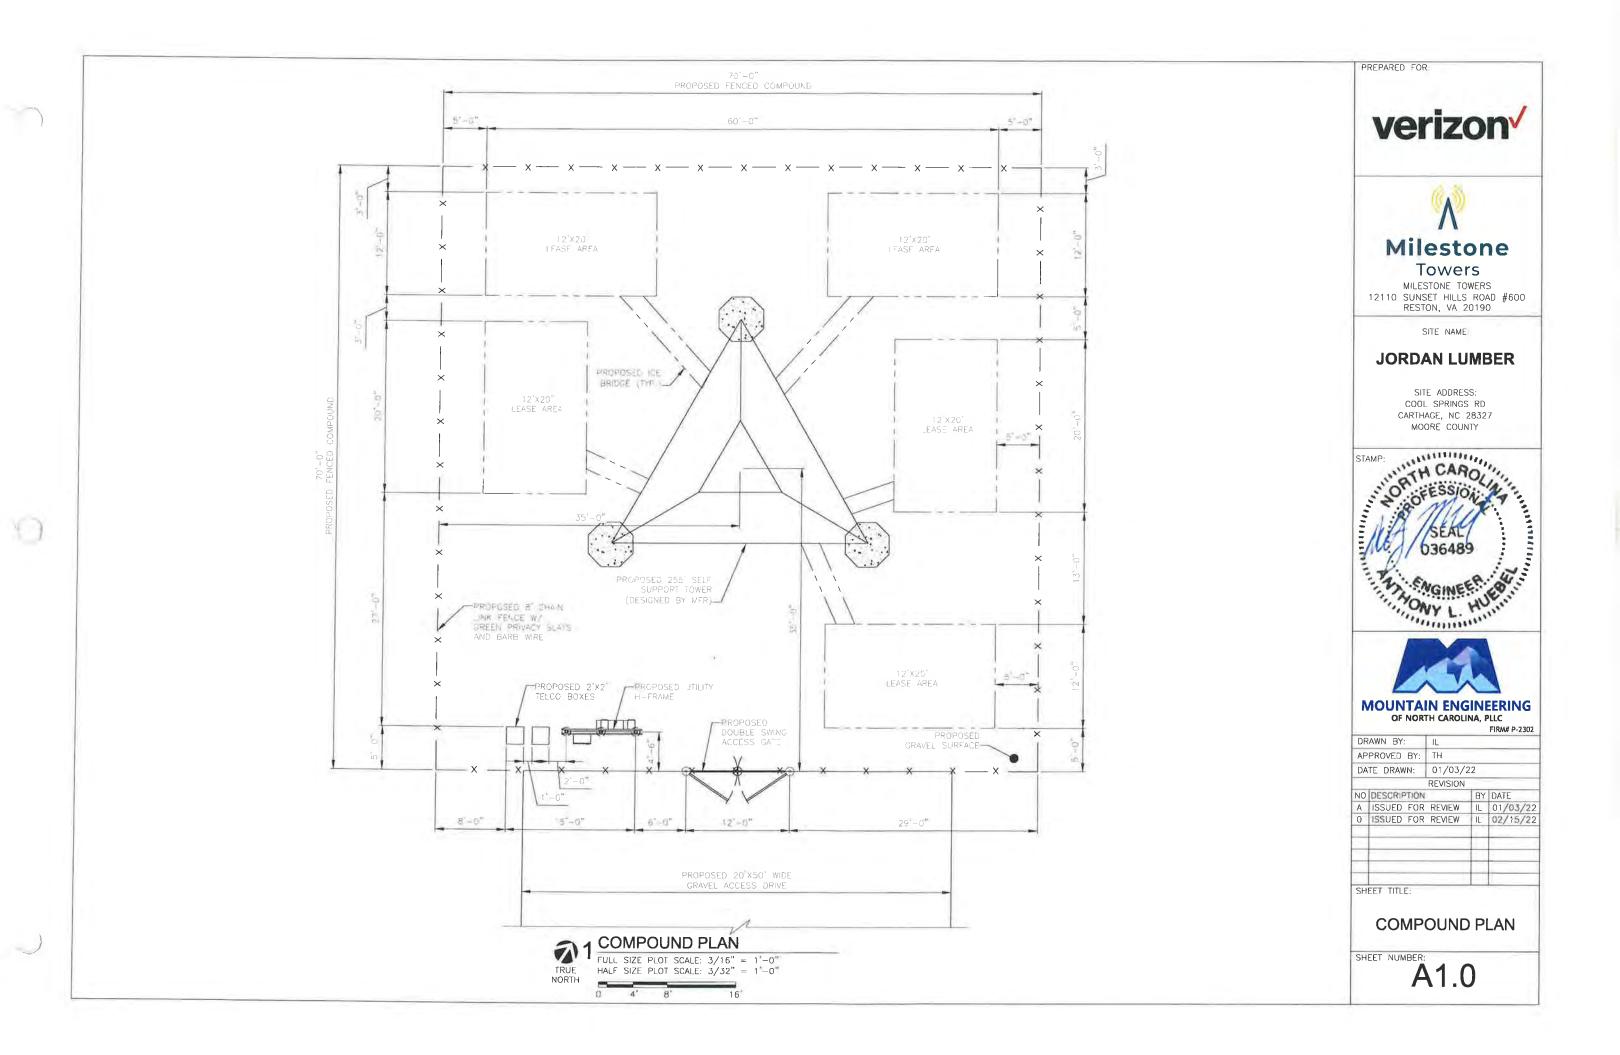

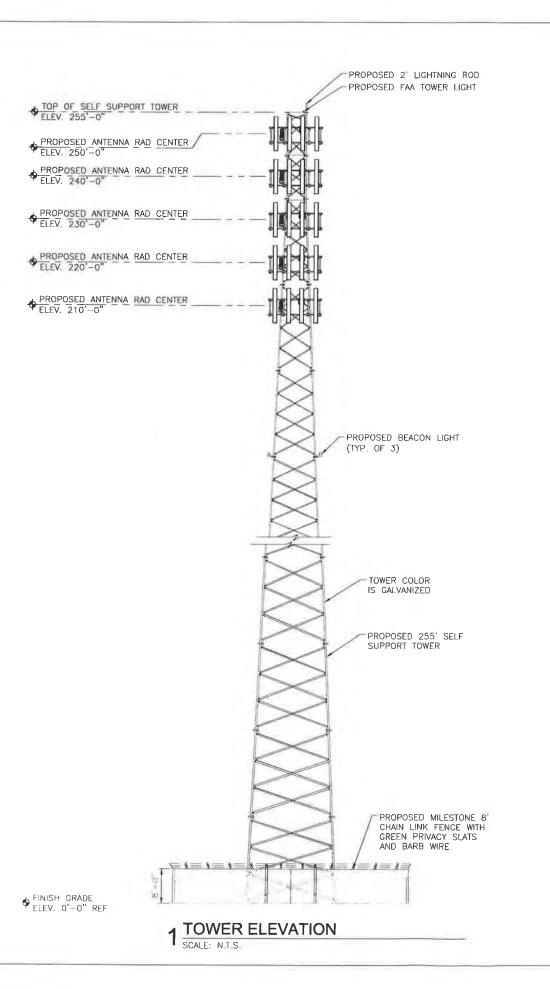

PREPARED FOR:






MILESTONE TOWERS 12110 SUNSET HILLS ROAD #600 RESTON, VA 20190

SITE NAME

JORDAN LUMBER

SITE ADDRESS: COOL SPRINGS RD CARTHAGE, NC 28327 MOORE COUNTY

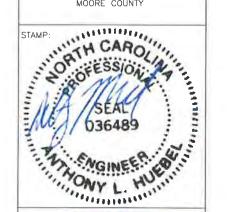



BY: /ED BY: RAWN CRIPTION	IL TH 01/03/ REVISION	22	
RAWN	01/03/ REVISION	22	
	REVISION	22	
CRIPTION			
CRIPTION			
01111		BY	DATE
A ISSUED FOR 0 ISSUED FOR		IL	01/03/22
		IL	02/15/22
	TITI E.	rim F·	ritle:

TOWER ELEVATION

SHEET NUMBER:

A2.0

FOR REGISTRATION REGISTER OF DEEDS
Judy D. Martin
October 01; 2012 10:58:50 AM
Book 4092 Page 40-46
FEE: \$26.00
INSTRUMENT # 2012014314





INSTRUMENT # 2012014314

Excise Tax \$0	Recording Time, Book and Page			
Tax Lot NoParcel Identifier No 0	0003428, 00001312, 00990221			
Verified by County on the	day of			
by				
Mail after recording toRussell J. Hollers, Attorney at La	w, PO Box 567, Troy, NC 27371			
This instrument was prepared byRussell J. Hollers, Atto	orney at Law, P.O. Box 567, Troy, NC 27371			
Brief description for the Index: Tracts 9096, 9129, 9133	- MOORE COUNTY			
NORTH CAROLINA GE	NERAL WARRANTY DEED			
THIS DEED made this 31st day of August, 2012, by and be	etween			
GRANTOR	GRANTEE			
Jordan Four, LLC a North Carolina limited liability company	Jordan Three, LLC a North Carolina limited liability company			
PO Box 98 Mt. Gilead, NC 27306	PO Box 98 Mt. Gilead, NC 27306			
Enter in appropriate block for each: name, address, and, if	appropriate, character of entity, e.q. corporation or partnership			
The designation Grantor and Grantee as used herein shall i assigns, and shall include singular, plural, masculine, feminate the state of the state o	· · · · · · · · · · · · · · · · · · ·			
WITNESSETH, that the Grantor, for a valuable considerat acknowledged, has and by these presents does grant, barga certain lot or parcel of land situated in the Town of, more particularly described as follows:	in, sell and convey unto the Grantee in fee simple, all that			
See Exhibit "A" attached hereto and made a part hereconveyed.	of for a more complete description of the tracts being			
Does the above described property include the primary	y residence? NO			

The property hereinabove described was acquired by Grantor by instrument recorded in Book Page.

A map showing the above described property is recorded in Plat Cabinet Slide

TO HAVE AND TO HOLD the aforesaid lot or parcel of land and all privileges and appurtenances hereto belonging to the Grantee in fee simple; and

The Grantor covenants with the Grantee, that Grantor is seized of the premises in fee simple, has the right to convey the same in fee simple, that title is marketable and free and clear of all encumbrances, and that Grantor will warrant and defend the title against the lawful claims of all persons whomsoever except for the exceptions hereinafter stated. Title to the property hereinabove described is subject to the following exceptions:

Easements and restrictions of record.

IN WITNESS WHEREOF, the Grantor has hereunto set his hand and seal, or if corporate, has caused this instrument to be signed in its corporate name by its duly authorized officer, the day and year first above written.

Jordan Lumber & Supply, Inc., Manager of Jordan Properties, LLC, which is Manager of Jordan Four, LLC

By: Robert B. Jadan, III, President

STATE OF NORTH CAROLINA COUNTY OF MONTGOMERY

I, Sara E. Perez, a Notary Public of the County of Montgomery, State of North Carolina, certify that Robert B. Jordan, III personally came before me this day and acknowledged that he is President of Jordan Lumber & Supply, Inc., which is Manager of Jordan Properties, LLC, which is Manager of Jordan Four, LLC a North Carolina limited liability company, and that he, as President, being authorized to do so, executed the foregoing on instrument on behalf of the limited liability company.

Witness my hand and notarial seal, this 31st day of August, 2012.

tary Public (SEAL)

My commission expires: 4/26/2016

(SEAL)

Tract 9096
Moore County

TRACT 9096

PERMICE STREET

DEEP REVER TOWNSHITE

ičlegg tract

Lying and being in Deep River Township, Moore County, North Carolina, about 8 miles north of the Town of Carthage BEGINNING at the mouth of Widows Branch (also known as Meadow Branch) where said branch empties into McLendons Creek; runs thence up the run of Widows Branch s. 1.97 chains, S. 64-15 E. 7.22 chains, S. 8-45 E. 5.32 chains, S. 79-15 E. 2.95 chains, S. 22-30 E. 1.96 chains, S. 61-30 E. 3.55 chains, S. 31-45 E. 5.09 chains, S. 22-15 E. 3.76 chains, and S. 57 E. 4.3 chains to the Warren line; thence along Warren's line S. 64-45 W., crossing a power line, 61.45 chains to O. T. Parks' corner; thence along Parks' line N. 9-15 W. 19.95 chains to a stake and N. 49-15 E. 48.10 chains to the point or place of BEGINNING, containing 138.0 acres according to plat by C. W. Russum, R.L.S., dated November 1958 entitled "Continental Can Company, Inc. - Colin G. Spencer, Sr. Clegg Tract. " and recorded in Plat Book 6, Page 28, Moore County Registry.

EXCEPTIONS:

Clayg Tract 130 acres

- 1. Subject to right-of-way ensement from II. W. Clegg and wife to Carolina Power & Light Company, dated July 6, 1922, and recorded in Book 86, Page 419.
- 2. Subject to right-of-way easoment from Colin G. Spencer and wife,

 Lena F. Spencer to Carolina Power & Light Company, dated February

 25, 1940 and recorded in Book 150, Page 107
- J. Subject to right-of-way easement from Colin G. Spencer and wife, Lona P. Spencer, to Carolina Power & Light Company, dated March 1, 1949, and recorded in Book 158, Page 435.
- Subject to 60 foot right-of-way to state road as shown on plat

Tract 9129
Moore County

TRACT NO. 9129 -Page 1
HOORE COUNTY, CARTILACE TOWNSHIP
EXHIBIT A

Tragt 1 --

All that certain lot, tract or parcel of land in Carthage Township, Moore County, North Carolina, situated about four miles northwest from the Town of Carthage, and adjoining lands owned or formerly owned by Mrs. Jane Sears Dowd, Jessie L. Sullivan, L. G. Cockman, John Beasley, and others, and State Highway No. 27 from Raleigh to Charlotte and being particularly described as follows:

Deginning at a stake in an old Read on the north side of Highway \$27, running thence N. 80 W. 860 feet to a stake north of the highway; thence N. 75 W. crossing the highway 1980 feet to a stake and rocks on the south 1980 foet to a stake and rocks on the south side of the highway; thence N. 20 E. 66.6 foet to the center of the highway; thence S. 46 W. 1850 feet to a stake in a branch, gum pointers; thence down the various courses of the branch N. 40 W. 1150 feet to a stake in the branch; thence S. 26; W. 1188 feet to a stake in a drain; thence N. 20 W. 851 feet to a stake in a drain; thence N. 1350 feet to a stake; thence S. 32 W. 1537 feet to a stake; thence S. 32 W. 1537 feet to a stone; thence N. 20 W. 1518 feet to a stake; thence S. 32 W. 1537 feet to a stone; thence S. 45 E. 1452 feet to a stone; thence S. 45 W. 231 feet to a stone; thence S. 10 E. 1221 feet to a stone; thence S. 10 E. 1221 feet to a stone; thence S. 10 E. 1221 feet to a stone; thence S. 30 E. 726 feet to a stake on the branch, pine pointers; thence S. 20 E. 891 feet to a stake, maple and degwood pointers; thence S. 30 E. 726 feet to a stake on the bank of MoLondon's Creek, iron wood, sweet gum and white oak pointers; thence down the and white oak pointers; thence down the various courses of the creek 8. 72 E. 200 B. 56 E. 300 B. 70 E. 255 feet 8. 15 W. 283 feet 8. 61 E. 250 feet to the mouth of a ditch. 8. 61 E. 250 feet to the mouth of a ditch, running in to the drock from the south; thence leaving the creek 8, 13 W. 660 feet to a stake; thence 8. 11-30 W. 1670 feet to a stone; thence N. 71 E. 459 feet to a stake; thence 8. 80 E. 459 feet; thence N. 75-15 E. 1500 feet to a stone; thence 8. 13-30 E. 2597 feet to a stone; thence N. 76 E. 2300 feet to Lick Branch; thence down the various courses of said branch N. 75 E. 264 feet to an feet to Lick Branch; thence down the various courses of said branch N. 75 E. 264 feet to an iron stake, gum pointers, a corner of Goodwin's Soars Land N. 36 E. 205 feet to a stone N. 35 E. 427 feet to a rock on the bank of Lick Branch in the old Ballsbury Road, a corner of Lamm's land; thence as to branch N. 20 E. 630 feet N. 3 W. 362 N. 72 W. 156 N. 21 W. 122 N. 47 W. 167 feet N. 1 E. 700 feet N. 161 E. 1150 feet to Spender's corner of the Cardle farm N. 41 W. 250 feet N. 15 E. 330 feet Cagle farm N. 41 W. 250 feet N. 15 E. 330 feet N. 330 foot to Sponcer's other corner; thence leaving the branch N. 761 W. 600 foot to a stone; thence N. 11 W. 1837 foot to the bank of McLendon's Crock; thence down the various courses of the creek E. 132 feet N. 30 E. 255 foot N. 28 W. 170 feet N. 4 W. 452 feet S. 87

TRACT 9129- Page 2

E. 373 fact N. 33 E. 155 feet N. 76 E. 250 feet to Beasley's corner; thence leaving the creek N. 16 W. 231 feet N. 61 W. 115.5 feet N. 8 W. 231 feet N. 20 E. 511.5 feet to a rock; thence N. 68 E. 683 feet to a stake; thence N. 518 feet to a stake, maple pointers; thence N. 16 W. 1132 feet to the beginning, containing 1169 3/4 acres, more or legs.

Saving and axestling-trom to with from Tract 1

Exception 1 -- All that certain tract or parcel of land lying and boing situate in Carthaga Township, Moore County, North Carolina, more particularly described as follows: Beginning at a point on the North side of Highway No. 27 at the Southwest corner of the Bouthwest corner of the Bouthwest care. of the Boyette property; running thouse along the Boyette line N. 14 W. approximately 201 the Hoyatto line N. 14" W. approximately 203 feet to the Person property; thousay along the Person Property; thousay along the Thousay N. approximately 957 feet; Thousay N. 75° W. approximately 1110 feet to the North side of said Highway 27; thousay along the North side of said Highway 27; thousay 10 E. 800 feet; thence 8. 70° 30' E. 1466 feet to the point of beginning; the same containing 8.2 acres, more or less, and being that 8.2 acres, more or less, and being that portion of the Binneywood Tract of land lying and being on the North side of said Highway No. 27; and being a part of the identical real property conveyed unto the said party of the first part by deed of Ocia J. Cagla, et al, dated March 18, 1946, recorded in Book 149 at page 40, Moora Public Registry, reference to wald doed being hereby made for greater certainty of description.

Exception 2 -- All that certain tract or parcel of land lying and being situate in Carthago Township, Moore County, North Carolina, more particularly described as follows: Beginning at a point in the H. Arnold Jackson property line which said point is N. 14° W. 746 feet from an iron stake on the South side of North Carolina Highway No. 27, said stake at said highway being a common corner for the Hennywood tract of land owned by Halifax Paper Company, Inc., and the owned by Halifax Paper Company, Inc. and the owned by Hallian Paper Company, Ind. and the proporty of H. Arnold Jackson; running thence along a new made line 8. 25° E. 587.8 feet to an iron stake in said Jackson line; thence along said Jackson line N. 68° E. 515.8 feet; N. 73° E. 208.2 to an iron stake; thence continuing along said Jackson line N. 58° W. 276 feet; N. 55° W. 237 feet to the point of beginning; said trant containing 3.3 acres. beginning; said tract containing 3.3 acres, more or less and being approximately triangular in shape and being a portion of the Bonnywood Tract of land convoyed unto Halifax Paper Company, Ind. by deed of Ocia J. Caglo, et al, dated March 18, 1946, recorded in nook 149 at page 40, Moore Public Registry.

TRACT 9129- Page 3

EXCEPTION 3:

All that cortain tract or parcel of land lying and being situate in Carthage Township, Honra County, Otato of North Carolina, known as the Porson tract, and being more particularly described as follows:

Reginning at a point on the South wide of Righway No. 27 at or near the Northwest corner of the Bennywood tract of land owned by Halifax Paper Company, Incorporated; running thence along the line of the Bennywood tract U. 20° K. 100 feet; thence 8. 75° E. approximately 600 feet to said Highway No. 27; thence along said Highway No. 27 in a Mosterly direction approximately 675 feet to the point of beginning; the same Containing 1.3 acres, more or loss, and being that portion of the Person land lying on the South side of said Highway No. 27 and which lies immediately to the North of the Northwest corner of the Bennywood tract.

THERE IS ALSO EXCEPTED all lands lying on the East side of the creek which runs through this tract and divides Tracts 9129 and 9130. Tract 9129 consists of the lands lying on the West side of the creek.

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Tract 9133
Moore County

PARCEL 19133

JORDAN LUMBER & SUPPLY, INC.

Lying and being in Carthage Township, Moore County, North Carolina, on the waters of Killett's Crock, and adjoining the lands of B. C. Wallace, the Frank Surley lands (formerly the W. M. Kivett Place), Alex Marley and perhaps others, and bounded and described as follows:

Beginning at the confluence of the Cabo Branch with Killett's Creek and running northwesterly: with the meanderings of Killett's Creek to a point where the Line Branch between B. C. Wallace and this tract of land runs unto Killett's Creek; thence up said Line Branch in an casterly direction to a mulberry tree, same being the west 42 chains to a rock and gum pointers on the bank of the Court House Branch; thence as the Court House Branch in a westerly direction to a point in said and known as the George W. McNeill tract of land; thence South 26 E. 225 feet to a stake; thence S. 75 W. northwesterly with said Killett's Creek to the beginning of land embracing all of what is known as the Daniel Pry W. McNeill land. This being the same lands described and conveyed in a certain deed from John A. Lang, Jr. and husband, Howard Gardner to John A. Lang, Jr. and husband, Howard Gardner to John A. Lang, Sr. and 1952 and recorded in the Office of the Register of Deeds 177, at Page 183 to which reference is hereby made for a

Being the same tract of land convoyed in a deed dated October 29, 1952 from John A. Lang, Sr. and wife, Pauline F. Lang to U. S. Deahl, Jr. and wife, Elizabeth to which reference is hereby made.

Por title reference see Deed Book 891, Page 437, Moore County Registry.

(1) Sixty feet right of way easement in favor of State Highway Countssion Tecorded in 1986 in Book 293, Page 276, Moore County Registry.

Agenda Item: _____ Meeting Date: April 7, 2022

MEMORANDUM TO THE PLANNING BOARD

FROM: Debra Ensminger

Planning and Inspections Director

DATE: March 4, 2022

SUBJECT: Conditional Rezoning Request: Rural Agricultural (RA) to Rural

Agricultural Conditional Zoning (RA-CZ) – Farm Life School Road

PRESENTER: Jaimie Walters

REQUEST

Cellco Partnership d/b/a Verizon Wireless is requesting a Conditional Rezoning from Rural Agricultural (RA) to Rural Agricultural Conditional Zoning (RA-CZ) to construct a 195' monopole tower for a Wireless Communication Facility on an approximately 0.23-acre portion of one parcel of approximately 30.90 acres located on Farm Life School Road, owned by Adult & Teen Challenge of Sandhills, per Deed Book 5101 Page 332 and further described as ParID 00006478 in Moore County Tax Records.

Public notification consisted of publishing a legal notice in the local newspaper for two consecutive weeks, notification by mail to adjacent property owners, and placing public hearing signs on the property.

BACKGROUND

Located on the parent property is Adult and Teen Challenge of Sandhills, a group care facility. Adjacent properties include residential uses and undeveloped properties.

While the parcel does have some freshwater forested/shrub and freshwater pond wetlands, none are located within the rezoning area. The parcel is also within the AE – 1% (100-year) Flood Zone, however the rezoning area is located approximately 370'+/- from the closest boundary. The parcel is located within the Little River (CPF) WS-IIIP Watershed. The submitted application meets all of the UDO requirements in Section 8.101 (Wireless Communications Facility).

COMMUNITY MEETING

The community meeting was conducted at the Moore County Sports Complex Multi-Purpose Room on March 14, 2022, between 1:00pm and 2:00pm. Adjacent properties were notified by certified return receipt mail, sent on March 3, 2022. Please refer to attached report for more details.

CONDITIONAL ZONING (CZ)

Conditional rezoning affords a degree of certainty in land use decisions not possible when rezoning to a general district. Conditional Zoning Districts are established to provide for

flexibility in the development of property while ensuring that the development is compatible with neighboring uses. Pursuant to NCGS 160D-703, conditional zoning districts requires the approval of a rezoning by the Moore County Board of Commissioners and approval of a site-specific development plan allowing for the development of specific land uses.

Parallel conditional zoning districts are restricted to those uses (meaning either one or multiple uses) listed in the corresponding general use zoning district.

The request shall be in compliance with all relevant portions of the UDO, except that variations from these standards may be approved by the Board of Commissioners if the site plan is submitted and determined to be suitable for the request, is consistent with the intent of the standards, and ensures compatibility with land uses on surrounding properties.

Specific additional conditions applicable to the rezoning request may be proposed by the applicant, the Planning Board, or Board of Commissioners. Only those conditions mutually approved by the county and the applicant may be incorporated into the permit requirements. If a proposed condition is unacceptable to the owner, the petition can be withdrawn, and the proposed rezoning cannot go forward. Likewise, if a condition is unacceptable to the Board of Commissioners, the petition can be denied and there is no rezoning.

Per NCGS 160D-703(b), conditions and site-specific standards shall be limited to those that address the conformance of development and use of the site to County ordinances and officially adopted plans and those that address the impacts reasonably expected to be generated by the development or use of the site.

ZONING DISTRICT COMPATIBILITY

The requested rezoning to Rural Agricultural Conditional Zoning (RA-CZ) is consistent with the existing uses located near the property, including residential uses, as the underlying zoning district will remain Rural Agricultural (RA). The surrounding area is zoned Rural Agricultural (RA).

CONSISTENCY WITH THE 2013 MOORE COUNTY LAND USE PLAN

The future land use map identifies the property as Rural Agricultural Classification. The requested zoning to Rural Agricultural Conditional Zoning (RA-CZ) is compatible with the Rural Agricultural Land Use Classification as the underlying district will remain Rural Agricultural (RA) and the request is limited to the wireless communication facility use. Wireless Communication Facility service is in demand in a largely rural area.


The Land Use Plan states the primary use of the Rural Agricultural Land Use Classification is to support rural residential life associated with agricultural uses (e.g., row crops, forestry, horticulture, grazing, poultry, dairy, swine operations, and intensive agricultural uses in certain areas) and other rural activities.

The Moore County Unified Development Ordinance states the Rural Agricultural (RA) district is intended to encourage the continuance of agricultural uses as well as to ensure that residential development of appropriate intensities that are consistent with the suitability of land, availability of public services, and that are compatible with surrounding development, will occur at appropriate densities to provide a healthful environment. The RA District is also intended to

accommodate rural commercial activities where the use of site-specific development plans, individualized development conditions, vegetative buffers, larger lots, and the compatibility of adjacent land uses are considered to provide suitable locations for rural commerce and other rural activities.

The rezoning request aligns with the following recommendation as included in the attached Land Use Plan Consistency Statement, including Action 1.5.2: Support new developments that utilize existing or implement planned infrastructure that most economically preserves open space and important historical, natural and cultural features.

MOORE COUNTY FUTURE LAND USE MAP

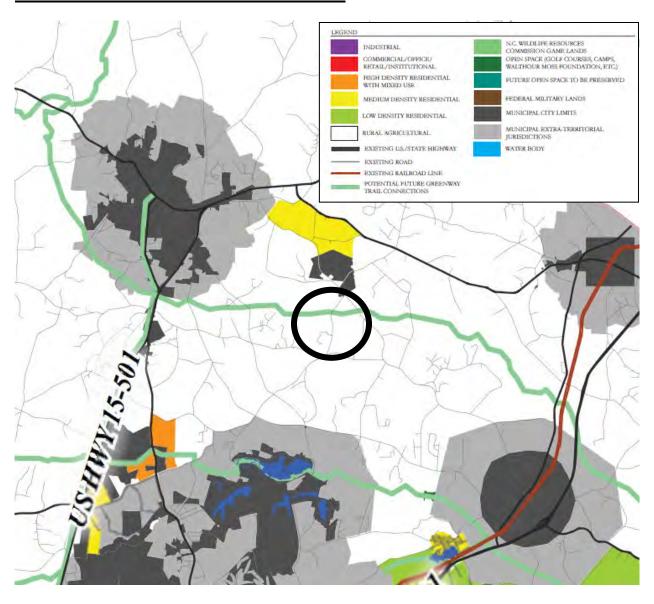

RECOMMENDATION

Staff recommends the Moore County Planning Board make two separate motions:

Motion #1: Make a motion to adopt the attached **Approval** or **Denial** Moore County Planning Board Land Use Plan Consistency Statement and authorize its Chairman to execute the document as required by North Carolina General Statute 160D-604.

Motion #2: Make a motion to recommend **Approval** or **Denial** to the Moore County Board of Commissioners of the Conditional Rezoning from Rural Agricultural (RA) to Rural Agricultural Conditional Zoning (RA-CZ) to construct a 195' monopole tower for a Wireless Communication Facility on an approximately 0.23-acre portion of one parcel of approximately 30.90 acres located on Farm Life School Road, owned by Adult & Teen Challenge of Sandhills, per Deed Book 5101 Page 332 and further described as ParID 00006478 in Moore County Tax Records.

ATTACHMENTS

- Pictures of Property and Adjacent Properties
- Vicinity Map
- Land Use Map
- Zoning Map
- Municipal Zoning Map
- Planning Board Consistency Statement Approval
- Planning Board Consistency Statement Denial
- Submitted Conditional Rezoning Application
- Submitted Wireless Communications Facilities Application
- Submitted Site Specific Development Plan
- Community Meeting Report
- Deed Book 5101 Page 33

View of subject property





Farm Life School Road – Conditional Rezoning – Staff Report



Approximate location of proposed tower on subject property



Farm Life School Road - Conditional Rezoning - Staff Report

Adjacent property – 480 Farm Life School Road



Adjacent property - 417 Farm Life School Road



Farm Life School Road - Conditional Rezoning - Staff Report


Adjacent property - Undeveloped





Adjacent property - Undeveloped




Farm Life School Road – Conditional Rezoning – Staff Report

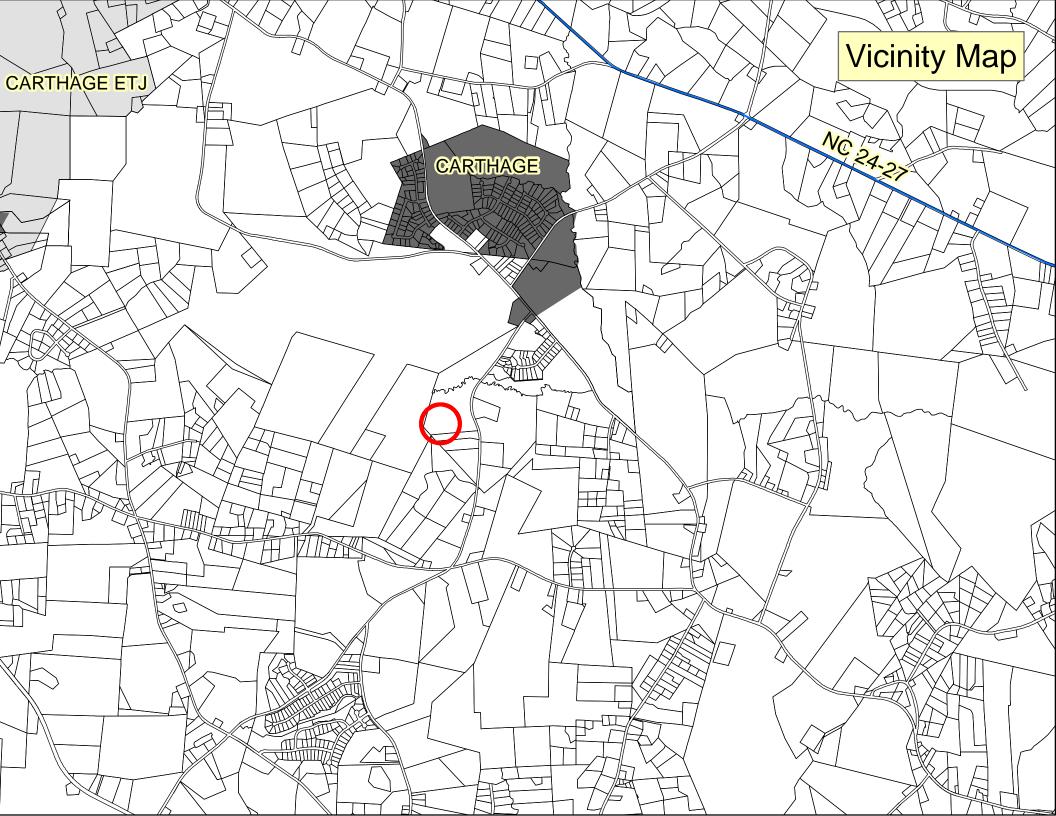

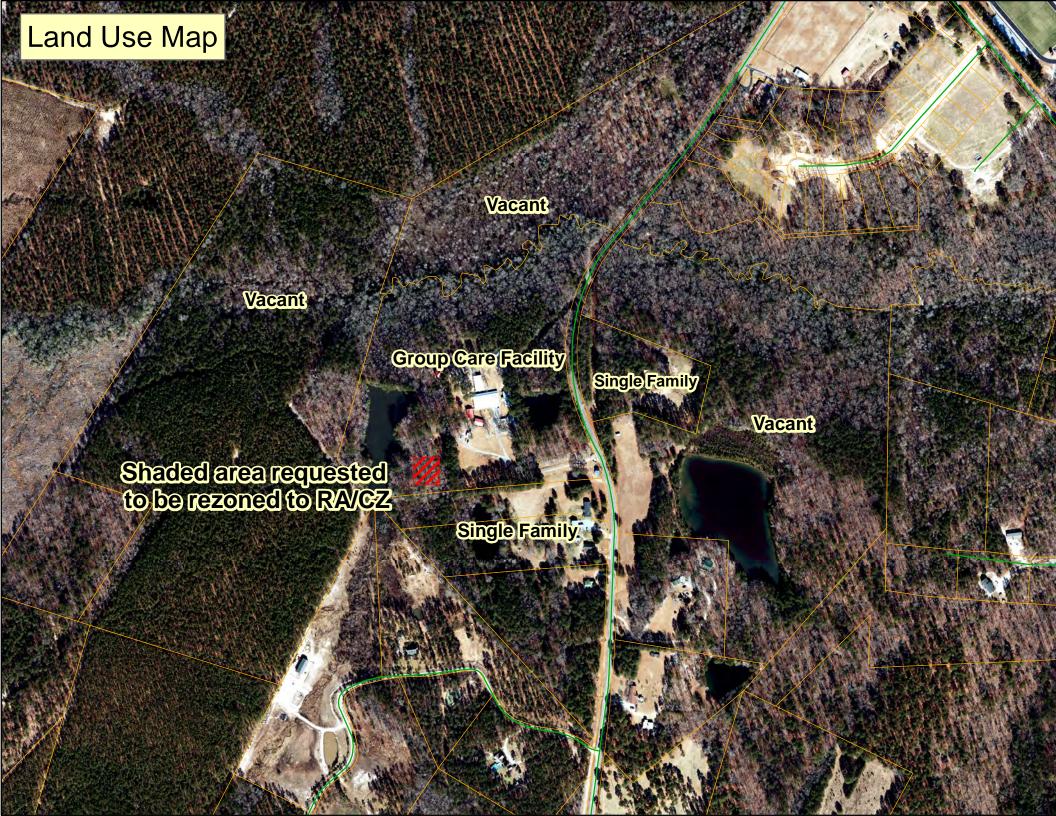

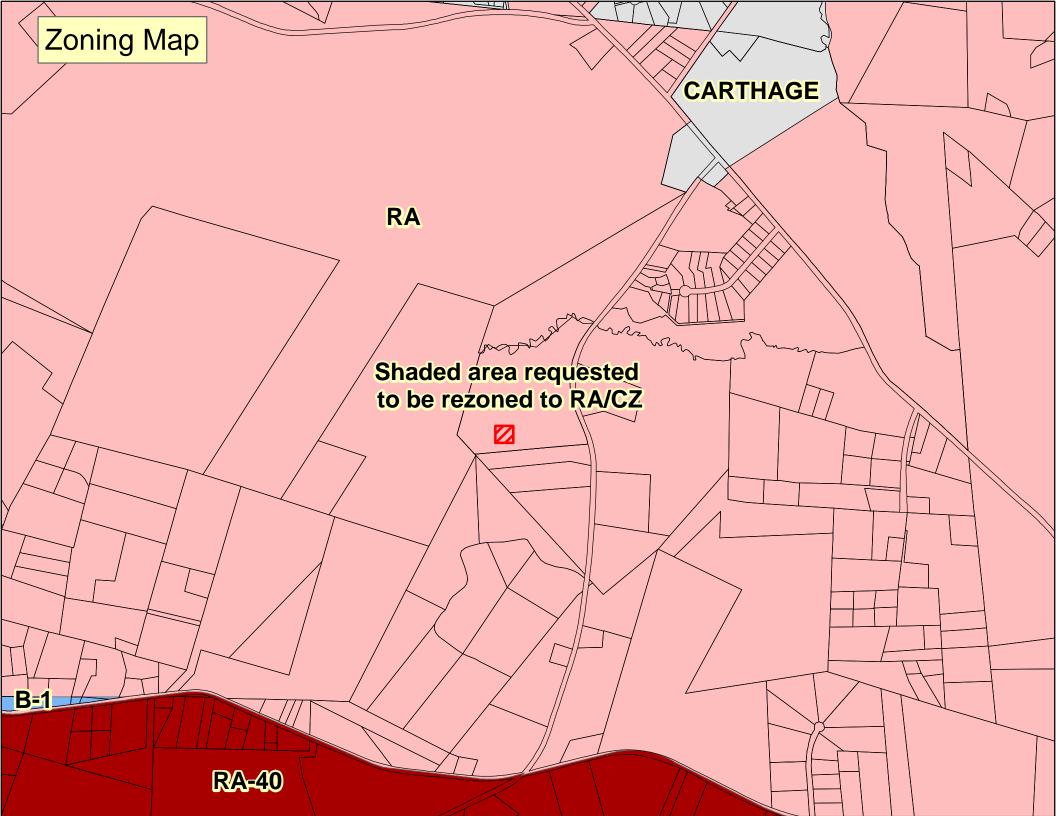

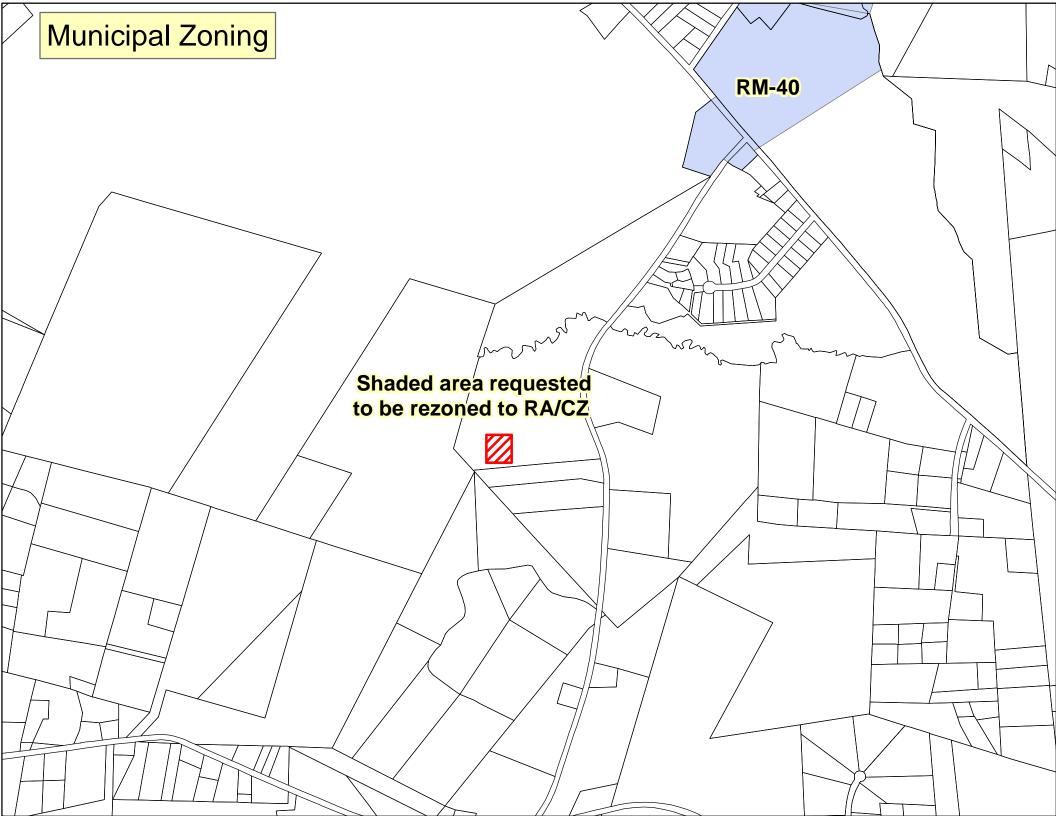

Moore County Planning Board Land Use Plan Consistency Statement Conditional Rezoning Request Rural Agricultural (RA) to Rural Agricultural Conditional Zoning (RA-CZ)

The Moore County Planning Board finds that:

1. The rezoning request is consistent with the following goal as listed in the 2013 Moore County Land Use Plan:

Goal 1: Preserve and Protect the Ambiance and Heritage of the County of Moore (inclusive of areas around the municipalities)

- Action 1.5.2: Support new developments that utilize existing or implement planned infrastructure that most economically preserves open space and important historical, natural and cultural features.
- 2. The rezoning request is reasonable and in the public interest considering the property is located adjacent to existing roads and the underlying zoning district will remain in harmony with surrounding zoning.
- 3. Contributing factors in the rezoning approval are in response to managing the demand of wireless communication service in a largely rural area. This request will also limit the rezoning to maximum area necessary to achieve the development.

Therefore, the Moore County Planning Board recommends **APPROVAL** of the Conditional Rezoning from Rural Agricultural (RA) to Rural Agricultural Conditional Zoning (RA-CZ) to construct a 195′ monopole tower for a Wireless Communication Facility on an approximately 0.23-acre portion of one parcel of approximately 30.90 acres located on Farm Life School Road, owned by Adult & Teen Challenge of Sandhills, per Deed Book 5101 Page 332 and further described as ParID 00006478 in Moore County Tax Records.

Joe Garrison, Chair	Date	
Moore County Planning Board		

Moore County Planning Board Land Use Plan Consistency Statement Conditional Rezoning Request Rural Agricultural (RA) to Rural Agricultural Conditional Zoning (RA-CZ)

The Moore County Planning Board finds that:

1. The rezoning request is consistent with the following goal as listed in the 2013 Moore County Land Use Plan:

Goal 1: Preserve and Protect the Ambiance and Heritage of the County of Moore (inclusive of areas around the municipalities)

- Action 1.5.2: Support new developments that utilize existing or implement planned infrastructure that most economically preserves open space and important historical, natural and cultural features.
- 2. The proposed rezoning is not reasonable and not in the public interest because the proposed rezoning will have an unreasonable impact on the surrounding community.

Therefore, the Moore County Planning Board recommends **DENIAL** of the Conditional Rezoning from Rural Agricultural (RA) to Rural Agricultural Conditional Zoning (RA-CZ) to construct a 195′ monopole tower for a Wireless Communication Facility on an approximately 0.23-acre portion of one parcel of approximately 30.90 acres located on Farm Life School Road, owned by Adult & Teen Challenge of Sandhills, per Deed Book 5101 Page 332 and further described as ParID 00006478 in Moore County Tax Records.

Joe Garrison, Chair	Date	
Moore County Planning Board		



County of Moore Planning and Inspections

Inspections/Permitting: (910) 947-2221 Planning: (910) 947-5010 Fax: (910) 947-1303

Conditional Rezoning Application

Application Date: 2/18/2022			
Address of Property: 444 Farm Life School	Road, Carthage N	С	
Applicant: Cellco Partnership d/b/a Verizon	Phone: 704-577-8785		
Applicant Address: 7821 Research Drive	city: Charlotte	st: NC	zip: 28262
Owner: Adult & Teen Challenge of Sandhil	Phone:	- A AI	
Owner Address: PO Box 1701	City: Southern Pines	St: NC	zip: 28388
Current Zoning District: RA	Proposed Zoning District: R	A	
Current Use(s): Christian faith-based, residential care to young people and adults who struggle with addiction	Proposed Use(s): Wireles	ss Facili	ty
Moore County, NC Ordinance Section 8.101g Moore County, NC Ordinance Section 11.2 Co Moore County, NC Ordinance Section 4 Zonin	onditional Rezoning		
Statement of reasonableness of the proposed conditional zonin 1. The conditional rezoning compatibility with the Count 2. The conditional rezoning compatibility with the existin 3. The benefits and detriments of the conditional rezoning surrounding community. Applicant proposes to install a wireless tele Antenna support structure within a 100'x10 surrounded by a 50'x50' concealment fence topped with three strands of twelve-gauge lecked gate. Said facility will be designed and accessory equipment, and space for Ordinance.	ty Land Use Plan and other adop g land uses on abutting and neigng for the subject property, neight communications facility to 0' leased area compound ce, eight foot in height. Sais barbed wire. Compound to accommedate the apprentices of the second control of the	ted plans of phooring trade to the plans of the property of the plans	the County. cts. perties and the a 195 foot ment o be cured with ntennas

I (We), the undersigned, certify that all statements furnished in this application are true to the best of my (our) knowledge, and do hereby agree to follow all reasonable requests or information as designated by the County of Moore Zoning Administrator.							
Victoria M. Farmer	Digitally signed by Victoria M. Farmer Date: 2022.02.18 12:47:14 -05'00'		_				
Applicant/Owner Signature	Date						
Applicant/Owner Signature		Date	_				
Office Use Only:							
PARID:		21 22 Date	App# 38714				



County of Moore Planning and Inspections

Inspections/Permitting: (910) 947-2221 Planning: (910) 947-5010 Fax: (910) 947-1303

WIRELESS COMMUNICATION FACILITIES (WCF) FREESTANDING NON-CONCEALED

Applicant Information			
Applicant Name: Cellco Partnership d/b/a Veri	<u>izon Wireless</u> Contact Na	ıme: <u>Victoria M. Farmer</u>	
Address: <u>7821 Research Dr.</u> City: <u>Charlotte</u>		_State: <u>NC_Zip: 28262</u>	
Office Phone: 704-577-8785			
Contact Phone: (V. Farmer) 423-802-7847 em	ı <mark>ail: <u>Victoria.Farmer@fa</u>l.</mark>	ulkandfoster.com	
Applicant Classification: X Commercial Wireless	Provider 🗆 Government	tal User 🛘 Private Business User	
Is this a joint application by two or more wireless	service providers? 🗆 YES	ON X NO	
If this is a joint application, please attach contact	at information for each a	ıdditional applicant.	
Parcel Information	-1. DA		
ParID #: 859600471781 Zoning Distric			
Address: 444 Farm Life School Road City:Car	inage	/ip: <u>2832/</u>	
Landowner Information			
Landowner Name: Adult & Teen Challenge of	Sandhills Phone: 910-	-947-2944	
Address: P.O. Box 1701 City: Southern Pin-	es, NC	_ Zip: <u>28388</u>	
WCF Owner Information			
Owner Name: Cellco Partnership d/b/a Verizor	Nireless Contact Name	e: Victoria M. Farmer	
Address: <u>7821 Research Dr.</u> City: <u>Charlotte</u>			
Office Disease 704 577 0705			
Contact Phone: (V. Farmer) 423-802-7847			
Email: <u>Victoria.Farmer@faulkandfoster.com</u>			
WCF Facility Information	City: Carthago	State: NC Zip <u>28388</u>	
Street Address: 444 Farm Life School Rd			
Latitude: <u>35° 18' 30.40" N</u>	Longitude: 79° 21' 19.10" W Ground elevation (ASML: 372'		
Support structure height: 195-ft.	Ground elevation (As	IVIL. <u>57.2</u>	
Support structure description: X Monopole	Rooftop 🗆 Self Supportin	g Lattice Tower 🛮 Guyed Tower	
Height of proposed co-location (AGL):195-ft + 4			
Number of co-location slots available: applican	ıt plus three additional te	enants	



County of Moore Planning and Inspections

Inspections/Permitting: (910) 947-2221 Planning: (910) 947-5010 Fax: (910) 947-1303

APPLICATION REQUIREMENTS

Please check each item per the Moore County Unified Development Ordinance Section 8.101(B):

- Site Plan. In addition to the site plan requirements per Section 4.2, the following shall be included: details of existing and proposed facilities and fall zone radius labeled "NO BUILD ZONE."
- Radio Frequency. A statement from a registered engineer that the WCF will be maintained and operated in accordance with all applicable Federal Communications Commission (FCC) rules regarding radio frequency emissions and interference and if there is interference with public safety communications, the applicant shall utilize procedures set forth by the FCC and the party causing the interference shall reimburse the County for all costs associated with resolving the interference.
- Structural Analysis. Signed and sealed by a NC Registered Professional Engineer that the support structure upon completion of the applicant's installation has the structural integrity to accommodate the proposed equipment and complies with all applicable Federal and State building, fire, structural, electrical, and safety codes.
- Lighting. Applicant shall provide documentation that lighting shall not exceed the Federal Aviation Administration (FAA) minimum standards (minimum intensity and longest duration between flashes) and shall utilize allowed downward shielding to minimize visual impact to pedestrians and reduce the potential attraction to migratory birds. Strobe lights during daylight hours and red lights during nighttime hours unless specifically prohibited by the FAA. A WCF may utilize a security light controlled by a motion-detector sensor at or near the entrance to the facility.
- Owner Authorization. Proof that a property and/or antenna support structure owner's agent has appropriate authorization to act upon the owner's behalf if applicable.
- Insurance. Proof of certificates of insurance of general liability insurance in the amount of at least \$1,000,000 covering any liability arising out of its construction or operation of the WCF.
- Bond. Applicant shall submit a performance bond or letter of credit from an accepted bank in the amount of \$20,000 or a bond equal to the written estimate from a qualified tower removal contractor to guarantee that the facility will be removed when no longer in use.
- □ US Fish and Wildlife Service submitted information, if applicable.
 □ National Environmental Policy Act (NEPA) checklist, if applicable.
 □ State Historic Preservation Office (SHPO) letter, if applicable.
 □ Yes □ No
 □ Federal Aviation Administration (FAA) approval, if applicable.
 □ Yes □ No
- Buffer. Refer to Section 7.11. Grading shall be limited to necessary area.
- Minimum Antennas. Wireless support structures (WSS) up to 80 feet –2 antennas minimum. WSS between 81 and 100 feet 3 antennas minimum. WSS 101 and 125 feet 4 antennas minimum. WSS 126 feet or taller 5 antennas minimum.
- Safety. All support structures shall be certified to comply with the safety standards contained in the Electronics Industries Association /Telecommunications Industries Association (EIA/TIA) document 222-F, or current standard, "Structural Standards For Steel Antenna Towers and Supporting Structures," or current standard, as amended, by a Registered North Carolina Professional Engineer. The use shall be totally enclosed by a security fence a minimum (6) feet high with 3-strand barbed wire or razor wire.



County of Moore Planning and Inspections

Inspections/Permitting: (910) 947-2221 Planning: (910) 947-5010 Fax: (910) 947-1303

- Setbacks. One foot for every 1 foot in linear height from any property line. WCF shall be a minimum 2,640 feet from any designated National Register of Historic Places.
- Height. Any WSS shall be 195 feet or less in height. The Moore County Board of Commissioners may permit a taller tower only if undisputable evidence is provided at application that the WCF service area will be so substantially compromised that there would be a requirement of additional WCFs within a distance of two (2) miles.
- <u>Necessity</u>. For all new WSS applications, a certification from the applicant's RF engineer that it is not reasonably feasible (technically or commercially impractical or the owner of the WSS is unwilling to enter a contract at fair market value) to co-locate new antennas and equipment on an existing WSS within the geographic search area.

I (We), the undersigned, certify (our) knowledge, and do hereb County of Moore Zoning Adminis	y agree to follow all reasonable		
Victoria M. Farmer	Digitally signed by Victoria M. Farmer Date: 2022.02.18 12:48:25 -05'00'		
Applicant/Owner Signature		Date	
Applicant/Owner Signature		Date	
Office Use Only:			,
PARID:	Jes .	2 2 2 2 Date	App# 38714



To: Moore County Jurisdiction

RE: Verizon Wireless Site #431713 (Swallowtail)

Site Located at: 444 Farm Life School Road/Parcel ID: 859600471781

To Whom It May Concern,

We write to inform you that Verizon Wireless Pursuant to Chapter 8, Section 8.101 B.2 of the Moore County, NC Ordinance has performed a radio frequency (RF) compliance pre-construction evaluation for the above-noted proposed site and based on the result of the evaluation, the site will be compliant with FCC Guidelines.

The FCC has established safety rules relating to potential RF exposure from cell sites. The rules are codified at 47 C.F.R § 1.1310. The FCC provides guidance on how to ensure compliance with its rules in the FCC Office of Engineering and Technology Bulletin 65 (available at

https://transition.fcc.gov/Bureaus/Engineering Technology/Documents/bulletins/oet65/oet65.pdf). The FCC developed the RF standards, known as Maximum Permissible Exposure (MPE) limits, in consultation with numerous other federal agencies, including the Environmental Protection Agency, the Food and Drug Administration, and the Occupational Safety and Health Administration. The FCC provides information about the safety of radio frequency (RF) emissions from cell towers on its website at:

 $\underline{https://www.fcc.gov/engineering-technology/electromagnetic-compatibility-division/radio-frequency-safety/faq/rf-safety.}$

Please refer to the FCC Office of Engineering and Technology Bulletin 65 and the attached Verizon Wireless RF Brochure for information on RF exposure guidelines, RF safety, and landlord responsibilities. Questions related to compliance with federal regulations should be directed to VZWRFCompliance@VerizonWireless.com.

Please contact your local Verizon Wireless resource below if you have additional site-specific questions.

Contact Name	Contact Email	Contact Phone	
Kelly Quate	Kelly.quate@verizonwireless.com	7045745273	

Sincerely,

Jignesh Choksi Manager-RF System Design Verizon Wireless



January 14, 2022

Chris Starks Verizon Wireless 1101 Matthews Mint Hill Road Matthews, NC 28105

RE: Proposed 195' Sabre Monopole for Swallowtail, NC

Dear Mr. Starks,

Upon receipt of order, we propose to design and supply the above-referenced Sabre monopole for a Basic Wind Speed of 116 mph without ice and 30 mph with 1.5" ice, Structure Classification II, Exposure Category C, and Topographic Category 1, in accordance with the Telecommunications Industry Association Standard ANSI/TIA 222-G "Structural Standards for Steel Antenna Towers and Antenna-Supporting Structures", using structural steel.

When designed according to this standard, the wind pressures and steel strength capacities include several safety factors. Therefore, it is highly unlikely that the monopole will fail structurally in a wind event where the design wind speed is exceeded within the range of the built-in safety factors.

Should the wind speed increase beyond the capacity of the built-in safety factors, to the point of failure of one or more structural elements, the most likely location of the failure would be within the monopole shaft, above the base plate. Assuming that the wind pressure profile is similar to that used to design the monopole, the monopole will buckle at the location of the highest combined stress ratio within the monopole shaft. This is likely to result in the portion above the highest stress leaning over and remaining in a permanently deformed condition. This would effectively result in a fall radius of 45'. *Please note that this letter only applies to the above-referenced monopole designed and manufactured by Sabre Industries.*

Sincerely,

David Hill, P.E. Design Engineer II SEAL 051984

OFESSION 2

WILLIAM OF THE STATE OF THE STAT

1/14/22



Phone 704 510-8500

APPLICATION BY CELLCO PARTNERSHIP d/b/a VERIZON WIRELESS FOR THE INSTALLATION OF TELECOMMUNICATIONS FACILITY SWALLOWTAIL #431713

Deborah Ensminger, Planning and Transportation Director County of Moore, NC 1048 Carthage Oaks Drive Carthage, NC 28327

PH: 910-947-5010

Subject: Telecommunications Facility Proposal by

Verizon Wireless Site #431713 (Swallowtail) Moore County, NC Conditional Rezoning

444 FARM LIFE SCHOOL ROAD Parcel ID: 859600471781

Adult & Teen Challenge of Sandhills, by its authorized representative, and owner of real estate identified above, hereby authorize Verizon Wireless to submit an application to Moore County, NC Planning & Zoning Department for the purpose of obtaining all necessary zoning and development permits for the installation of a wireless telecommunications facility consisting of a 195-foot antenna support structure to be erected on the subject property, within a leased area of 100'x100'. Said facility to be surrounded by a 50'x50' fence and include a graveled access & utility easement for ingress/egress.

ADULT & TEEN CHALLENGE OF SANDHILLS

Its: Russell Cambria

By:

Authorized Representative

Date: 11/10/2021





Verizon Wireless 8921 Research Drive Charlotte, North Carolina 28262

Phone 704 510-8500

APPLICATION FOR ZONING APPROVAL BY CELLCO PARTNERHSIP d/b/a **VERIZON WIRELESS FOR THE** INSTALLATION OF WIRELESS COMMUNICATION EQUIPMENT

Deborah Ensminger, Planning and Transportation Director County of Moore, NC 1048 Carthage Oaks Drive Carthage, NC 28327 PH: 910-947-5010

Subject:

Telecommunications Facility Proposal by Verizon Wireless Site #431713 (Swallowtail) Moore County, NC Conditional Rezoning 444 FARM LIFE SCHOOL ROAD

Parcel ID: 859600471781

Pursuant to Chapter 8, Section 8.101 C.6 of the Moore County, NC Ordinance governing Wireless Telecommunication Facilities, Cellco Partnership d/b/a Verizon Wireless, by its representative, provides this statement of compliance to confirm no commercial structures currently exist within the geographic search area for this proposed wireless communications facility along 444 Farm Life School Road.

Respectfully submitted, Chase Real Estate Services

Representative for Verizon Wireless

Date: 11-10-2021

ACORD

CERTIFICATE OF LIABILITY INSURANCE

DATE(MM/DD/YYYY) 11/10/2021

THIS CERTIFICATE IS ISSUED AS A MATTER OF INFORMATION ONLY AND CONFERS NO RIGHTS UPON THE CERTIFICATE HOLDER. THIS CERTIFICATE DOES NOT AFFIRMATIVELY OR NEGATIVELY AMEND, EXTEND OR ALTER THE COVERAGE AFFORDED BY THE POLICIES BELOW. THIS CERTIFICATE OF INSURANCE DOES NOT CONSTITUTE A CONTRACT BETWEEN THE ISSUING INSURER(S), REPRESENTATIVE OR PRODUCER, AND THE CERTIFICATE HOLDER. IMPORTANT: If the certificate holder is an ADDITIONAL INSURED, the policy(ies) must have ADDITIONAL INSURED provisions or be endorsed. Holder Identifier if SUBROGATION IS WAIVED, subject to the terms and conditions of the policy, certain policies may require an endorsement. A statement on this certificate does not confer rights to the certificate holder in lieu of such endorsement(s). CONTACT NAME: Aon Risk Services Northeast, Inc. PHONE (A/C. No. Ext): (866) 283-7122 FAX (A/C. No.): (800) 363-0105 New York NY Office One Liberty Plaza 165 Broadway, Suite 3201 New York NY 10006 USA E-MAIL ADDRESS: INSURER(S) AFFORDING COVERAGE NAIC # 19399 AIU Insurance Company INSURER A: INSURED Verizon Wireless, LLC 1095 Avenue of the Americas New York NY 10036 USA National Union Fire Ins Co of Pittsburgh 19445 INSURER B INSURER C: INSURER D INSURER E: INSURER F: 570090247877 REVISION NUMBER: COVERAGES **CERTIFICATE NUMBER:** THIS IS TO CERTIFY THAT THE POLICIES OF INSURANCE LISTED BELOW HAVE BEEN ISSUED TO THE INSURED NAMED ABOVE FOR THE POLICY PERIOD INDICATED. NOTWITHSTANDING ANY REQUIREMENT, TERM OR CONDITION OF ANY CONTRACT OR OTHER DOCUMENT WITH RESPECT TO WHICH THIS CERTIFICATE MAY BE ISSUED OR MAY PERTAIN, THE INSURANCE AFFORDED BY THE POLICIES DESCRIBED HEREIN IS SUBJECT TO ALL THE TERMS, Limits shown are as requested POLICY EFF POLICY EXP (MM/DD/YYYY) INSR ADDL SUBR LIMITS TYPE OF INSURANCE POLICY NUMBER 06/30/2021 06/30/2022 EACH OCCURRENCE 1728890 \$1,000,000 COMMERCIAL GENERAL LIABILITY Х DAMAGE TO RENTED \$2,000,000 CLAIMS-MADE X OCCUR PREMISES (Ea occurrence) \$10,000 MED EXP (Any one person) Х XCU Coverage is Included \$1,000,000 PERSONAL & ADV INJURY GENERAL AGGREGATE \$2,000,000 GEN'L AGGREGATE LIMIT APPLIES PER: \$2,000,000 PRODUCTS - COMP/OP AGG POLICY JECT OTHER COMBINED SINGLE LIMIT (Ea accident) AUTOMOBILE LIABILITY BODILY INJURY (Per person) ANY AUTO Certificate No BODILY INJURY (Per accident) SCHEDULED AUTOS OWNED AUTOS ONLY PROPERTY DAMAGE (Per accident) NON-OWNED AUTOS ONLY HIRED AUTOS FACH OCCURRENCE UMBRELLA LIAB OCCUR AGGREGATE EXCESS LIAB CLAIMS-MADE DED RETENTION 06/30/2021 06/30/2022 PER STATUTE 16393209 OTH-WORKERS COMPENSATION AND EMPLOYERS' LIABILITY Х AOS \$1,000,000 ANY PROPRIETOR / PARTNER / EXECUTIVE OFFICER/MEMBER (Mandatory in NH) E.L. EACH ACCIDENT 06/30/2021 06/30/2022 N N/A 16393206 \$1,000,000 E.L. DISEASE-EA EMPLOYEE \$1,000,000 If yes, describe under DESCRIPTION OF OPERATIONS below E.L. DISEASE-POLICY LIMIT DESCRIPTION OF OPERATIONS / LOCATIONS / VEHICLES (ACORD 101, Additional Remarks Schedule, may be attached if more space is required) RE: Verizon Site Name: Swallowtail, Joel Rd., Carthage, NC 28327, Location Code: 431713. Moore County Planning and Transportation is included as an Additional Insured with respect to the General Liability policy.

CERTIFICATE HOLDER

CANCELLATION

SHOULD ANY OF THE ABOVE DESCRIBED POLICIES BE CANCELLED BEFORE THE EXPIRATION DATE THEREOF, NOTICE WILL BE DELIVERED IN ACCORDANCE WITH THE POLICY PROVISIONS.

Moore County Planning and Transportation Attn: Deborah Ensminger, Director 1048 Carriage Oaks Drive Carthage NC 28327 USA

AUTHORIZED REPRESENTATIVE

Son Risk Services Northeast Inc

AGENCY CUSTOMER ID: 570000027366

LOC #:



ADDITIONAL REMARKS SCHEDULE

		ווטטר	10	IAVE IZEINVIZI	13 3CHED	OLL		Page _ of .
AGEN	cy Risk Services Northea	ast, Inc			NAMED INSURED Verizon Wirel	ess, LLC	-	
	YNUMBER Certificate Numbe	57009024	7877		1			
CARRI		7000024	7077	NAIC CODE	EFFECTIVE DATE:			
	OITIONAL REMARKS	7009024	7877		EFFECTIVE DATE.			
	ADDITIONAL REMARKS FORM	IS A SCHE	DULE	TO ACORD FORM,				
FOR	M NUMBER: ACORD 25	FORM TIT	LE:	Certificate of Liability Insura	ince			
	INSURER(S) A	FFORDIN	IG C	OVERAGE	NAIC#			
INSU	TRER							
INSU	RER							
INSU	RER							
INSU	RER							
AD				does not include limit inform or policy limits.	nation, refer to the cor	responding policy	on the ACORD	
INSR LTR	TYPE OF INSURANCE	ADDL INSD	SUBR WVD	POLICY NUMBER	POLICY EFFECTIVE DATE	POLICY EXPIRATION DATE (MM/DD/YYYY)	LIMI	rs
	WORKERS COMPENSATION				(MM/DD/TTTT)			
Α	2	N/A		16393207 NY	06/30/2021	06/30/2022		
Α		N/A		16393208 MA,ND,OH,WI,WY	06/30/2021	06/30/2022		
Α		N/A		16393205 NJ,TX,VA	06/30/2021	06/30/2022		
							y 1	

TOWER / STRUCTURE / ANTENNA/ EQUIPMENT REMOVAL BOND

Bond #CMS0346710

Site Name: Swallowtail

Site Location: Joel Road, Carthage, NC 28327

Verizon Project #: 16145746

Verizon Tower Location Code: 431713

KNOW ALL MEN BY THESE PRESENTS, THAT, <u>Cellco Partnership</u>, as Principal, and <u>RLI Insurance Company</u>, a corporation duly organized under the laws of the State of <u>Illinois</u>, as Surety, are held and firmly bound unto <u>Moore County</u>, <u>1048 Carriage Oaks Drive</u>, <u>Carthage</u>, <u>NC 28327</u>, as Obligee, in the sum of <u>Twenty Thousand and 00/100</u> (\$20,000.00) lawful money of the United States, for the payment of which, well and truly to be made, we bind ourselves, our heirs, executors, administrators, successors and assigns, jointly and severally, firmly by these presents, the liability of the Surety being limited to the penal sum of this bond regardless of the number of years the bond is in effect.

WHEREAS the Principal has entered into a written agreement with the property owner for the placement of a tower(s), structure(s), antenna(s), and/or equipment furnishing telephone, television or other electronic media service, which agreement sets forth the terms and conditions which govern the use of such tower(s), structure(s), antenna(s), and/or equipment and which agreement is hereby specifically referred to and made part hereof, and

WHEREAS, the Obligee requires the submission of a bond guaranteeing the maintenance, replacement, removal or relocation of said tower(s), structure(s), antenna(s), and/or equipment.

NOW THEREFORE, the condition of this obligation is such, that if the above bounden Principal shall perform in accordance with the aforesaid ordinance and/or agreement, and indemnify the Obligee against all loss caused by Principal's breach of any ordinance or agreement relating to maintenance, replacement, removal or relocation of a tower(s), structure(s), antenna(s), and/or equipment, then this obligation shall be void, otherwise to remain in full force and effect unless cancelled as set forth below.

THIS BOND may be cancelled by Surety by giving thirty (30) days written notice to the Obligee by certified mail. Such cancellation shall not affect any liability the Surety may have or incurred under this bond prior to the effective date of the termination. Provided that no action, suit or proceeding shall be maintained against the Surety on this bond unless action is brought within twelve (12) months of the cancellation date of this bond.

THIS BOND signed, sealed, dated on the <u>9th</u> day of <u>November</u>, <u>2021</u>. This bond is effective the <u>9th</u> day of <u>November</u>, <u>2021</u>.

Cellco Partnership

Principal

by.

RLI Insurance Company

Surety

Leah L. Juenger, Attorney-Jn-Fact

POWER OF ATTORNEY

RLI Insurance Company Contractors Bonding and Insurance Company

9025 N. Lindbergh Dr. Peoria, IL 61615 Phone: 800-645-2402

Bond No.	CMS0346710
Dona Ivo.	

Know All Men by '	These	Presents:
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That this Power of Attorney is not valid or in effect unless attached to the bond which it authorizes, but may be detached by the approving officer if desired.

	Attorney may be effectively, required for the ap		both of RLI Insurance	Company and	Contractors Bonding and
each authorized an	장면에 그리는 이 바람이 아무슨 아이들이 없다.	ss in all states and the Distr	(1946년) 회사 기업 등 (1947년) 기업 (1947년)	by make, const	
acknowledge and	deliver for and on its		l, any and all bonds and	d undertakings	in an amount not to exceed cribed bond.
Principal:		Ce	llco Partnership		
Obligee:			Moore County		
following is a true to-wit:	e and exact copy of a		e Board of Directors of	each such cor	poration, and now in force,
corporate name or by such othe Assistant Secret policies or under the corporate so	e of the Corporation I er officers as the Bo tary, or the Treasure ertakings in the name akings, Powers of Att eal may be printed by HEREOF, RLI Insura	by the President, Secretary and of Directors may autor may appoint Attorneys of the Corporation. The torney or other obligation facsimile or other electro	y, any Assistant Secret thorize. The Presiden in Fact or Agents wh corporate seal is not n is of the Corporation. nic image."	ary, Treasurer t, any Vice Pr to shall have a tecessary for the The signature	r, or any Vice President, resident, Secretary, any uthority to issue bonds, ne validity of any bonds, of any such officer and ompany, as applicable, have
November ,	2021	AND STREET	RLI Insurance C		
		SEAL SEAL	Contractors Bon B. 74 W	ding and Insu	ance Company
State of Illinois	7 00	(CINO)2	Barton W. Davis		Vice President
County of Peoria	} ss			CERTIF	ICATE
Attorney as the afor Contractors Bondi	ppeared Bar worn, acknowledged that resaid officer of the RL	, 2021, before me, a Notar ton W. Davis , wh he signed the above Power of I Insurance Company and/of upany, and acknowledged said f said corporation.	Contractors Bondi that the attached Po irrevocable; and fur set forth in the Po whereof, I have he	ng and Insurar wer of Attorney thermore, that the wer of Attorney creunto set my my and/or Contr	I Insurance Company and/or the Company, do hereby certify is in full force and effect and is the Resolution of the Company as is now in force. In testimony hand and the seal of the RLI actors Bonding and Insurance November , 2021.
Jacque ine M. Bo	ock er	Notary Pub	lie RLI Insurance Cor Contractors Bondin		e Company
	OFFICIAL SEA JACQUELINE M BO NOTARY PUBLIC, STATE O MY COMMISSION EXPIRES J	OCKLER OF ILLINOIS		Juy D J	

A00AID19

*************** Federal Airways & Airspace Summary Report: New Construction Antenna Structure ************ Airspace User: Not Identified File: SWALLOWTAIL Location: Whispering Pines, NC Latitude: 35°-18'-30.4" Longitude: 79°-21'-19.1" SITE ELEVATION AMSL.....372.2 ft. STRUCTURE HEIGHT.....199 ft. OVERALL HEIGHT AMSL.....571 ft. NOTICE CRITERIA FAR 77.9(a): NNR (DNE 200 ft AGL) FAR 77.9(b): NNR (DNE Notice Slope) FAR 77.9(c): NNR (Not a Traverse Way) FAR 77.9: NNR FAR 77.9 IFR Straight-In Notice Criteria for BQ1 FAR 77.9: NNR FAR 77.9 IFR Straight-In Notice Criteria for SOP FAR 77.9(d): NNR (Off Airport Construction) NR = Notice Required NNR = Notice Not Required PNR = Possible Notice Required (depends upon actual IFR procedure) For new construction review Air Navigation Facilities at bottom of this report. Notice to the FAA is not required at the analyzed location and height for slope, height or Straight-In procedures. Please review the 'Air Navigation' section for notice requirements for offset IFR procedures and EMI. OBSTRUCTION STANDARDS FAR 77.17(a)(1): DNE 499 ft AGL FAR 77.17(a)(2): DNE - Airport Surface

FAR 77.19(a): DNE - Horizontal Surface

FAR 77.19(b): DNE - Conical Surface FAR 77.19(c): DNE - Primary Surface FAR 77.19(d): DNE - Approach Surface
FAR 77.19(e): DNE - Approach Transitional Surface

FAR 77.19(e): DNE - Abeam Transitional Surface

VFR TRAFFIC PATTERN AIRSPACE FOR: BO1: GILLIAM - MC CONNELL AIRFIEL

Type: A RD: 25988.72 RE: 436.3

FAR 77.17(a)(1): DNE FAR 77.17(a)(2): Does Not Apply.

VFR Horizontal Surface: DNE VFR Conical Surface: DNE VFR Primary Surface: DNE VFR Approach Surface: DNE VFR Transitional Surface: DNE

VFR TRAFFIC PATTERN AIRSPACE FOR: SOP: MOORE COUNTY

Type: A RD: 25186.7 RE: 431.3 FAR 77.17(a)(1): DNE

FAR 77.17(a)(1): DNE - Height No Greater Than 200 feet AGL.

VFR Horizontal Surface: DNE VFR Conical Surface: DNE VFR Primary Surface: DNE VFR Approach Surface: DNE VFR Transitional Surface: DNE

TERPS DEPARTURE PROCEDURE (FAA Order 8260.3, Volume 4)

FAR 77.17(a)(3) Departure Surface Criteria (40:1)

DNE Departure Surface

MINIMUM OBSTACLE CLEARANCE ALTITUDE (MOCA)

FAR 77.17(a)(4) MOCA Altitude Enroute Criteria The Maximum Height Permitted is 2042 ft AMSL

PRIVATE LANDING FACILITIES

BEARING RANGE DELTA FACIL

ARP FAA

IDENT TYP NAME To FACIL IN NM

ELEVATION IFR

NR88 AIR TOBACCO ROAD 223.95 2.3 +93

No Impact to Private Landing Facility. DNE 200 ft AGL within 3 NM of Airport.

84NC AIR ROOSTER FLD 111.9 5.65

+231

No Impact to VFR Transitional Surface. Below surface height of 465 ft above ARP.

AIR NAVIGATION ELECTRONIC FACILITIES

DIST DELTA FACST

GRND APCH

IDNT TYPE AT FREQ VECTOR (ft) ELEVA ST LOCATION

ANGLE BEAR

SOP LOCALIZER I 111.5 197.41 24287 +143 NC RWY 05 MOORE COUN .34 54 D 42 59.1 45949 +81 NC LEE EEJ NDB .10 COUNTY/DCMSND SDZ VORTAC R 111.8 243.95 77252 -17 NC SANDHILLS -.01 FAY RADAR I 2740. 160.55 103124 +188 NC FAYETTEVILLE REGI .10 No Impact. This structure does not require Notice based upon EMI. The studied location is within 20 NM of a Radar facility. The calculated Radar Line-Of-Sight (LOS) distance is: 53 NM. This location and height is within the Radar Line-Of-Sight.

POB TACAN R 113.8 117.04 112477 +366 NC POPE

.19

FAY VOR/DME I 108.8 129.44 185552 +384 NC FAYETTEVILLE

.12

LIB VORTAC I 113.0 337.4 198498 -257 NC LIBERTY

-.07

CFR Title 47, §1.30000-§1.30004

 $\,$ AM STUDY NOT REQUIRED: Structure is not near a FCC licensed AM station.

Movement Method Proof as specified in §73.151(c) is not required. Please review 'AM Station Report' for details.

Nearest AM Station: WEEB @ 13477 meters.

Airspace® Summary Version 21.7.612

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08-27-2021 11:01:08

verizon^v

8921 RESEARCH DRIVE CHARLOTTE, NC 28262

SWALLOWTAIL

SITE ADDRESS (E-911 TBD)

452 FARM LIFE SCHOOL RD CARTHAGE, NC 28327 MOORE COUNTY

LATITUDE: 35° 18' 30.40" N LONGITUDE: 79° 21' 19.10" W

PARCEL ID: 00006478 TAX/PIN #: 859600471781 ZONING: RA

PROPOSED REZONING: RA/CZ

A. EXISTING PROPERTY SQUARE FOOTAGE: 1,233,140 SQUARE FEET B. EXISTING PROPERTY IMPERVIOUS SURFACES AREA: 46,750 SQUARE FEET

C. EXISTING BUILT UPON AREA: 3.79%

D. PROPOSED IMPERVIOUS SURFACED: 4,597 SQUARE FEET E. PROPOSED BUILT UPON AREA: 4.16% (0.37% INCREASE)


MOORE COUNTY SHERIFF 302 S McNEIL ST CARTHAGE, NC 28327 PHONE: (910) 947-2931

ATTN.: CUSTOMER SERVICE

CARTHAGE FIRE DEPARTMENT

4396 US-501

CARTHAGE, NC 28327 PHONE: (910) 947-2226 ATTN.: CUSTOMER SERVICE

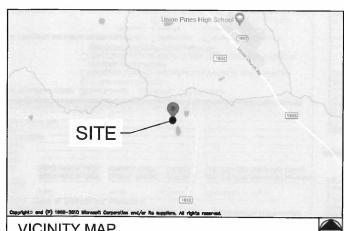

VICINITY MAP

FROM CHARLOTTE OFFICE: TAKE RESEARCH DR TO W W.T.HARRIS BLVD (1.2MI); FOLLOW I-485 INNER AND NC-24 E/NC-27 E TO UNION CHURCH RD IN CARTHAGE (93.6MI); CONTINUE ON UNION CHURCH RD. DRIVE TO FARM LIFE SCHOOL RD (4.2MI); SLIGHT RIGHT ONTO UNION CHURCH RD (3.6MI) TURN RIGHT ONTO FARM LIFE SCHOOL RD (0.6MI) DESTINATION WILL BE ON YOUR RIGHT

DRIVING DIRECTIONS

JURISDICTION: MOORE COUNTY

STATE: NORTH CAROLINA

TOWER TYPE:
MONOPOLE TOWER

TOWER HEIGHT: 195' (199' TO HIGHEST APPURTENANCE)

NUMBER OF CARRIERS: 0 EXISTING, 1 PROPOSED

USE:
PROPOSED TELECOMMUNICATIONS TOWER
AND UNMANNED EQUIPMENT

FLOOD INFO
SITE IS LOCATED WITHIN FEMA FLOOD MAP
AREA 3710858600J DATED 10/17/2006 WITHIN
FLOOD ZONE X.

PROJECT SUMMARY

This document, together with the concepts and designs presented herein, as an instrument of service, is intended only for the specific purpose and differt for which it was prepared. Reuse of and improper reliance on this document without written authorization and adaptation by Kirnley-Horn and Ass

DEVELOPER VERIZON WIRELESS 8921 RESEARCH DRIVE CHARLOTTE, NC 28262 PHONE: (704) 577-8785 ATTN: MICHAEL HAVEN

POWER COMPANY
CENTRAL ELECTRIC MEMBERSHIP CORP.
PHONE: (800) 774-4900
ATTN.: CUSTOMER SERVICE

PROPERTY OWNER
ADULT & TEEN CHALLENGE OF SANDHILLS
PO BOX 1701
SOUTHERN PINES, NC 28388
PHONE: (910) 947-2944
ATTN.: SAL DIBIANCA

CONSULTANT

KIMLEY-HORN AND ASSOCIATES, INC. 11720 AMBER PARK DRIVE, SUITE 600 ALPHARETTA, GEORGIA 30009 PHONE: (770) 545-6105 ATTN.: DAVID FRANKLIN

CONTACTS

SHEET NO.	SHEET TITLE
T1	COVER SHEET
T2	APPENDIX B - BUILDING CODE SUMMARY
	SURVEY SHEET (1 OF 3)
	SURVEY SHEET (2 OF 3)
	SURVEY SHEET (3 OF 3)
N1	GENERAL NOTES
C0	OVERALL AERIAL PLAN
C1	OVERALL SITE PLAN
C2	SITE PLAN
C3	EQUIPMENT PAD LAYOUT
C4	EQUIPMENT RACK DETAIL - FRONT
C5	EQUIPMENT RACK DETAIL - REAR
C6	CONCRETE PAD FOUNDATION DETAILS
C 7	FENCE, GATE, AND COMPOUND DETAILS
C7.1	CATTLE GATE DETAIL
C8	GRADING AND EROSION CONTROL PLAN
C9	GRADING AND EROSION CONTROL DETAILS
C10	ACCESS ROAD DETAILS
C11	SITE SIGNAGE DETAILS
C12	WAVEGUIDE BRIDGE DETAILS
C13	ANTENNA AND TOWER ELEVATION DETAILS
M1	MECHANICAL PLAN & NOTES
E1	ELECTRICAL NOTES
E2	UTILITY SERVICE ROUTING PLAN
E 3	OVERALL UTILITY ROUTING PLAN
E4	METER RACK DETAILS
E5	ELECTRICAL SINGLE LINE DIAGRAM
E6	PANEL SCHEDULE
E7	ELECTRICAL DETAILS
E8	GROUNDING NOTES
E9	GROUNDING PLAN
E10	GROUNDING SINGLE LINE DIAGRAM
E11	GROUNDING DETAILS
E12	GROUNDING DETAILS
SHEET IND	EX

MOORE COUNTY PLANNING & ZONING

1048 CARRIAGE OAKS DRIVE

PERMIT INFORMATION

CARTHAGE, NC 28327

PHONE: (910) 947-2221

ATTN .: CHARLES HILL

verizon/

CHARLOTTE, NORTH CAROLINA 28

PROJECT INFORMATION:

SITE NAME:
SWALLOWTAIL
SITE No.: 431713
PROJECT #: N/A
452 FARM LIFE SCHOOL RD
CARTHAGE, NC 28327
MOORE COUNTY

PLANS PREPARED BY:

Kimley»Horn


720 AMBER PARK DRIVE, SUITE 60X ALPHARETTA, GA 30009 PHONE: 770-619-4280 WWW.KIMEY-HORN.COM

3 03/07/22 CONSTRUCTION DRC

2 12/13/21 CONSTRUCTION DRC

1 10/11/21 CONSTRUCTION DRC

0 09/07/21 CONSTRUCTION DRC

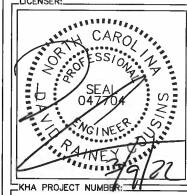

013509278

DRAWN BY: ____CHECKED BY:

______JAR __SHEET_TITLE:__

COVER SHEET

SHEET NUMBER:

Τ

Copyright Kimley-Horn and Associates, Inc., 2021

2018 APPENDIX B BUILDING CODE SUMMARY FOR ALL COMMERCIAL PROJECTS	Frontage area increases from Section 506.2 are computed thus: a. Perimeter which fronts a public way or open space having 20 feet minimum width =(F) b. Total Building Perimeter =(P) c. Ratio (F/P) =(F/P)	ACCESSIBLE DWELLING UNITS
(EXCEPT I AND 2-FAMILY DWELLINGS AND TOWNHOUSES) (Reproduce the following data on the building plans sheet I or 2) Name of Project: VERIZON WRELESS — SWALLOWTAIL Address: 452 FARM LIFE SCHOOL RD, CARTHAGE, NC Zip Code 28327	d. W = Minimum width of public way =(W) e. Percent of frontage increase I ₂ = 100[F/P - 0.25] x W/30 =(%) 2 Unlimited area applicable under conditions of Section 507. 3 Maximum Building Area = total number of stories in the building x D (maximum3 stories) (506.2). 4 The maximum area of open parking garages must comply with Table 406.8-4. The maximum area of a property with Table 412.3.1.	(SECTION 1107) TOTAL ACCESSIBLE ACCESSIBLE TYPE A TYPE B TYPE B TYPE LINTS UNITS ACCESSIBLE UNITS REQUIRED PROVIDED REQUIRED PROVIDED PROVIDED PROVIDED DESIGNATION OF THE PROVIDED PROVI
Owner/Authorized Agent: DAVD COUSAS Phone # (770) 545 - 6105 Owned By: City/County Private Sease Indicates the Coust of County Private Sease Indicates the County Sease Indicates Indicates the County Sease Indicates Indi	⁵ Frontage increase is based on the unsprinklered area value in Table 506.2.	ACCESSIBLE PARKING
Code Enforcement Jurisdiction: City X County MOORE State	ALLOWABLE HEIGHT ALLOWABLE SHOWN ON PLANS CODER REFERENCE	(SECTION 1106) LOT OR PARKING TOTAL I/ OF PARKING SPACES ASPECTION 1 TOTAL I/ OF PARKING SPACES SECURISED SPACES WITH ACCESSIBLE SPACE
CONTACT: DAVID R, COUSINS, P.E. (4047704) DESIGNER FIRM NAME LICENSE# TELEPHONE# E-MAIL	Building Height in Feet (Table 500-5)	AREA REQUIRED PROVIDED REQUUAR WITH VANDEACES WITH ACCESSIBILE 5' ACCESS ASLE 132" 35 8' ACCESS PROVIDED PROVIDED PROVIDED PROVIDED PROVIDED
Architectural Civil KOMEY-HORN & ASSOC. DAWD R. COUSINS 047704 (678) 274-5032 drift controlled by horace	Building Height in Stories of able 504.4) Provide code reference is the "Shown on Plans" quantity is not based on Table 504.3 or 504.4.	
Electrical CMAEY-HORN & ASSOC. CORPIN C. HARDY 040828 (919) 577-2000 with the impure of the control of the cont		TOTAL
Plumbing	FIRE PROTECTION REQUIREMENTS	PI.UMBING FIXTURE REQUIREMENTS (7ABLE 2002.1)
Structurel C		WATHER COUNTS VIEWNALS LAYATORIES SIGNERS DRINKING FOUNTAINS
("Other" should include firms and individuals such as truss, precast, pre-engineered, interior designers, etc.)	(PEET) REDICTION) ASSEMBLY JOINTS	MALE FEMALE UNISEX MALE FEMALE UNISEX / TUBS REGULAR ACCESSIBLE SPACE EXIST'G
2018 NC BUILDING CODE: New Building Addition Renovation 1st Time Interior Completion	Success a France, including columns, girders, trouges Bearing Walls	NEW REG'D
Shell/Core - Contact the local inspection jurisdiction for possible additional procedures and requirements Phased Construction - Shell/Core- Contact the local inspection jurisdiction for	Exterior 2 North N/A 2	SPECIAL APPROVALS
possible additional procedures and requirements 2018 NC EXISTING BUILDING CODE: EXISTING: Prescriptive Repair Chapter 4	East N/A 2 West N/A 2	Special approval: Local Jurisdiction, Department of Insurance, OSC, DPI, DHHS, etc., describe below) SOII
Alteration: Level II Level III Level III Clauge of Use	South N/A N/A Intrior	Soli
CONSTRUCTED: (date) CURRENT OCCUPANCY(S) (Ch. 3): TELECOMMUNICATIONS. STE RENOVATED: (date) PROPOSED OCCUPANCY(S) (Ch. 3): TELECOMMUNICATIONS. STE	Nonbearing Walls and Partitions N/A Extractor walls	-/
RISK CATEGORY (Table 1604.5): Current:	North	/
BASIC BUILDING DATA	West: N/A South Interior walls and partitions N/A Stee Construction	ENERGY SUMMARY ENERGY REQUIREMENTS:
Construction Type: □ I-A □ II-A □ III-A □ IV □ V-A (check all that apply) □ I-B □ II-B □ III-B □ III-B	Interior walls and portions 1 Floor Construction Including supporting beams	The following data shall be considered minimum and any special attribute required to meet the energy code shall also be provided. Each Designer shall himself the required portions of the project information for the plan data sheet.
Sprinklers: □ No □ Partial □ Yes □ NFPA 13 □ NFPA 13R □ NFPA 13D Standpipes: □ No □ Yes Class □ 1 □ II □ III □ Wet □ Dry	and joists Floor Ceiling Assembly	If performance method, state the annual energy cost for the standard reference design vs annual energy cost for the proposed design.
Fire District: No Yes Flood Hazard Area: No Yes Special Inspections Required: No Yes (Contact the local inspect on jurisdiction for additional	Columns Supporting Floors Roof Construction, including N/A supporting beams and joints N/A	Existing building envelope complies with code: No Yes (The remainder of this section) and applicable)
procedures and regerrements.)	Roof Ceiling Assembly N/A Columns Supporting Roof N/A	Exempt Building: No Yes (Provide code or statutory reference):
	Shaft Enclosures - Exit Shaft Enclosures - Other N/A	Method of Compliance: Energy Code Performance Prescriptive
3 rd Fluor 2 rd Fkoor	Corridor Separation Occupancy/Fire Barrier Separation N/A	ASHRAE 90.1 Performance Presorptive (If "Other" specify source here)
Merzanine * Floor 345' 345' Basement	Party/Fire Wall Separation N/A Smoke Barrier Separation N/A	THERMAL ENVELOPE (Prescriptive method only)
345' 345'	Smoke Partition N/A Transi/Dwellige Usiz' N/A Skeeping Unit Separation	Roof/ceiling Assembly (each assembly) Description of ussembly: U-Value of total assembly:
ALLOWABLE AREA	Incidental Use Separation N/A Indicase section number permitting reduction	R-Value of insulation: Skylights in each assembly:
Primary Occupancy Classification(s): Selectone		U-Value of skylight: total square footage of skylights in each assembly:
Educational Factory F-1 Moderate F-2 Low	PERCENTAGE OF WALL OPENING CALCULATIONS FIRE SEPARATION DISTANCE DEGREE OF OPENINGS ALLOWABLE AREA ACTUAL SHOWN ON PLANS	Exterior Walls (each assembly) Description of assembly:
11zzardous H-1 Detonate H-2 Deflagrate H-3 Combust H-4 Health H-5 HPM Institutional I-1 Condition 1 2	(FEET) FROM PROPERTY LINES PROTECTION (%) (%) (%)	U-Value of total assembly: R-Value of insulation: Openings (windows or doors with glazing)
I-2 Condition 1 2 3 4 5		U-Value of assembly: Solar heat gain coefficient:
Mercantile		projection factor: Door R-Valves:
Residential R-1 R-2 R-3 R-4 Storage S-1 Moderate S-2 Low High-piled Residential Resident	LIFE SAFETY SYSTEM REQUIREMENTS	Walls below grade (each assembly) Description of assembly:
☐ Parking Garage ☐ Open ☐ Enclosed ☐ Repair Gorage Utility and Miscellaneous ☐ Accessory Occupancy Classification(s):	Emergency Lighting: No X Yes Exit Signs: No X Yes	U-Value of vital assembly: R-Value of insulation:
Accessory Occupancy Classification(s): Incidental Uses (Table 509): Special Uses (Chapter 4 – List Code Sections):	Fire Alarm:	Floors over unconditioned space (each assembly) Description of assembly:
Special Provisions: (Chapter 5 – List Code Sections): Special Provisions: (Chapter 5 – List Code Sections): Mixed Occupancy: No Yes Separation: Hr. Exception:		U alue of insulation:
Mixed Occupancy: Yes Separation: Hr. Exception: Non-Separated Use (508.3) - The required type of construction for the building shall be determined by applying tight height and area limitations for each of the applicable	LIFE SAFETY PLAN REQUIREMENTS Life Safety Plan Sheet #:	Floors slab on grade Description of assembly:
applying the neight and area immattons for each of the application occupanties to the entire building. The most restrictive type of construction, so determined, shall apply to the entire building.	Fire and/or smoke rated wall locations (Chapter A. Assumed and real property line locations (if not or the site plan)	U-Value of total assembly:
Separated Use (508.4) - See below for area calculations for each story, the area of the occupancy shall be such that the sum of the ratios of the actual floor area of each use divided by	Assumed and rear properly line locations (it line by the sace plan) Exterior wall opening area with respect to distinct to assumed property lines (705.8) Occupancy Use for each area as it relates to occupant load calculation (Table 1004.1.2)	Horizontal/vertical requirement: slab heated:
the filowable floor area for each use shall not exceed 1. Actual Area of Occupancy A + Actual Area of Occupancy B ≤ 1	☐ Occupant loads for each area ☐ Exit access travel distances (1017)	
Allowable Area of Occupancy A Allowable Area of Occupancy B + = ≤ 1.00	Common path of travel distances (Tables 1006.2.1 & 1006.3.2(1)) Dead end lengths (1020.4)	
STUDY DESCRIPTION AND (A) (D) (C) (D)	Clear exit widths for each exit door Maximum calculated occupant load capacity each exit door can accommodate based on egress width (1005.3)	NOTE: SCOPE OF WORK INCLUDES INSTALLATION OF
STURY DESCRIPTION AND (A) (B) (B) TABLE 506.24 AREA FOR FRONTAGE ALLOWABLE AREA PER STORY (ACTUAL) AREA LIXCREASE!-5 STORY OR UNLIMITED ^{2,3}	Actual occupant load for each exit door A separate schematic flan indicating where fire rated floor/ceiling and/or roof structure is provided for purposes of occupacy separation	CAST IN PLACE CONCRETE PAD, PREFABRICATED EQUIPMENT CABINETS AND GENERATOR.
	purposes to recurpacy separation Location of doops with panic hardware (1010.1.10) Location of doors with delayed egress locks and the amount of delay (1010.1.9.7)	NO NEW BUILDING BEING CONSTRUCTED.
STURY DESCRIPTION AND USE BLOG AREA PER STORY (ACTUAL) AREA STORY FRONTAGE INCREASE ^{1,3} ALLOWABLE AREA PER STORY OR UNLASHTED ^{2,3}	Location of doors with electromagnetic egress locks (1010.1.9.9) Location of doors equipped with hold-open devices	
	Location of emergency escape windows (1030) The square footage of each fire area (202)	
	he square footage of each smoke compartment for Occupancy Classification 1-2 (407.5) Note any code exceptions or table notes that may have been utilized regarding the items above	

	2018 APPENDIX B	
BUILDING CODE S	UMMARY FOR ALL CON STRUCTURAL DESIGN	MMERCIAL PROJECTS
	ON THE STRUCTURAL SHEETS I	F APPLICABLE)
DESIGN LOADS:		NOTE: STRUCTURAL
Importance Factors:	Snow (I _s)	ANALYSIS Ø MPLETED
Live Loads:	Roof93 psf	BY TOWER OWNER. SEE ANALYSIS BY OTHERS
	Mezzanine N/A psf Floor 208 psf	FOR ADDITIONAL
Ground Snow Load:		STRUCTURAL DATA.
	. /	SCE-7)
	sic Wind Speed 94 with (A posure Category	ISC L-7)
SEISMIC DESIGN CATEGOR Provide the following Seismic De		
Risk Category (Table 16 Spectral Response Acce	504.5) 🗶 t 🖊 🗖 ll 🔃 🔲 ll 🗀 lV	S ₁ _0.75 %g
Site Classification (ASC	1E7) [ZA □B □C XID	□E □F
Data So Basic structural system		e Historical Data al w/Special Moment Frame
/	X Building Frame Du	al w/Intermediate R/C or Special Steel
Analysis Procedure:		verted Pendulum nt Lateral Force Dynamic
	cal, Components anchored?	es 🗌 No
LATERAL DESIGN CONTRO	L: Earthquake 🗶 Wind 🗶	
SOIL BEARING CAPACITIES	i: of test report) N/A p	
Field Test (provide copy Presumptive Bearing cap	acity	
Pile size, type, and capac	ityN/A	
	2018 APPENDIX B	
BUILDING CODE	SUMMARY FOR ALL CO	MMERCIAL PROJECTS
	MECHANICAL DESIGN E ON THE MECHANICAL SHEETS	
(2312-12	MECHANICAL SUMMARY	
MERCHANICAL OVERTIME CI	RVICE SYSTEMS AND EQUIPMEN	
	RVICE 3131E.113 AND EQUITINE	/
Thermal Zone winter dry bulb		
summer dry bu	b:	
Interior design condition winter dry bulb	11.7	
summer dry bu	b:	
relative humidi	y:	
Building heating load:		
Building cooling load:		
Mechanical Spacing C Unitary	onditioning System	
description heating effe		
cooling offi size categor	ciency:	
Boilpt		
Chiller	y. If oversized, state reason.:	
	ry. If oversized, state reason.:	
List equipment efficier	cies:	
	2018 APPENDIX B	
BUILDING CODE	SUMMARY FOR ALL CO ELECTRICAL DESIGN	MMERCIAL PROJECTS
(PROVII	DE ON THE ELECTRICAL SHEETS	IF APPLICABLE)
	ELECTRICAL SUMMARY	
ELECTRICAL SYSTEM ANI	EQUIPMENT	
Method of Complianc	e: Energy Code Performance	Prescriptive
	ASHRAE 90.1 Performance	☐ Prescriptive
Lighting schedule (cac		
lamp type requ number of lam	ps in fixture	
ballast type us number of ball	ed in the fixture	
total wattage r		ting or space by space)
total interior w	attage specified vs. allowed (whole built rattage specified vs. allowed	ring or shape of shape)
Additional Efficiency	Package Options	A 1)
	CECC; not required for ASHRAE 9 re Efficient HVAC Equipment Performa	
□ C406/3 Re	duced Lighting Power Density nanced Digital Lighting Controls	
☑ C406.5 On	-Site Renewable Energy	
☐ C406.6 De	dicated Outdoor Air System duced Energy Use in Service Water Heat	ing
/		



8921 RESEARCH DRIVE CHARLOTTE, NORTH CAROLINA 28262

PROJECT INFORMATION:

SITE NAME: SWALLOWTAIL SITE No.: 431713 PROJECT #: N/A 452 FARM LIFE SCHOOL RD CARTHAGE, NC 28327 MOORE COUNTY

PLANS PREPARED BY:

Kimley »Horn

11720 AMBER PARK DRIVE, SUITE 600 ALPHARETTA, CA 30009 PHONE: 770-619-4280 WWW.KIMLEY-HORN.COM NC License F-0102

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KHA PROJECT NUMBER:

013509278

DRAWN BY: CHECKED BY:


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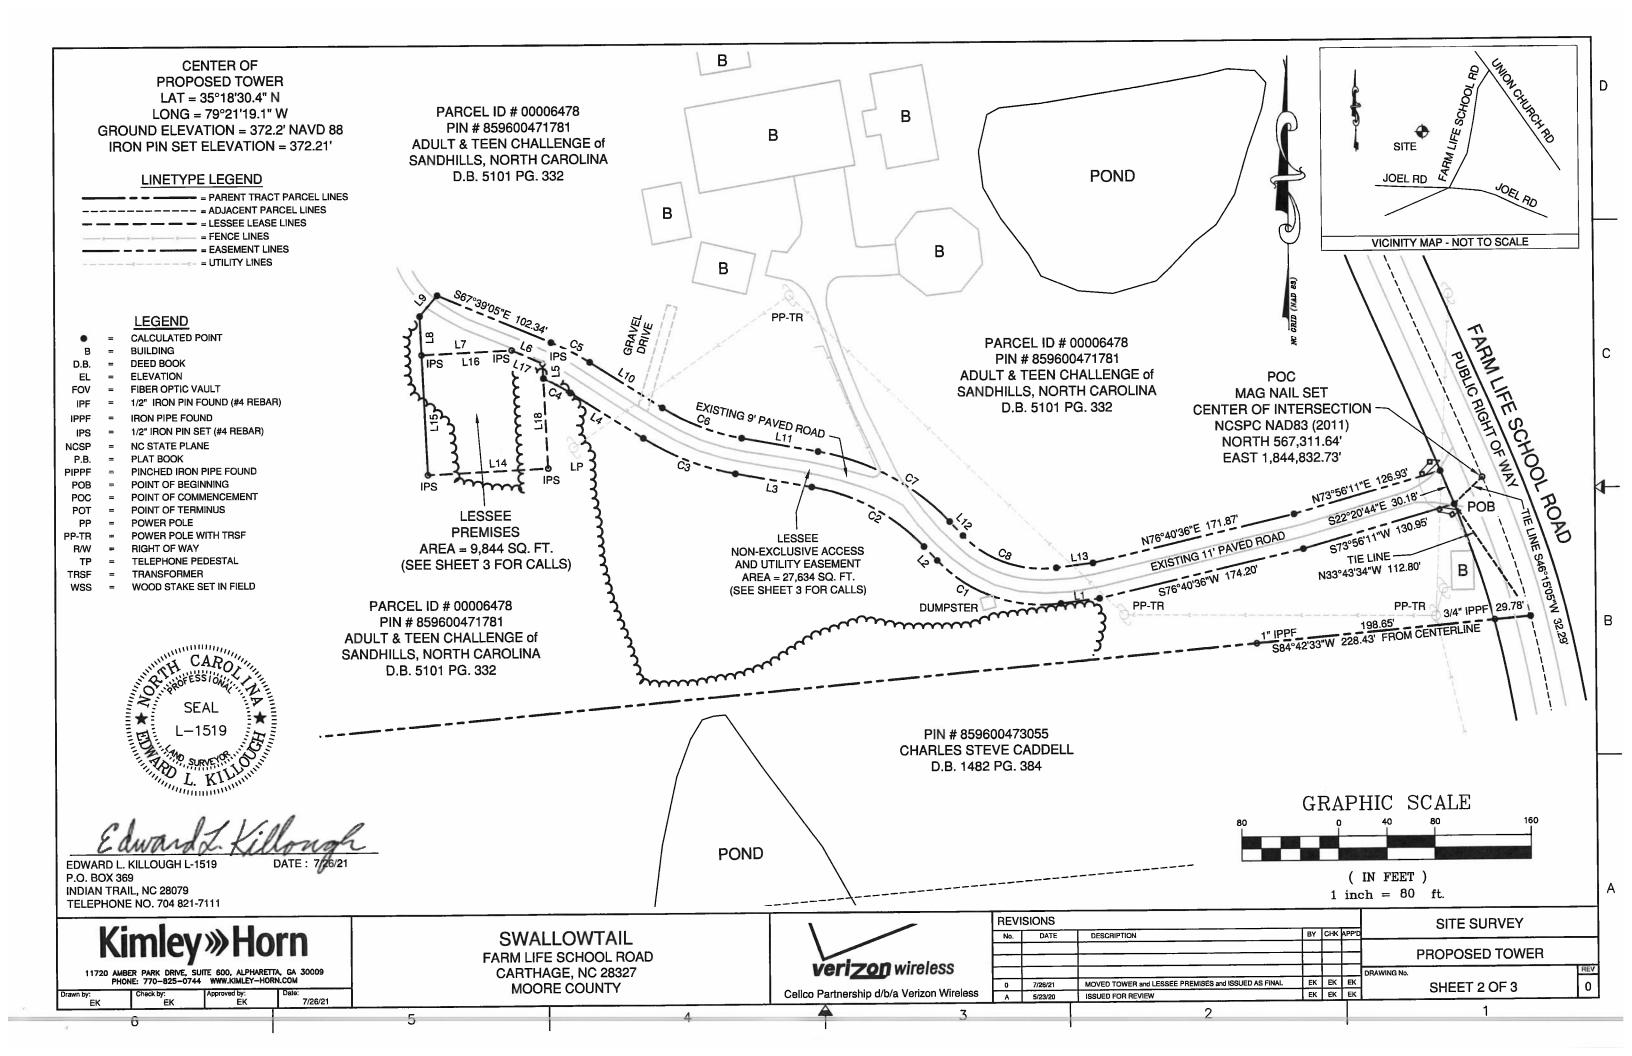
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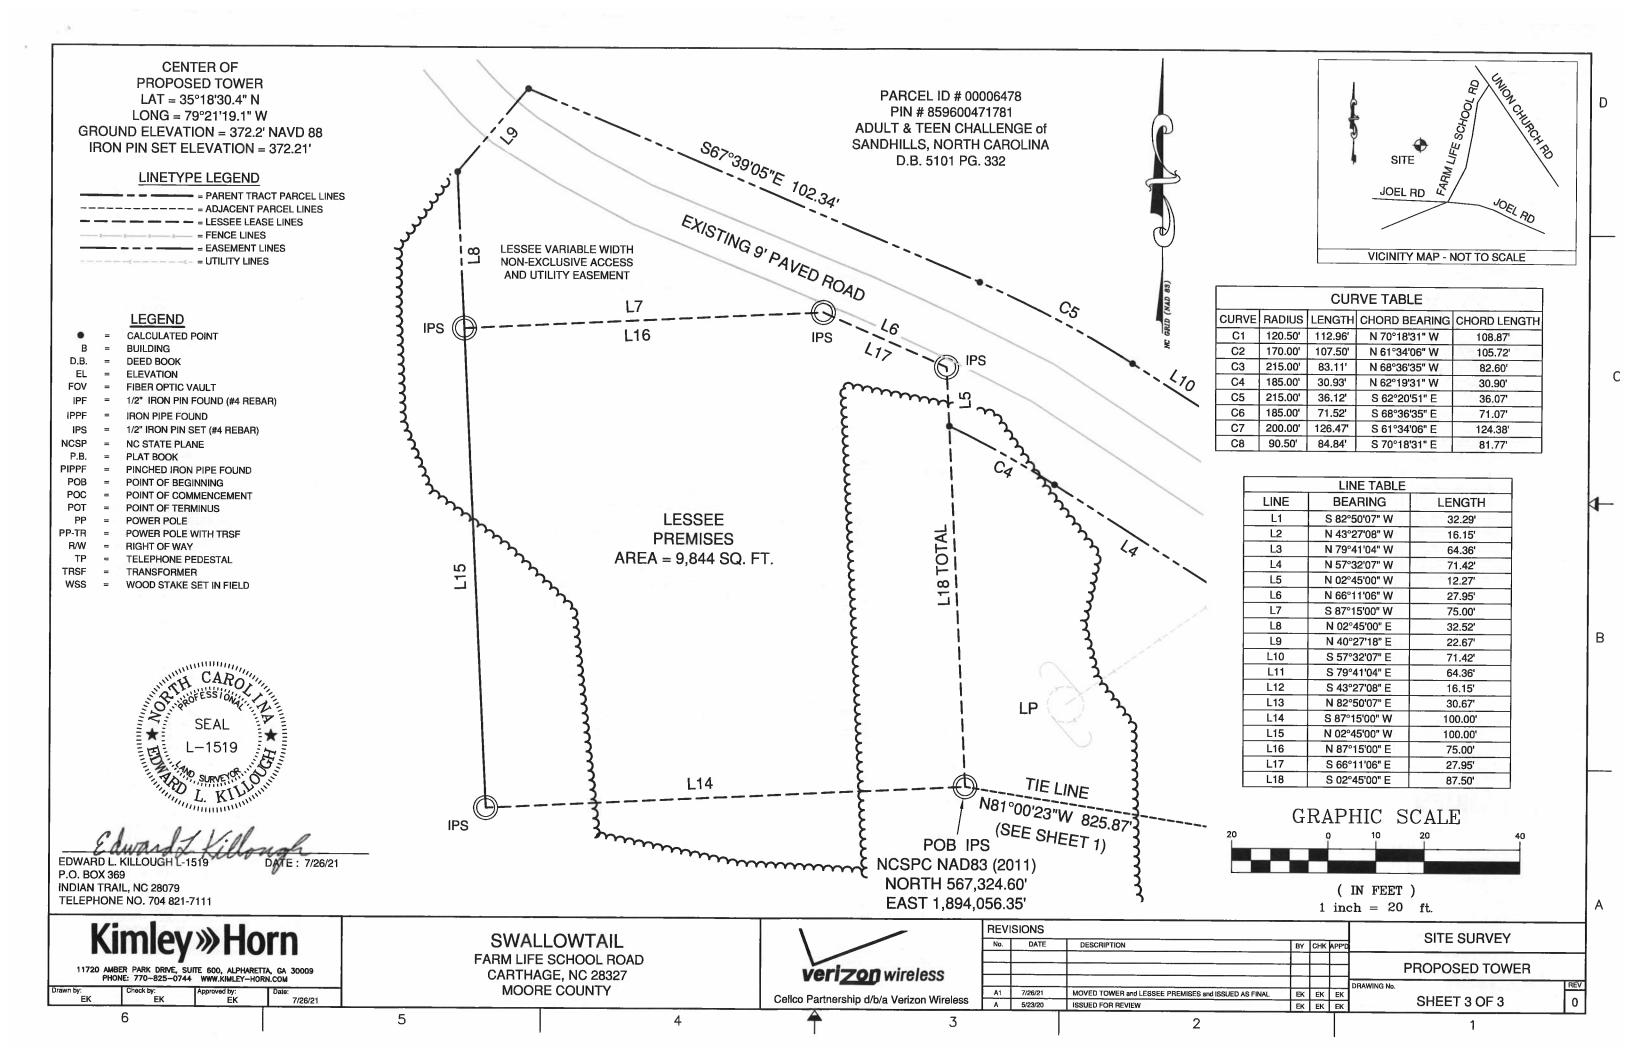
APPENDIX B -BUILDING CODE SUMMARY

SHEET NUMBER:

T2





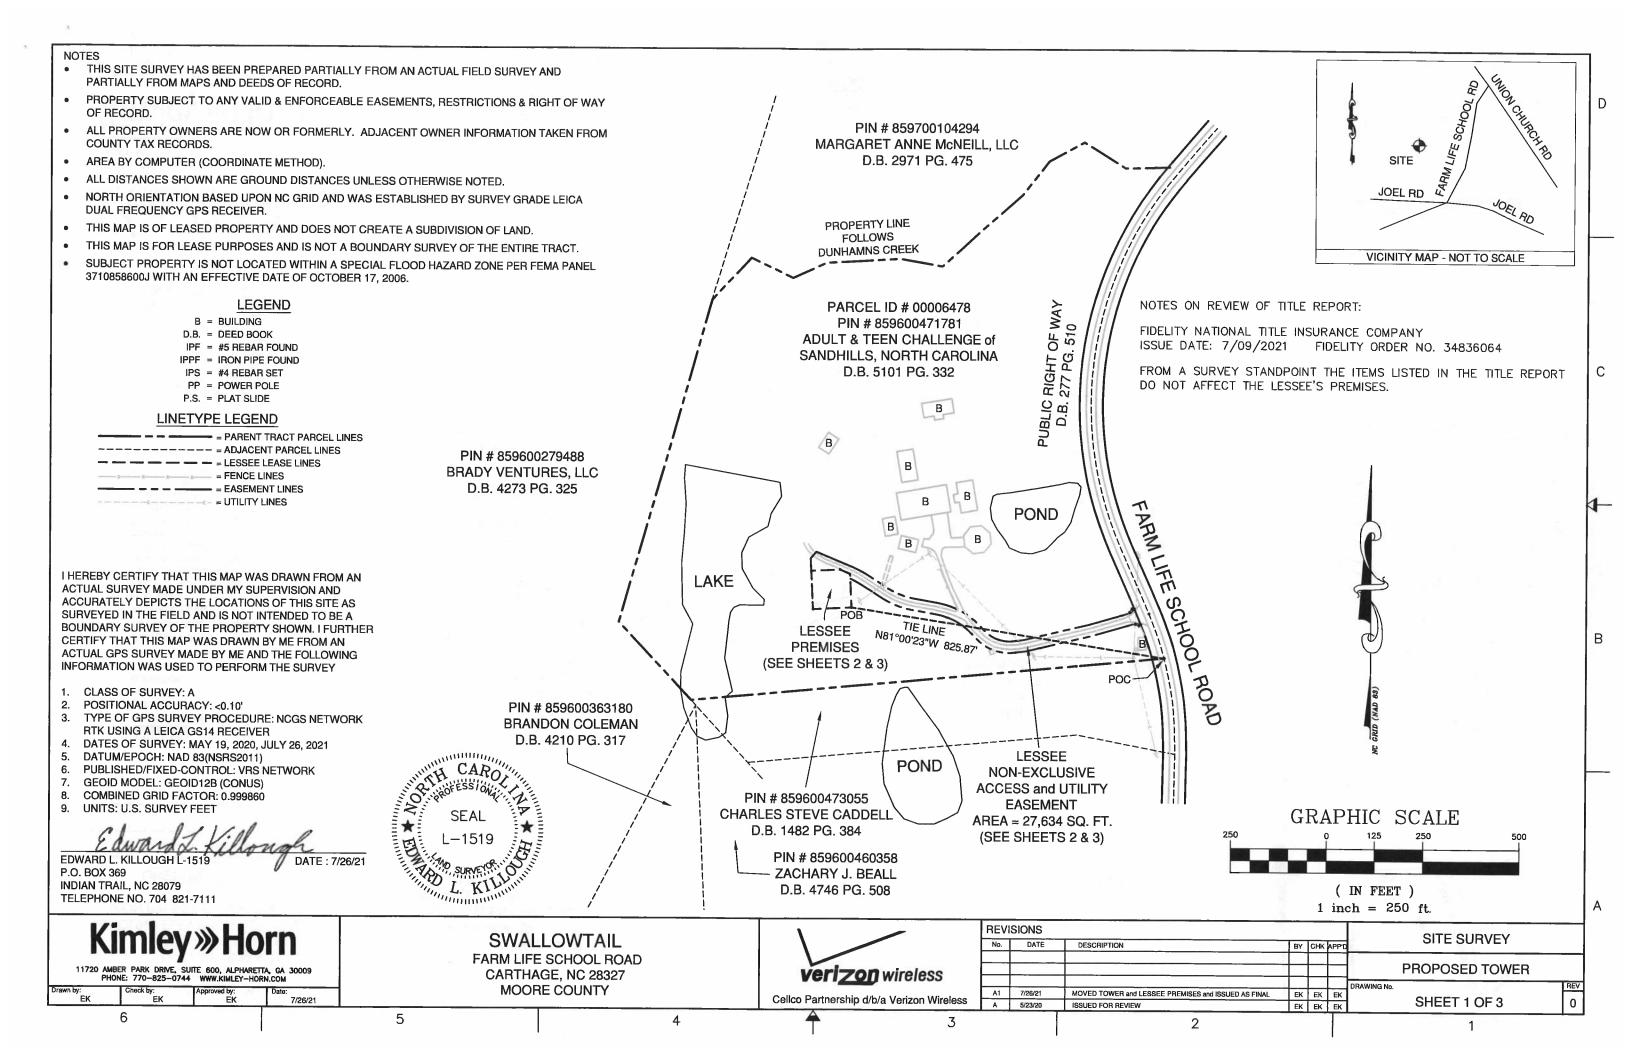

1.00 GENERAL NOTES

- 1.01 ALL MATERIALS AND WORKMANSHIP SHALL CONFORM TO THE DRAWINGS AND SPECIFICATIONS. ALL WORK SHALL BE DONE IN ACCORDANCE WITH THE LATEST EDITION OF THE STATE, LOCAL AND NATIONAL CODES, ORDINANCES AND OR REGULATIONS APPLICABLE TO THIS PROJECT.
- 1.02 THE CONTRACTOR SHALL BE RESPONSIBLE FOR COORDINATING THE WORK OF ALL TRADES AND SHALL CHECK ALL DIMENSIONS. ALL DISCREPANCIES SHALL BE CALLED TO THE ATTENTION OF THE PROJECT MANAGER AND/OR ENGINEER AND BE RESOLVED BEFORE PROCEDING WITH WORK. WHERE THERE IS A CONFLICT BETWEEN DRAWING AND VERIZON SPECIFICATIONS, THE VERIZON PROJECT ENGINEER SHOULD BE CONTACTED FOR CLARIFICATION.
- 1.03 ALL INFORMATION SHOWN ON THE DRAWINGS RELATIVE TO EXISTING CONDITIONS IS GIVEN AS THE BEST PRESENT KNOWLEDGE, BUT WITHOUT GUARANTEE OF ACCURACY. WHERE ACTUAL CONDITIONS CONFLICT WITH THE DRAWINGS, THEY SHALL BE REPORTED TO THE PROJECT MANAGER AND/OR ENGINEER SO THAT PROPER REVISIONS MAY BE MADE. MODIFICATION OF DETAILS OF CONSTRUCTION SHALL NOT BE MADE WITHOUT WRITTEN APPROVAL OF THE PROJECT MANAGER AND/OR ENGINEER.
- 1.04 CONTRACTOR SHALL REVIEW AND BE FAMILIAR WITH SITE CONDITIONS AS SHOWN ON THE ATTACHED SITE PLAN AND/OR SURVEY DRAWNGS.
- 1.05 WAVEGUIDE BRIDGE AND EQUIPMENT CABINETS ARE SHOWN FOR REFERENCE ONLY. REFER TO SEPARATE DRAWINGS FOR SPECIFIC INFORMATION.
- 1.06 ALL FINISHED GRADES SHALL SLOPE MINIMUM 1/4 IN./FT. AWAY FROM EQUIPMENT IN ALL DIRECTIONS. CONTRACTOR SHALL SLOPE SWALES AS REQUIRED ALONG EXISTING TERRAIN TO DRAIN AWAY FROM COMPOUND AND ACCESS DRIVE.
- 1.07 THE PROPOSED TOWER AND TOWER FOUNDATIONS WERE DESIGNED BY OTHERS. TOWER INFORMATION PROVIDED ON THESE PLANS ARE PROVIDED FOR REFERENCE PURPOSES ONLY. NOTIFY ENGINEER OR PROJECT MANAGER OF ANY CONFLICTS OR DISCREPANCIES. CONTRACTOR TO OBTAIN COPY OF TOWER DESIGN DRAWINGS, IF AVAILABLE, FROM VERIZON PROJECT MANAGER TO CONFIRM COAX ROUTING AND ANTENNA MOUNT INFORMATION.
- 1.08 THE CONTRACTOR SHALL PROVIDE ADEQUATE EXCAVATION SLOPING, SHORING, BRACING, AND GUYS IN ACCORDANCE WITH ALL NATIONAL, STATE, AND LOCAL SAFETY ORDINANCES.
- 1.09 UPON COMPLETION OF CONSTRUCTION, CONTRACTOR IS RESPONSIBLE FOR REPAIRING ANY DAMAGE CAUSED BY CONSTRUCTION ACTIVITIES TO THE EXISTING ACCESS ROAD AND COMPOUND GRAVEL AREAS. ANY NEW FILL MATERIALS SHALL BE COMPACTED.
- 1.10 THE CONTRACTOR IS HEREBY NOTIFIED THAT PRIOR TO COMMENCING CONSTRUCTION, HE IS RESPONSIBLE FOR CONTACTING THE UTILITY COMPANIES INVOLVED AND SHALL REQUEST A VERIFICATION AT THE CONSTRUCTION SITE OF THE LOCATIONS OF THEIR UNDERGROUND UTILITIES AND WHERE THEY MAY POSSIBLY CONFLICT WITH THE PLACEMENT OF IMPROVEMENTS AS SHOWN ON THESE PLANS. THE CONTRACTOR OR ANY SUBCONTRACTOR FOR THIS CONTRACT WILL BE REQUIRED TO NOTIFY "NORTH CAROLINA 811" 48 HOURS IN ADVANCE OF PERFORMING ANY WORK BY CALLING THE TOLL FREE NUMBER (800) 632—4949 (OR 811). ANY UTILITIES DAMAGED BY CONSTRUCTION ACTIVITIES SHALL BE REPAIRED BY THE CONTRACTOR, AT NO EXPENSE TO THE OWNER.
- 1.11 CONTRACTOR TO PROVIDE DUMPSTER AND PORTABLE TOILET FACILITY DURING CONSTRUCTION.
- 1.12 CONTRACTOR TO PROVIDE STYMIE LOCK OR EQUIVALENT AS APPROVED BY VERIZON PROJECT MANAGER.
- 1.13 CONTRACTOR TO PROVIDE ANY NECESSARY SIGNAGE PER VERIZON PROJECT MANAGER'S INSTRUCTIONS. SEE DETAIL ON SHEET C11.

2.00 EQUIPMENT FOUNDATION NOTES

- 2.01 FOUNDATIONS ARE DESIGNED FOR A PRESUMPTIVE ALLOWABLE SOIL BEARING CAPACITY OF 2,000 PSF. CONTRACTOR SHALL VERIFY SOIL CONDITIONS AND BEARING CAPACITY PRIOR TO CONSTRUCTION.
- 2.02 EXCAVATE A MINIMUM 18" BELOW PROPOSED EQUIPMENT FOUNDATIONS OF EXPANSIVE, ORGANIC, UNCONSOLIDATED OR OTHERWISE UNACCEPTABLE MATERIAL AND REPLACE WITH WELL—COMPACTED MATERIAL ACCEPTABLE TO VERIZON.
- 2.03 CONTRACTOR SHALL BE RESPONSIBLE FOR LOCATING, PROTECTING, AND RELOCATING AS REQUIRED ALL SERVICE AND UTILITY LINES IN VICINITY OF THE WORK SITE. ALL EXCAVATIONS NEAR THESE LINES TO BE CARRIED OUT WITH EXTREME CAUTION. COORDINATE ALL RELOCATIONS WITH THE PROPERTY OWNER.
- 2.04 CONTRACTOR TO CUT/FILL EXISTING COMPOUND SUBSOIL TO PROVIDE AN AREA AS LEVEL AS POSSIBLE FOR THE EQUIPMENT FOUNDATIONS. ALL FILL AREAS ARE TO BE FILLED WITH SUITABLE MATERIALS. FILL MATERIALS ARE TO BE PLACED, COMPACTED, AND TESTED IN MAXIMUM LAYERS OF 8". COMPACTION OF ALL FILL MATERIAL SHALL ACHIEVE 95 PERCENT OF MAXIMUM DRY DENSITY AT OPTIMUM MOISTURE CONTENT IN ACCORDANCE WITH ASTM D 698. ALL TESTS MUST MEET THE MINIMUM SPECIFIED SOIL BEARING CAPACITY. COMPACTION TESTING IS BY THE GEOTECHNICAL TESTING COMPANY DESIGNATED FOR THE PROJECT. SCHEDULING AND COORDINATION IS THE RESPONSIBILITY OF THE GENERAL CONTRACTOR. REPORTS OF ALL TESTING ARE TO BE PROMPTLY DELIVERED OR FAXED TO THE VERIZON WIRELESS PROJECT MANAGER.
- 2.05 CONCRETE SHALL HAVE A MINIMUM COMPRESSIVE STRENGTH OF 4,000 PSI AT 28 DAYS AND SHALL BE INSTALLED IN ACCORDANCE WITH THE LATEST REVISION TO ACI-318 BUILDING CODE REQUIREMENTS FOR REINFORCED CONCRETE.
- 2.06 CONCRETE SHALL HAVE A SLUMP BETWEEN 3" AND 6".
- 2.07 FIBERS FOR CONCRETE SHALL BE FIBERMESH 650, 100 PERCENT VIRGIN POLYPROPYLENE FIBRILLATED FIBERS, e3 PATENTED TECHNOLOGY PATENTED TECHNOLOGY, CONTAINING NO REPROCESSED OLEFIN MATERIALS. THE FIBERS SHALL CONFORM TO ASTM C1116 TYPE III AND MANUFACTURED SPECIFICALLY FOR THE SECONDARY REINFORCEMENT OF CONCRETE.
- 2.08 THE FIBERS SHALL BE MANUFACTURED IN AN ISO 9001: 2008 CERTIFIED MANUFACTURING FACILITY. UNLESS OTHERWISE STATED, FIBERMESH 650 MACRO—SYNTHETIC FIBERS SHALL BE ADDED TO THE CONCRETE AT THE BATCHING PLANT AT THE RECOMMENDED APPLICATION RATE OF 3 LBS/YD³ AND MIXED FOR A SUFFICIENT TIME (MINIMUM 5 MINUTES AT FULL MIXING SPEED) TO ENSURE UNIFORM DISTRIBUTION OF THE FIBERS THROUGHOUT THE CONCRETE. FIBROUS CONCRETE REINFORCEMENT SHALL BE MANUFACTURED BY FIBERMESH, 4019 INDUSTRY DRIVE, CHATTANOOGA, TN 37416 USA, TEL: 800 621-1273, WEBSITE: WWW.FIBERMESH.COM
- 2.09 AT THE REQUEST OF THE VERIZON WRELESS PROJECT MANAGER, TEST CYLINDERS SHALL BE MOLDED AND LABORATORY CURED IN ACCORDANCE WITH ASTM C31. THREE CYLINDERS SHALL BE TAKEN FOR EACH DAY'S CONCRETE PLACEMENT. CYLINDERS SHALL BE TESTED IN ACCORDANCE WITH THE LATEST REVISION TO ASTM C39.
- 2.10 CHAMFER ALL EXPOSED EXTERNAL CORNERS OF CONCRETE WITH 34" x 45" CHAMFER, UNLESS OTHERWISE NOTED.
- 2.11 CONCRETE FORMWORK IS TO BE STRIPPED WITHIN 48 HOURS. VIBRATION OF THE CONCRETE MUST ASSURE THAT HONEYCOMBING WILL BE AT A MINIMUM.

 MECHANICAL VIBRATION OF ALL CONCRETE IS REQUIRED UNLESS OTHERWISE DIRECTED BY VERIZON WIRELESS' PROJECT MANAGER. ABOVE GRADE CONCRETE IS TO BE RUBBED AND PATCHED TO ASSURE SMOOTH FINISH AT TIME OF FORMS REMOVAL. CONTRACTOR SHALL PROVIDE A BROOM FINISH ON THE TOP SURFACE OF THE EQUIPMENT FOUNDATION UNLESS OTHERWISE DIRECTED BY VERIZON WIRELESS' PROJECT MANAGER.
- 2.12 TOPS OF CONCRETE FOUNDATION MUST BE WITHIN 0.02' OF ELEVATION REQUIRED.
- 2.13 TOP OF FOUNDATION FINISH TO BE LEVEL $\pm \frac{1}{2}$ " IN 10'.
- 2.14 TOP OF FOUNDATION TO HAVE MEDIUM BROOM FINISH.
- 2.15 CONTRACTOR SHALL REFER TO DRAWINGS OF OTHER TRADES AND VENDOR DRAWINGS FOR EMBEDDED ITEMS AND RECESSES NOT SHOWN ON THE STRUCTURAL DRAWINGS. CONTRACTOR SHALL VERIFY PLACEMENT OF EQUIPMENT AND LOCATION OF CONDUIT FOR MANUFACTURER'S AND VENDORS SPECIFICATIONS. IT SHALL BE THE RESPONSIBILITY OF THE CONTRACTOR TO PROVIDE ALL OPENINGS AND SLEEVES FOR PROPER DISTRIBUTION OF ALL UTILITIES.

verizon/

8921 RESEARCH DRIVE HARLOTTE, NORTH CAROLINA 2826

PROJECT INFORMATION:

SITE NAME:
SWALLOWTAIL
SITE No.: 431713
PROJECT #: N/A
452 FARM LIFE SCHOOL RD
CARTHAGE, NC 28327
MOORE COUNTY

PLANS PREPARED BY:


Kimley Whorn

11720 AMBER PARK DRIVE, SUITE 600 ALPHARETTA, GA 30009 PHONE: 770-619-4280 WWW.KIMLEY-HORN.COM NC License F-0102

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0 09/07/21 CONSTRUCTION DRC

1 10/11/21 CONSTRUCTION DRC

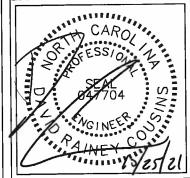

KHA PROJECT NUMBER:

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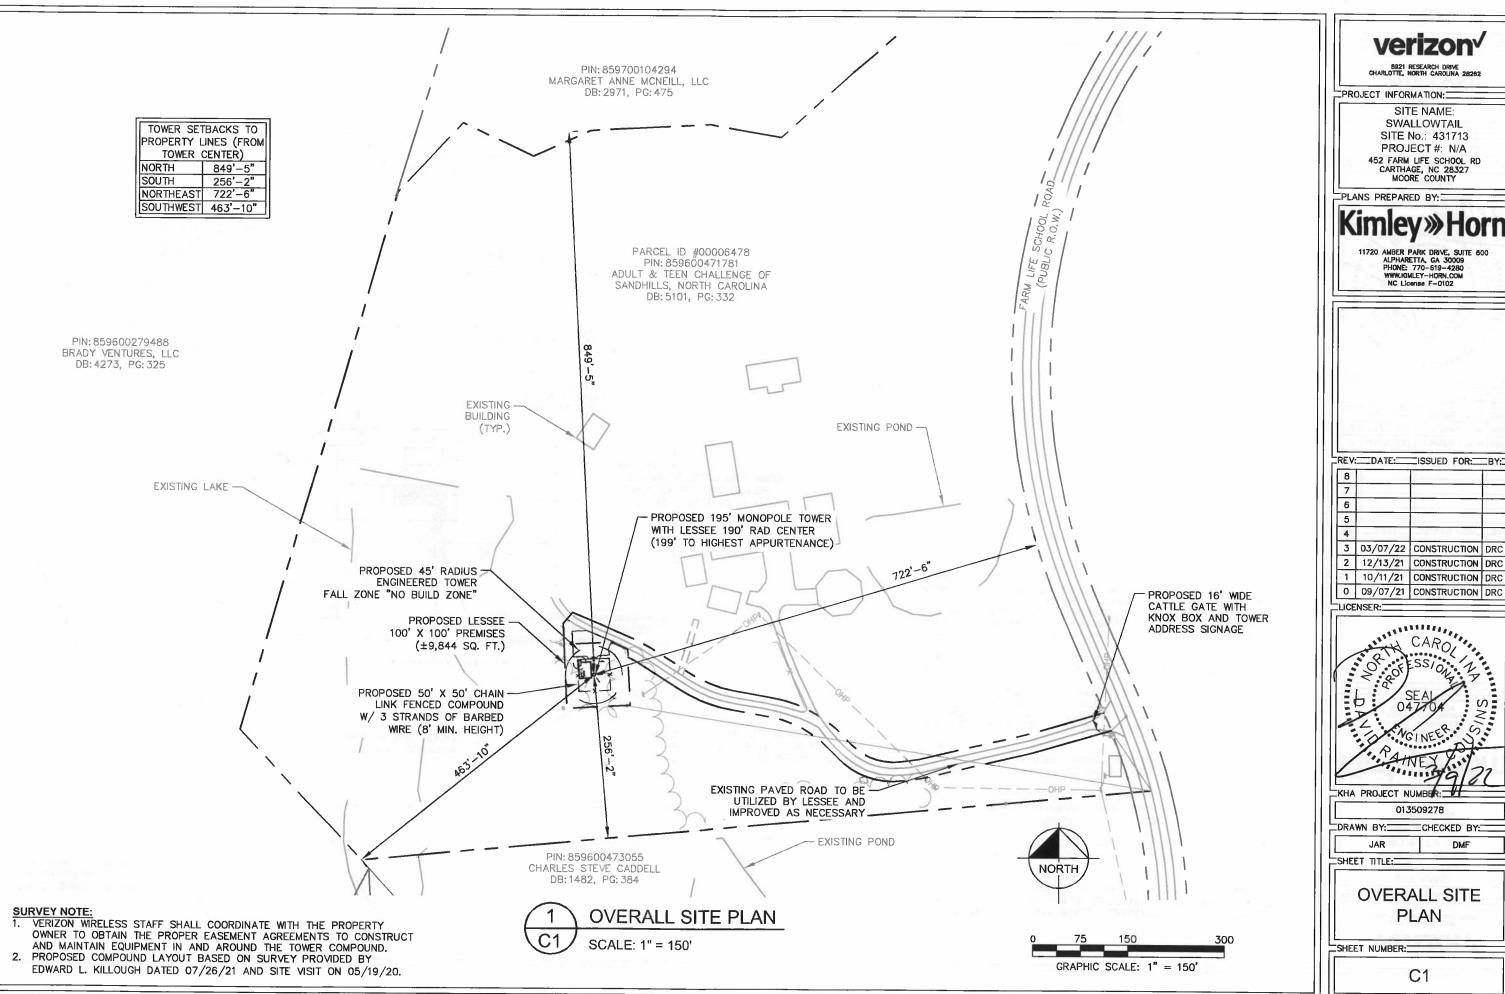
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GENERAL NOTES

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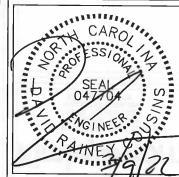
8921 RESEARCH DRIVE CHARLOTTE, NORTH CAROLINA 28282

SITE NAME: **SWALLOWTAIL** SITE No.: 431713 PROJECT#: N/A 452 FARM LIFE SCHOOL RD CARTHAGE, NC 28327 MOORE COUNTY

11720 AMBER PARK DRIVE, SUITE 800 ALPHARETTA, GA 30009 PHONE: 770-619-4280 WWW.KMLEY-HORN.COM NC LICENSE F-0102


REV: DATE: ISSUED FOR: BY:

3 03/07/22 CONSTRUCTION DRC 2 12/13/21 CONSTRUCTION DRC



CHECKED BY:

OVERALL SITE PLAN

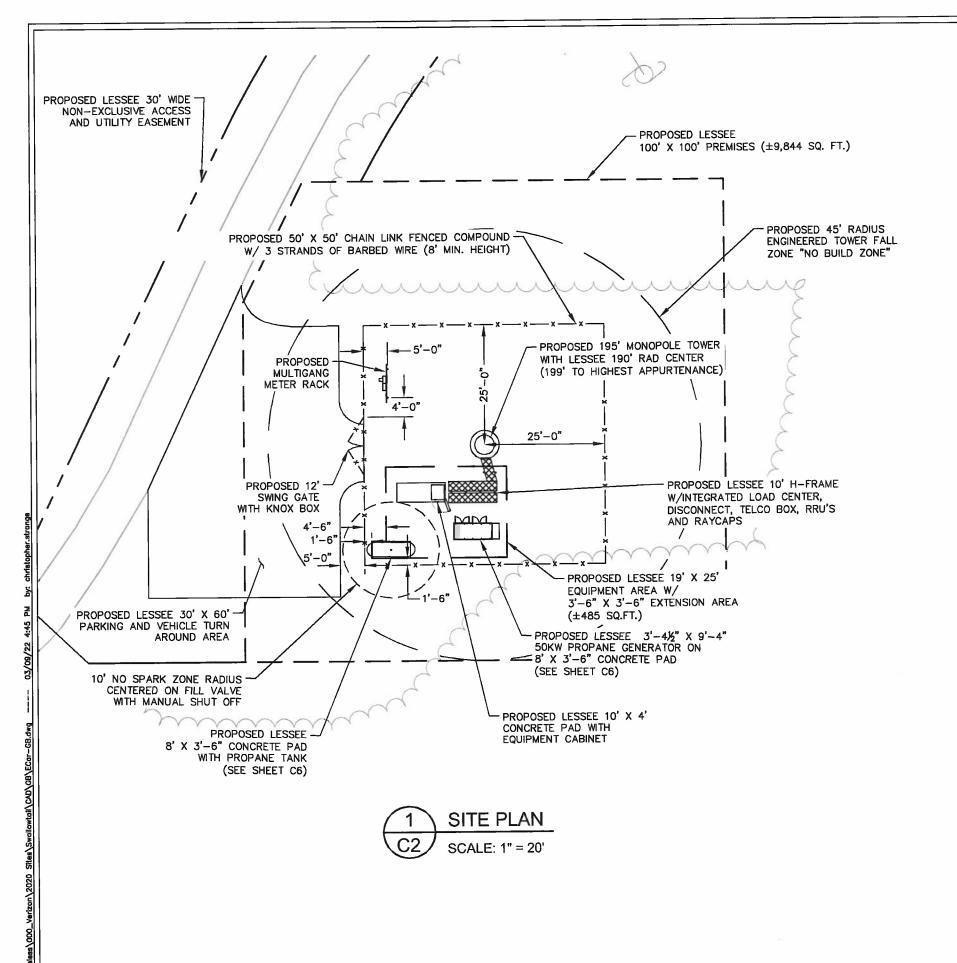

ament, together with the concepts and designs presented herein, as an instrument of service, is intended only for the specific purpose and disent for which it was prepared. Reuse of and improper reliance on this document without written authorization and adaptation by Kmley-Horn and Associates, Inc.

SITE NOTES:

- 1. VERIZON WRELESS STAFF SHALL COORDINATE WITH THE PROPERTY OWNER AND/OR TOWER OWNER TO OBTAIN THE PROPER EASEMENT AGREEMENTS TO CONSTRUCT AND MAINTAIN EQUIPMENT IN AND AROUND THE TOWER COMPOUND.
- 2. PROPOSED COMPOUND LAYOUT BASED ON SURVEY PROVIDED BY EDWARD L. KILLOUGH DATED 07/26/21 AND SITE VISIT ON 07/26/21.
- 3. CONTRACTOR TO CONFIRM WITH VERIZON CONSTRUCTION MANAGER THAT THE SHELTER/EQUIPMENT SHOWN HAS BEEN ORDERED/SCHEDULED FOR DELIVERY TO THIS SITE.
- 4. THE BASIS OF EQUIPMENT DESIGN INCLUDES ONE (1) RF CABINET, ONE (1) FUTURE BATTERY CABINET, AND ONE (1) FUTURE EXPANSION CABINET.
- 5. GENERAL CONTRACTOR SHALL BE RESPONSIBLE FOR COORDINATING AND MODIFYING SCOPE OF WORK TO ACCOMMODATE ANY CHANGES IN THE EXACT EQUIPMENT PROCURED BY VERIZON WIRELESS. COORDINATE ANY CHANGES WITH VERIZON WIRELESS CONSTRUCTION MANAGER.
- 6. ROUTE COAX/FIBER UP TOWER PER STRUCTURAL ANALYSIS BY TOWER OWNER.
- 7. TOWER DIMENSIONS SHOWN ON THIS PLAN ARE FOR TOWER CENTER LOCATION. CONTRACTOR TO OBTAIN COPY OF TOWER ERECTION DRAWINGS FROM VERICON CONSTRUCTION MANAGER PRIOR TO DRILLING TOWER FOUNDATIONS. CASSIONS AND TOWER SHOWN ON THIS PLAN ARE ILLUSTRATIVE, SEE DESIGN DRAWING BY OTHERS. DO NOT

8921 RESEARCH DRIVE CHARLOTTE, NORTH CAROLINA 28263

PROJECT INFORMATION:

SITE NAME: **SWALLOWTAIL** SITE No.: 431713 PROJECT#: N/A 452 FARM LIFE SCHOOL RD CARTHAGE, NC 28327 MOORE COUNTY

PLANS PREPARED BY:

AMBER PARK DRIVE, SUITE 600 ALPHARETTA, CA 30009 PHONE: 770-619-4280 WWW.KIMLEY-HORN.COM NC License F-0102

REV: DATE: ISSUED FOR: BY: 3 03/07/22 CONSTRUCTION DRC 2 12/13/21 CONSTRUCTION DRC 1 10/11/21 CONSTRUCTION DRC 0 09/07/21 CONSTRUCTION DRC

LICENSER:

KHA PROJECT NUMBER: 013509278

CHECKED BY: DRAWN BY:

JAR

SHEET TITLE:

SITE PLAN

SHEET NUMBER:

C2

GRAPHIC SCALE: 1" = 20'

COMMUNITY MEETING REPORT

Monday, March 14, 2022, 1:00 p.m. – 2:00 p.m.

Proposed Wireless Communications Facility – Farm Life School Rd.

Community Members Present: Steven Caddell, Mary W. McNeill

Applicant's Representative Present: Victoria Farmer, David Best, Russell Cambria

Planning Staff Present: Jaimie Walters

Ms. Farmer, Mr. Best and Mr. Cambria were available to answer questions as they were asked. Mr. Steven Caddell asked about health concerns and impact on property values. Ms. Farmer assured Mr. Caddell that there were no more health impacts from the proposed tower than from a wi-fi router in his own home. Mr. Best also told Mr. Caddell that the property values are likely to benefit rather than suffer. Ms. Farmer indicated that she would have an appraisal study done for the area to show property value impacts. Mr. Caddell also asked if there would be new power poles installed to run electricity from the tower. Mr. Best and Ms. Farmer indicated that if any were added, it would be minimal and that utilities will be run underground as much as possible.

Mrs. McNeill was at the meeting to represent her son, Mr. John McNeill, who is an adjacent property owner but couldn't make the meeting. She asked about the location of the nearest tower to the proposed site. Mr. Best was not able to give a certain answer for that but did show Mrs. McNeill the search area that was done for this site and that nothing was located within it and around it. Mrs. McNeill also asked about the elevation of the proposed site above sea level. Mr. Best told her it was 372.2' above sea level.

List of those notified of the Community Meeting (certified mailings to adjacent properties):

LATIMER DILLAN HUNTER &	ADULT & TEEN CHALLENGE	LYERLY LAWRENCE JR &
LATIMER JENNA LEAH	OF SANDHILLS	LYERLY ELIZABETH C
BRADY VENTURES LLC	MCNEILL JOHN WOODWARD MCNEILL CARYN COPPEGE	CADDELL CHARLES STEVE CADDELL DREMA

Attachments:

• Site plan presented at the Community Meeting

Submitted by,

Jaimie Walters, MPA, CZO Senior Planner – Moore County Planning and Inspections

verizon^v

8921 RESEARCH DRIVE CHARLOTTE, NC 28262

SWALLOWTAIL

SITE ADDRESS (E-911 TBD)

452 FARM LIFE SCHOOL RD CARTHAGE, NC 28327 MOORE COUNTY

LATITUDE: 35° 18' 30.40" N LONGITUDE: 79° 21' 19.10" W

PARCEL ID: 00006478 TAX/PIN #: 859600471781 ZONING: RA

PROPOSED REZONING: RA/CZ

A. EXISTING PROPERTY SQUARE FOOTAGE: 1,233,140 SQUARE FEET B. EXISTING PROPERTY IMPERVIOUS SURFACES AREA: 46,750 SQUARE FEET

C. EXISTING BUILT UPON AREA: 3.79%

D. PROPOSED IMPERVIOUS SURFACED: 4,597 SQUARE FEET E. PROPOSED BUILT UPON AREA: 4.16% (0.37% INCREASE)


MOORE COUNTY SHERIFF 302 S McNEIL ST CARTHAGE, NC 28327 PHONE: (910) 947-2931

ATTN.: CUSTOMER SERVICE

CARTHAGE FIRE DEPARTMENT

4396 US-501

CARTHAGE, NC 28327 PHONE: (910) 947-2226 ATTN.: CUSTOMER SERVICE

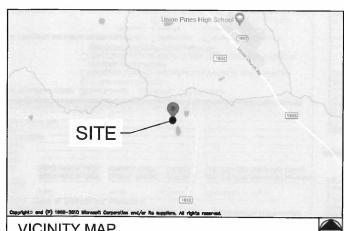

VICINITY MAP

FROM CHARLOTTE OFFICE: TAKE RESEARCH DR TO W W.T.HARRIS BLVD (1.2MI); FOLLOW I-485 INNER AND NC-24 E/NC-27 E TO UNION CHURCH RD IN CARTHAGE (93.6MI); CONTINUE ON UNION CHURCH RD. DRIVE TO FARM LIFE SCHOOL RD (4.2MI); SLIGHT RIGHT ONTO UNION CHURCH RD (3.6MI) TURN RIGHT ONTO FARM LIFE SCHOOL RD (0.6MI) DESTINATION WILL BE ON YOUR RIGHT

DRIVING DIRECTIONS

JURISDICTION: MOORE COUNTY

STATE: NORTH CAROLINA

TOWER TYPE:
MONOPOLE TOWER

TOWER HEIGHT: 195' (199' TO HIGHEST APPURTENANCE)

NUMBER OF CARRIERS: 0 EXISTING, 1 PROPOSED

USE:
PROPOSED TELECOMMUNICATIONS TOWER
AND UNMANNED EQUIPMENT

FLOOD INFO
SITE IS LOCATED WITHIN FEMA FLOOD MAP
AREA 3710858600J DATED 10/17/2006 WITHIN
FLOOD ZONE X.

PROJECT SUMMARY

This document, together with the concepts and designs presented herein, as an instrument of service, is intended only for the specific purpose and differt for which it was prepared. Reuse of and improper reliance on this document without written authorization and adaptation by Kirnley-Horn and Ass

DEVELOPER VERIZON WIRELESS 8921 RESEARCH DRIVE CHARLOTTE, NC 28262 PHONE: (704) 577-8785 ATTN: MICHAEL HAVEN

POWER COMPANY
CENTRAL ELECTRIC MEMBERSHIP CORP.
PHONE: (800) 774-4900
ATTN.: CUSTOMER SERVICE

PROPERTY OWNER
ADULT & TEEN CHALLENGE OF SANDHILLS
PO BOX 1701
SOUTHERN PINES, NC 28388
PHONE: (910) 947-2944
ATTN.: SAL DIBIANCA

CONSULTANT

KIMLEY-HORN AND ASSOCIATES, INC. 11720 AMBER PARK DRIVE, SUITE 600 ALPHARETTA, GEORGIA 30009 PHONE: (770) 545-6105 ATTN.: DAVID FRANKLIN

CONTACTS

SHEET NO.	SHEET TITLE
T1	COVER SHEET
T2	APPENDIX B - BUILDING CODE SUMMARY
	SURVEY SHEET (1 OF 3)
	SURVEY SHEET (2 OF 3)
	SURVEY SHEET (3 OF 3)
N1	GENERAL NOTES
C0	OVERALL AERIAL PLAN
C1	OVERALL SITE PLAN
C2	SITE PLAN
C3	EQUIPMENT PAD LAYOUT
C4	EQUIPMENT RACK DETAIL - FRONT
C5	EQUIPMENT RACK DETAIL - REAR
C6	CONCRETE PAD FOUNDATION DETAILS
C 7	FENCE, GATE, AND COMPOUND DETAILS
C7.1	CATTLE GATE DETAIL
C8	GRADING AND EROSION CONTROL PLAN
C9	GRADING AND EROSION CONTROL DETAILS
C10	ACCESS ROAD DETAILS
C11	SITE SIGNAGE DETAILS
C12	WAVEGUIDE BRIDGE DETAILS
C13	ANTENNA AND TOWER ELEVATION DETAILS
M1	MECHANICAL PLAN & NOTES
E1	ELECTRICAL NOTES
E2	UTILITY SERVICE ROUTING PLAN
E 3	OVERALL UTILITY ROUTING PLAN
E4	METER RACK DETAILS
E5	ELECTRICAL SINGLE LINE DIAGRAM
E6	PANEL SCHEDULE
E7	ELECTRICAL DETAILS
E8	GROUNDING NOTES
E9	GROUNDING PLAN
E10	GROUNDING SINGLE LINE DIAGRAM
E11	GROUNDING DETAILS
E12	GROUNDING DETAILS
SHEET IND	EX

MOORE COUNTY PLANNING & ZONING

1048 CARRIAGE OAKS DRIVE

PERMIT INFORMATION

CARTHAGE, NC 28327

PHONE: (910) 947-2221

ATTN .: CHARLES HILL

verizon/

CHARLOTTE, NORTH CAROLINA 28

PROJECT INFORMATION:

SITE NAME:
SWALLOWTAIL
SITE No.: 431713
PROJECT #: N/A
452 FARM LIFE SCHOOL RD
CARTHAGE, NC 28327
MOORE COUNTY

PLANS PREPARED BY:

Kimley»Horn


720 AMBER PARK DRIVE, SUITE 60X ALPHARETTA, GA 30009 PHONE: 770-619-4280 WWW.KIMEY-HORN.COM

3 03/07/22 CONSTRUCTION DRC

2 12/13/21 CONSTRUCTION DRC

1 10/11/21 CONSTRUCTION DRC

0 09/07/21 CONSTRUCTION DRC

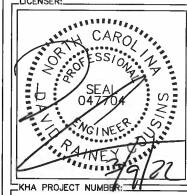

013509278

DRAWN BY: ____CHECKED BY:

______JAR __SHEET_TITLE:__

COVER SHEET

SHEET NUMBER:

Τ

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	¹ Frontage area increases from Section 506.2 are computed thus:	
2018 APPENDIX B	a. Perimeter which fronts a public way or open space having 20 feet minimum width =(F)	
BUILDING CODE SUMMARY FOR ALL COMMERCIAL PROJECTS (EXCEPT 1 AND 2-FAMILY DWELLINGS AND TOWNHOUSES)	b. Total Building Perimeter =(P) c. Ratio (F/P) =(F/P)	ACCESSIBLE DWELLING UNITS (SECTION 1107)
(Reproduce the following data on the building plans sheet 1 or 2)	d. W = Minimum width of public way = (W) e. Percent of frontage increase $I_f = 100[F/P - 0.25] \times W/30 =$ (%)	B
the state of the s	2 Unlimited area applicable under conditions of Section 507.	UNITS UNITS UNITS UNITS UNITS UNITS ACCESSIBLE UNITS
Name of Project: VERIZON WIRELESS - SWALLOWTAIL	3 Maximum Building Area = total number of stories in the huilding x D (maximum 3 stories) (506.2). 4 The maximum area of open parking garages must comply with Table 406.6.4. The maximum area of air traffic	REQUIRED PROVIDED REQUIRED PROVIDED REQUIRED PROVIDED PROVIDED DESI
Address: 452 FARM LIFE SCHOOL RD, CARTHAGE, NC Zip Code 28327	control towers must comply with Table 412.3.1.	
Owner/Authorized Agent: DAVID COUSINS Phone # (770_) 545 - 6105 Cowned By: City/County X Private E-Mail dovid.cousins City/County X Private	⁵ Frontage increase is based on the unsprinklered area value in Table 506.2.	
_ · · · · · · · · · · · · · · · · · · ·	ALLOWABLE HEIGHT	ACCESSIBLE PARKING (SECTION 1106)
Code Enforcement Jurisdiction: City X County_MOQRE State		LOT OR PARKING TOTAL # OF PARKING SPACES # OF ACCESSIBLE SPACES PROVIDED TOTAL #
CONTACT: DAVID R. COUSINS, P.E. (#047704)	ALLOWABLE SHOWN ON PLANS CODE REFERENCE	AREA REQUIRED PROVIDED REGULAR WITH VANSPACES WITH ACCESSIBLE 5' ACCESS AISLE 132" ACCESS 8' ACCESS PROVIDED
DESIGNER FIRM NAME LICENSE # TELEPHONE # E-MAIL	Building Height in Feet (Table 51545) Building Height in Stories of table 504.4)	ASLE AISLE
Architectural Civil 10MEY-HORN & ASSOC DAWD R. COUSINS 047704 (678) 274-5032 4044 control formation from		
Electrical KIMEY-HORN & ASSOC. COREIN C. HARDY 040828 (919) 877-2000 William Inc.		TOTAL
Fire Alarm () () () () () () () () () (SEIS
Mechanical ()	FIRE PROTECTION REQUIREMENTS	PLUMBING FIXTURE REQUIREMENTS Provi
Sprinkler-Standpipe Structural	BUILDING ELEMENT FIRE RATING DETAIL# DESIGN# SHEET#FOR SHEET#	(YABLE 2902.1)
Retaining Walls >5' High ()	SEPARATION REQ'D PROVIDED AND FOR RATED OR DISTANCE (W/ SHEET # RATED PENETRATION RATED	USE WATERCLOSHTS URINALS LAVATORIES SHOWERS DRINKING FOUNTAINS
("Other" should include firms and individuals such as truss, precast, pre-engineered, interior designers, etc.)	(FEET) REDUCTION) ASSEMBLY JOINTS	MALE FEMALE UNISEX MALE FEMALE UNISEX /TUBS REGULAR ACCESSIBLE SPACE EXIST'G
2018 NC BUILDING CODE: X New Building Addition Renovation	Structural Frame, including columns, girders.	NEW
i d Time Interior Completion	trusses	REQ'D
Shell/Core - Contact the local inspection jurisdiction for possible additional procedures and requirements	Bearing Walls Exterior 2	
Phased Construction - Shell/Core- Contact the local inspection jurisdiction for	North N/A 2	SPECIAL APPROVALS
possible additional procedures and requirements	East N/A 2 West N/A 2	Special approval: (Cocal Jurisdiction, Department of Insurance, OSC, DPI, DHHS, etc., describe below)
2018 NC EXISTING BUILDING CODE: EXISTING:	South N/A	Soli
☐ Historic Property ☐ Change of Use	Interior N/A	
CONSTRUCTED: (date) CURRENT OCCUPANCY(S) (Ch. 3): TELECOMMUNICATIONS_STR		-/
RENOVATED: (date) PROPOSED OCCUPANCY(S) (ch. 3):TRECOMMERCATIONS_STE	Exterior walls North N/A	
RISK CATEGORY (Table 1604.5):	East N/A	/
	West N/A South N/A	ENERGY SUMMARY
BASIC BUILDING DATA Construction Type: I-A III-A III-A IV V-A	South N/A N/A STANDARD N/A STAN	ENERGY REQUIREMENTS:
	Production /2	The following data shall be considered minimum and any special attribute required to meet the energy code spall also be provided. Each Designer shall furnish the required portions of the project information for the plan usfa sheet.
Sprinklers: No Partial Yes NFPA 13 NFPA 13R NFPA 13D	Including supporting beams and joists	If performance method, state the annual energy cost for the standard reference design vs annual energy cost for the
Standpipes: No Yes Class 1 1 1 1 Wet Dry	Floor Ceiling Assembly 2	proposed design.
Fire District:	Columns Supporting Floors Roof Construction, including supporting because of losts N/A	Existing building envelope complies with code: No Yes (The remainder of this section is not applicable)
procedures and regardments.)	supporting beans and jossts N/A Roof Ceiling Assembly N/A	Exempt Building: No Yes (Provide code or statutory reference):
- 414	Columns Supporting Roof N/A	Climate Zone:
Gross Building Area Table	Shaft Enclosures - Exit N/A Shaft Enclosures - Other N/A	Method of Compliance: Energy Code Performance Prescriptive
FLOOR		ASHRAE 90.1 Performance Prescriptive
2 rd Floor	Corridor Separation N/A Occupancy/Fire Barrier Separation N/A	(If "Other" specify source here)
Merzanine	Party/Fire Walt Separation N/A	THERMAL ENVELOPE (Prescriptive method only)
Basement	Smoke Partition N/A N/A	Roof/ceiling Assembly (each assembly)
345' 345'	Tenant/Dwelling Unit: N/A	Description of assembly:
ALLOWABLE AREA	Incidental Use Separation N/A	U-Value of total assembly: R-Value of insulation:
Primary Occupancy Classification(s): Select one Select one Select one Select one Select one	Indicage section number permitting reduction	R-Value of insulation: Skylights in each assembly: U-Value of skylight:
		total square footage of skylights in each assembly:
Business Therefore D	PERCENTAGE OF WALL OPENING CALCULATIONS	Exterior Walls (each assembly)
Educational Factory F-1 Moderate F-2 Low Ilazardous H-1 Detonate H-2 Deflagrate H-3 Combust H-4 Health H-5 HPM	FIRE SEPARATION DISTANCE DEGREE OF OPENINGS ALLOWABLE AREA ACTUAL SHOWN ON PLANS	Description of assembly:
H-1 Detonate ☐ H-2 Deflagrate ☐ H-3 Combust ☐ H-4 Health ☐ H-9 HPM	(FEET) FROM PROPERTY LINES PROTECTION (%) (%) (%)	U-Value of total assembly: R-Value of insulation:
I Institutional I I - Condition I I I I -		Openings (windows or doors with glazing)
☐ I-3 Condition ☐ 1 ☐ 2 ☐ 3 ☐ 4 ☐ 5		U-Value of assembly: Solar heat gain coefficient:
M		projection factor: Door R-Valves:
Residential R-1 R-2 R-3 R-4		
Storage S-1 Moderate S-2 Low High-piled	LIFE SAFETY SYSTEM REQUIREMENTS	Walls below grade (each desembly) Description of desembly:
☐ Parking Garage ☐ Open ☐ Enclosed ☐ Repair Garage Utility and Miscellaneous ☐	Emergency Lighting: No X Yes Exit Signs: No X Yes	U-Value of total assembly:
Assessment Operation of Chart fine Hone (a):	Fire Alarm: No 🗓 No 🛣 Yes	R-Value of insulation:
Incidental Uses (Table 509):	Smoke Detection Systems: No 🛭 No 🛣 Yes 🗌 Partial	Floors over unconditioned space (each assembly)
Special Uses (Chapter 4 – List Code Sections): Special Provisions: (Chapter 5 – List Code Sections):	Carbon Monoxide Detection: 🛛 No 🗌 Yes	Description of assembly:
Special Provisions: (Chapter 5 - List Code Sections): Mixed Occupancy: No Yes Separation: Hr. Exception:	THE CONTRACT OF THE PARTY OF TH	R-Value of insulation:
Non-Separated Use (508.3) - The required type of construction for the building shall be determined by	LIFE SAFETY PLAN REQUIREMENTS	Floors slab on grade
applying the height and area limitations for each of the applicable occupancies to the entire building. The most restrictive type of	Life Safety Plan Sheet #:	Description of assembly: U-Value of total assembly:
construction, so determined, shall apply to the entire building.	☐ Fire and/or smoke rated wall locations (Chapter) ☐ Assumed and real property line locations (if not or the site plan)	R-Value of insulation:
Separated Use (508.4) - See below for area calculations for each story, the area of the occupancy shall	Exterior wall opening area with respect to distance to assumed property lines (705.8)	Horizontal/vertical requirement:
be such that the sum of the ratios of the actual floor area of each use divided by the floor area for each use shall not exceed 1.	Occupancy Use for each area as it relates to occupant load calculation (Table 1004.1.2)	
Actual Area of Occupuncy A + Actual Area of Occupancy B ≤1	☐ Occupant loads for each area ☐ Exit access travel distances (1017)	
Allowable Area of Occupancy A Allowable Area of Occupancy B	Common path of travel distances (Tables 1006.2.1 & 1006.3.2(1))	
+ + = ≤1.00	Dead end lengths (1020.4) Ctear exit widths for each exittor	
	Maximum calculated occupant load capacity each exit door can accommodate based on egress width (1005.3)	NOTE: SCOPE OF WORK INCLUDES INSTALLATION OF
STURY DESCRIPTION AND LUSE BLDG AREA FER TABLE 506.2 ⁴ AREA FOR FRONTAGE ALLOWABLE AREA PER STORY (ACTUAL) AREA STORY OR UNLIMITED ^{2,3}	Actual occupant load for each exit door	CAST IN PLACE CONCRETE PAD, PREFABRICATED
STORY (ACTUAL) AREA INCREASE ^{1,5} STORY OR UNLIMITED ^{2,3}	A separate schematic rlan indicating where fire rated floor/ceiling and/or roof structure is provided for purposes of occupancy separation	EQUIPMENT CABINETS AND GENERATOR.
	Location of doop with panic hardware (10!0.1.10)	NO NEW BUILDING BEING CONSTRUCTED.
	Location of delays with delayed egress locks and the amount of delay (1010.1.9.7) Location of doors with electromagnetic egress locks (1010.1.9.9)	
	Location of doors equipped with hold-open devices	
1 7	Location of emergency escape windows (1030) The square footage of each fire area (202)	
	he square footage of each smoke compartment for Occupancy Classification 1-2 (407.5)	
	Note any code exceptions or table notes that may have been utilized regarding the items above	
A		

<u> </u>	2018 APPENDIX B BUILDING CODE SUMMARY FOR ALL CO	OMMERCIAL PROJECTS
ns	STRUCTURAL DESIGN (PROVIDE ON THE STRUCTURAL SHEETS DESIGN LOADS:	S IF APPLICABLE)
_	Importance Factors: Snow (Is) $\frac{1.0}{\text{Seismic (Ie)}}$	NOTE: STRUCTURAL ANALYSIS COMPLETED BY TOWER OWNER, SEE
LE	Live Loads: Roof 93 psf Mezzanine N/A psf Floor 208 psf	ANALYSIS BY OTHERS FOR ADDITIONAL STRUCTURAL DATA.
D	Ground Snow Load: 102 psf	<u>/</u>
	Wind Load: Basic Wind Speed Exposure Category B4 Toph	(ASCE-7)
MINS SIBLE	Basic structural system Bearing Wall M Building Frame	sı_ 0.75 _%g
	Analysis Procedure: Simplified Equival	ent Lateral Force Dynamic Yes No
1	LATERAL DESIGN CONTROL: Earthquake X Wind X	
_		psf psf
/		
II sheet.	2018 APPENDIX E BUILDING CODE SUMMARY FOR ALL CO MECHANICAL DESIGN (PROVIDE ON THE MECHANICAL SHEET	OMMERCIAL PROJECTS
he	MECHANICAL SUMMAR	
	MECHANICAL SYSTEMS, SERVICE SYSTEMS AND EQUIPM	
1	Thermal Zone	
- 1	winter dry bulb:	
	Interior design conditions	
-	winter dry bulb: summer dry bulb: relative humidity:	
	Building heating load:	
-	Building cooling load:	
	Mechanical Spacing Conditioning System Unitary	
	Unitary description of unit: heating efficiency:	
	neating electricity: cooling efficiency: size_stregory of unit:	
	Boilpr Size category. If oversized, state reason.:	NC-121
	Chiller Size category. If oversized, state reason.:	
١	List equipment efficiencies:	
١		
	2018 APPENDIX BUILDING CODE SUMMARY FOR ALL C ELECTRICAL DESIGN (PROVIDE ON THE ELECTRICAL SHEET	OMMERCIAL PROJECTS
1	ELECTRICAL SUMMAR	
1	ELECTRICAL SYSTEM AND EQUIPMENT	
	Method of Compliance: Energy Code Performance ASHRAE 90.1 Performance	Prescriptive Prescriptive
	Lighting schedule (each fixture type) lamp type required in lixture	
	number of lamps in fixture ballast type used in the fixture	
	number of ballasts in fixture total wattage per fixture total interior wattage specified vs. allowed (whole bu total exterior wattage specified vs. allowed	ilding or space by space)
	Additional Efficiency Package Options (When using the 2018 MCECC; not required for ASHRAE	
1	C406.2 More Efficient HVAC Equipment Periori C406.3 Reduced Lighting Power Density C406.4 Enhanced Digital Lighting Controls	
	C406.5 On-Site Renewable Energy C406.6 Dedicated Outdoor Air System	
	C406.7 Reduced Energy Use in Service Water Ho	eating
		afficient de la companya de la comp
1		



8921 RESEARCH DRIVE CHARLOTTE, NORTH CAROLINA 28262

PROJECT INFORMATION:

SITE NAME: SWALLOWTAIL SITE No.: 431713 PROJECT #: N/A 452 FARM LIFE SCHOOL RD CARTHAGE, NC 28327 MOORE COUNTY

PLANS PREPARED BY:

Kimley»Horn

11720 AMBER PARK DRIVE, SUITE 600 ALPHARETTA, GA 30009 PHONE: 770-819-4280 WWW.KIMLEY-HORN.COM NC License F-0102

CAROL SESSION N SESS

KHA PROJECT NUMBER: 013509278

DRAWN BY: ____CHECKED BY:


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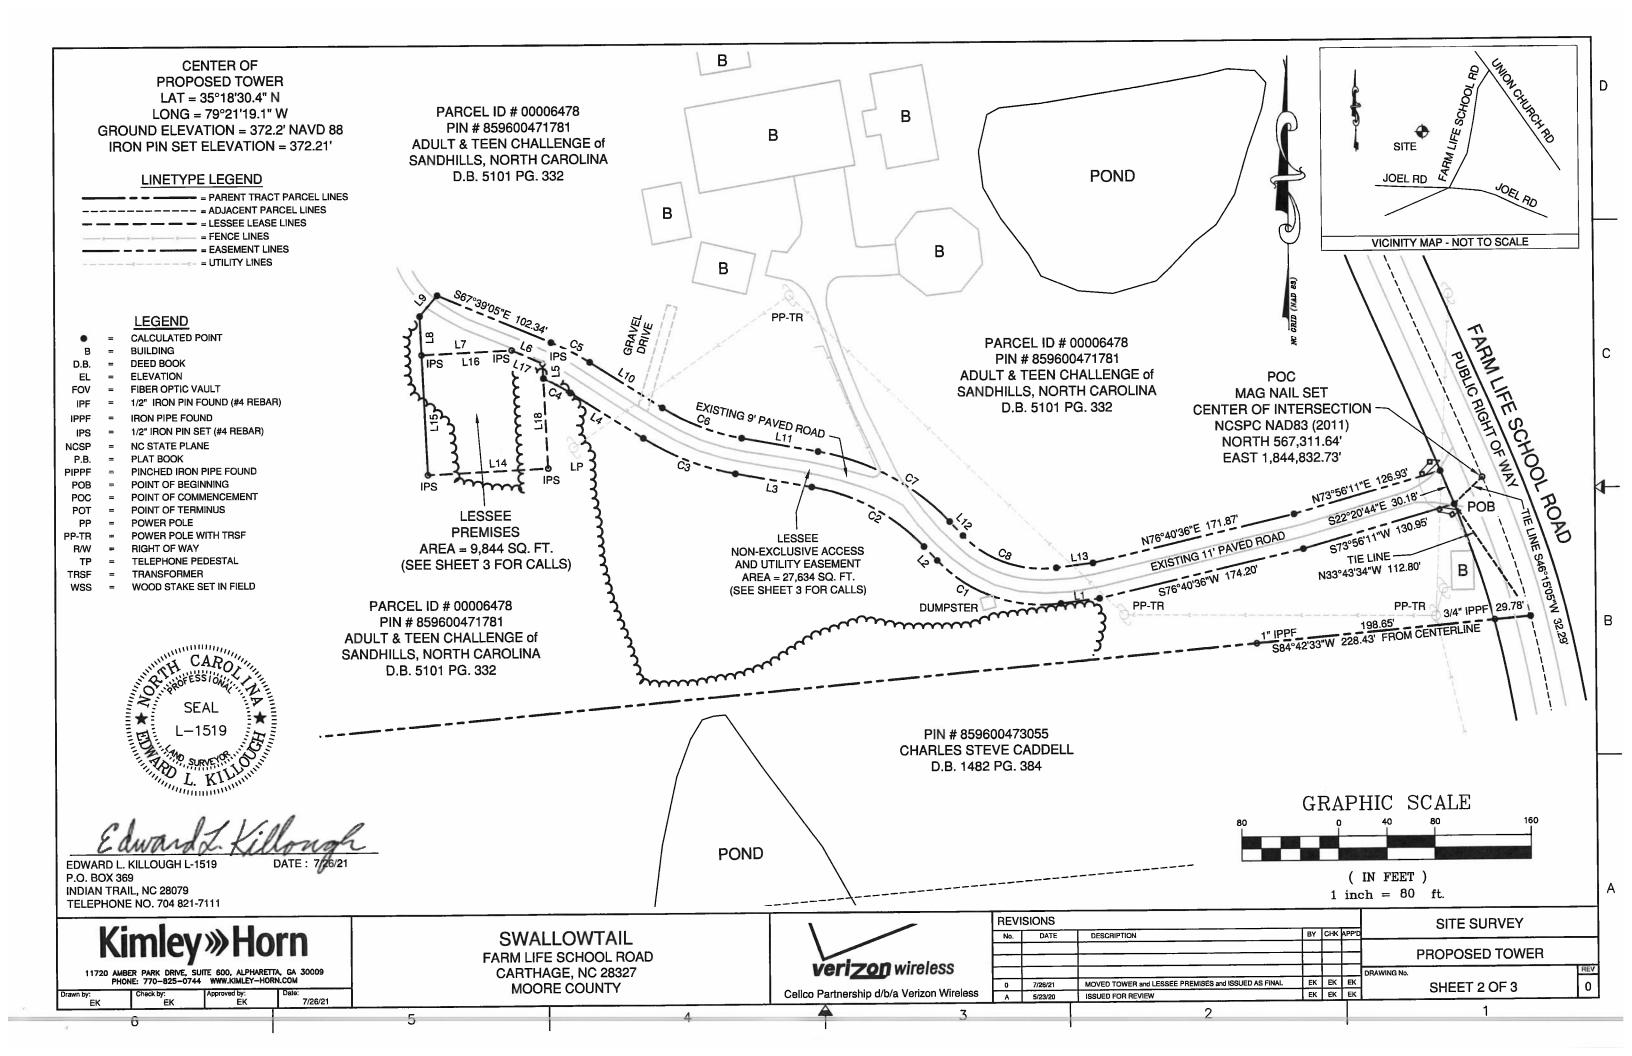
SHEET TITLE:


APPENDIX B -BUILDING CODE SUMMARY

SHEET NUMBER:

T2



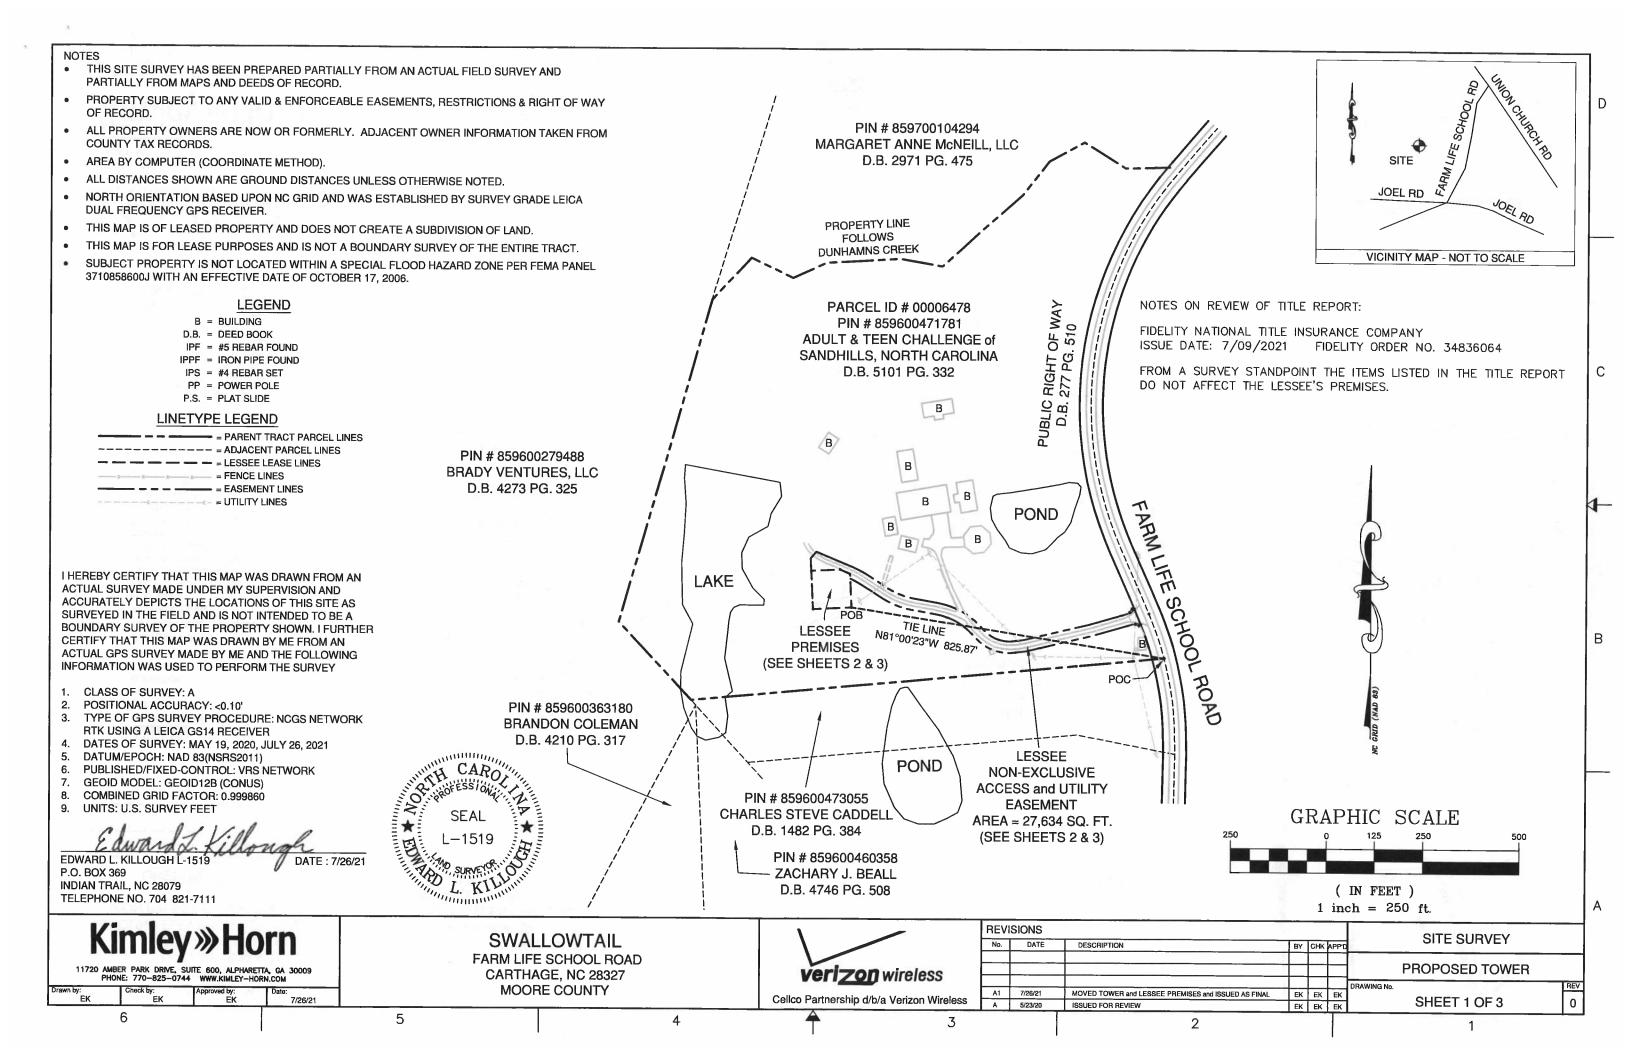

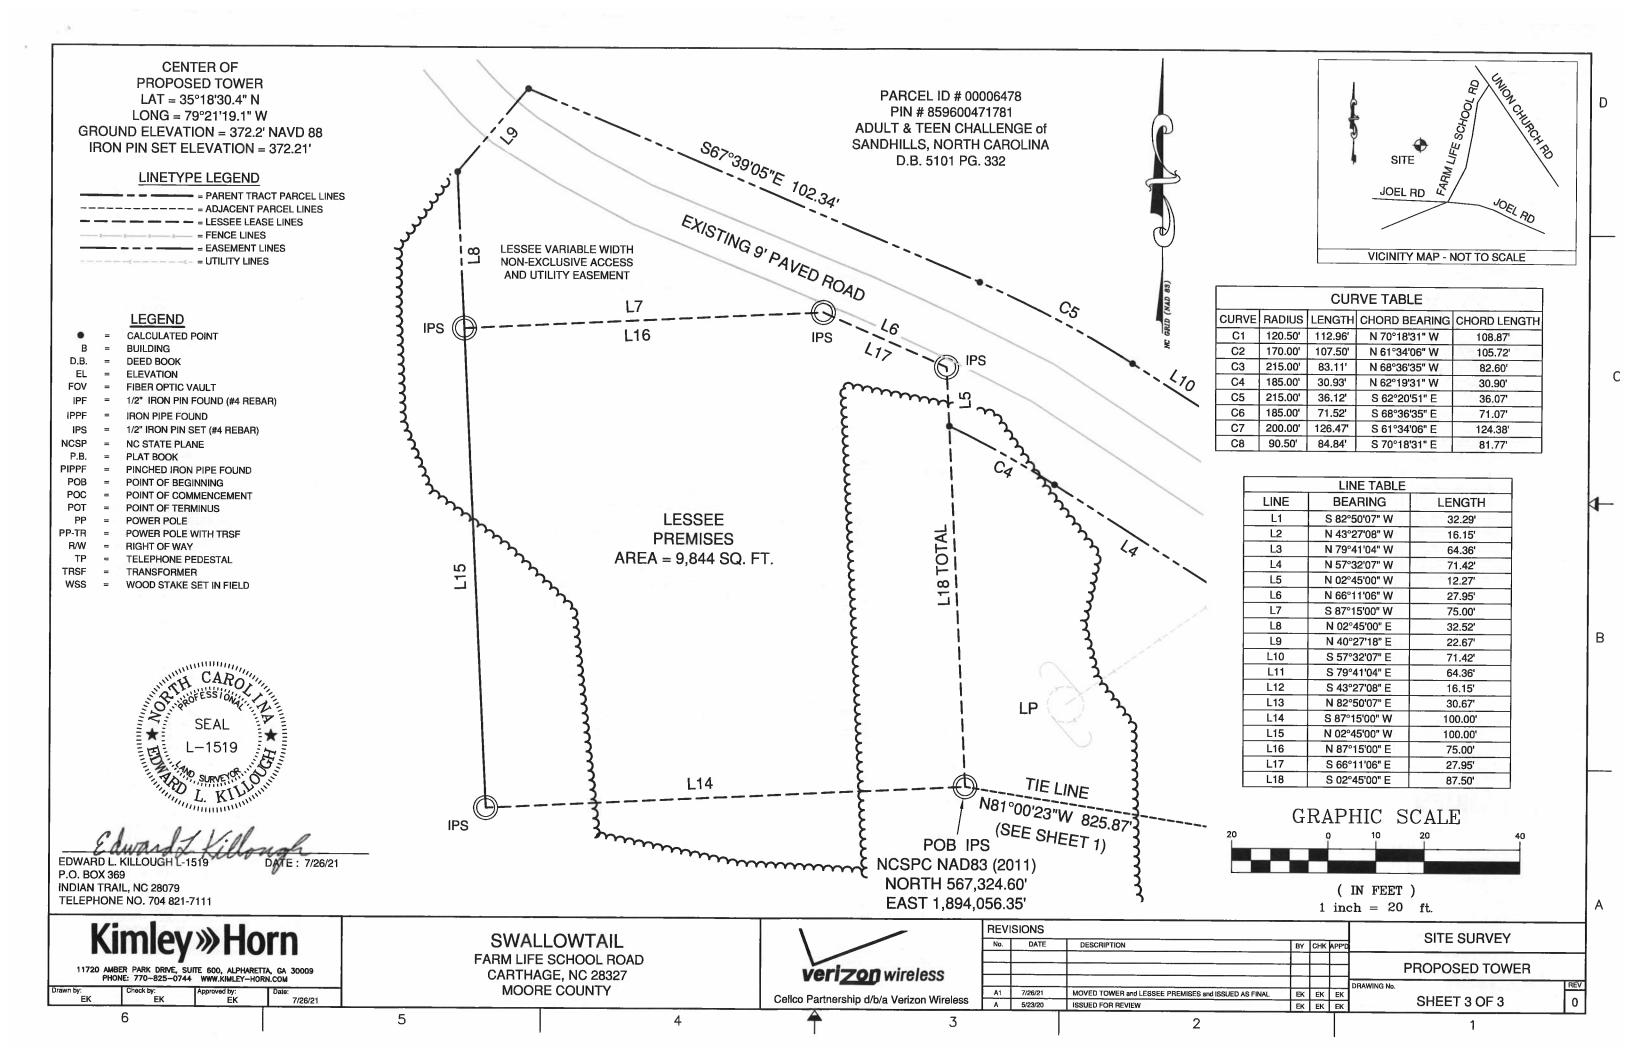

1.00 GENERAL NOTES

- 1.01 ALL MATERIALS AND WORKMANSHIP SHALL CONFORM TO THE DRAWINGS AND SPECIFICATIONS. ALL WORK SHALL BE DONE IN ACCORDANCE WITH THE LATEST EDITION OF THE STATE, LOCAL AND NATIONAL CODES, ORDINANCES AND OR REGULATIONS APPLICABLE TO THIS PROJECT.
- 1.02 THE CONTRACTOR SHALL BE RESPONSIBLE FOR COORDINATING THE WORK OF ALL TRADES AND SHALL CHECK ALL DIMENSIONS. ALL DISCREPANCIES SHALL BE CALLED TO THE ATTENTION OF THE PROJECT MANAGER AND/OR ENGINEER AND BE RESOLVED BEFORE PROCEDING WITH WORK. WHERE THERE IS A CONFLICT BETWEEN DRAWING AND VERIZON SPECIFICATIONS, THE VERIZON PROJECT ENGINEER SHOULD BE CONTACTED FOR CLARIFICATION.
- 1.03 ALL INFORMATION SHOWN ON THE DRAWINGS RELATIVE TO EXISTING CONDITIONS IS GIVEN AS THE BEST PRESENT KNOWLEDGE, BUT WITHOUT GUARANTEE OF ACCURACY. WHERE ACTUAL CONDITIONS CONFLICT WITH THE DRAWINGS, THEY SHALL BE REPORTED TO THE PROJECT MANAGER AND/OR ENGINEER SO THAT PROPER REVISIONS MAY BE MADE. MODIFICATION OF DETAILS OF CONSTRUCTION SHALL NOT BE MADE WITHOUT WRITTEN APPROVAL OF THE PROJECT MANAGER AND/OR ENGINEER.
- 1.04 CONTRACTOR SHALL REVIEW AND BE FAMILIAR WITH SITE CONDITIONS AS SHOWN ON THE ATTACHED SITE PLAN AND/OR SURVEY DRAWNGS.
- 1.05 WAVEGUIDE BRIDGE AND EQUIPMENT CABINETS ARE SHOWN FOR REFERENCE ONLY. REFER TO SEPARATE DRAWINGS FOR SPECIFIC INFORMATION.
- 1.06 ALL FINISHED GRADES SHALL SLOPE MINIMUM 1/4 IN./FT. AWAY FROM EQUIPMENT IN ALL DIRECTIONS. CONTRACTOR SHALL SLOPE SWALES AS REQUIRED ALONG EXISTING TERRAIN TO DRAIN AWAY FROM COMPOUND AND ACCESS DRIVE.
- 1.07 THE PROPOSED TOWER AND TOWER FOUNDATIONS WERE DESIGNED BY OTHERS. TOWER INFORMATION PROVIDED ON THESE PLANS ARE PROVIDED FOR REFERENCE PURPOSES ONLY. NOTIFY ENGINEER OR PROJECT MANAGER OF ANY CONFLICTS OR DISCREPANCIES. CONTRACTOR TO OBTAIN COPY OF TOWER DESIGN DRAWINGS, IF AVAILABLE, FROM VERIZON PROJECT MANAGER TO CONFIRM COAX ROUTING AND ANTENNA MOUNT INFORMATION.
- 1.08 THE CONTRACTOR SHALL PROVIDE ADEQUATE EXCAVATION SLOPING, SHORING, BRACING, AND GUYS IN ACCORDANCE WITH ALL NATIONAL, STATE, AND LOCAL SAFETY ORDINANCES.
- 1.09 UPON COMPLETION OF CONSTRUCTION, CONTRACTOR IS RESPONSIBLE FOR REPAIRING ANY DAMAGE CAUSED BY CONSTRUCTION ACTIVITIES TO THE EXISTING ACCESS ROAD AND COMPOUND GRAVEL AREAS. ANY NEW FILL MATERIALS SHALL BE COMPACTED.
- 1.10 THE CONTRACTOR IS HEREBY NOTIFIED THAT PRIOR TO COMMENCING CONSTRUCTION, HE IS RESPONSIBLE FOR CONTACTING THE UTILITY COMPANIES INVOLVED AND SHALL REQUEST A VERIFICATION AT THE CONSTRUCTION SITE OF THE LOCATIONS OF THEIR UNDERGROUND UTILITIES AND WHERE THEY MAY POSSIBLY CONFLICT WITH THE PLACEMENT OF IMPROVEMENTS AS SHOWN ON THESE PLANS. THE CONTRACTOR OR ANY SUBCONTRACTOR FOR THIS CONTRACT WILL BE REQUIRED TO NOTIFY "NORTH CAROLINA 811" 48 HOURS IN ADVANCE OF PERFORMING ANY WORK BY CALLING THE TOLL FREE NUMBER (800) 632-4949 (OR 811). ANY UTILITIES DAMAGED BY CONSTRUCTION ACTIVITIES SHALL BE REPAIRED BY THE CONTRACTOR, AT NO EXPENSE TO THE OWNER.
- 1.11 CONTRACTOR TO PROVIDE DUMPSTER AND PORTABLE TOILET FACILITY DURING CONSTRUCTION.
- 1.12 CONTRACTOR TO PROVIDE STYMIE LOCK OR EQUIVALENT AS APPROVED BY VERIZON PROJECT MANAGER.
- 1.13 CONTRACTOR TO PROVIDE ANY NECESSARY SIGNAGE PER VERIZON PROJECT MANAGER'S INSTRUCTIONS. SEE DETAIL ON SHEET C11.

2.00 EQUIPMENT FOUNDATION NOTES

- 2.01 FOUNDATIONS ARE DESIGNED FOR A PRESUMPTIVE ALLOWABLE SOIL BEARING CAPACITY OF 2,000 PSF. CONTRACTOR SHALL VERIFY SOIL CONDITIONS AND BEARING CAPACITY PRIOR TO CONSTRUCTION.
- 2.02 EXCAVATE A MINIMUM 18" BELOW PROPOSED EQUIPMENT FOUNDATIONS OF EXPANSIVE, ORGANIC, UNCONSOLIDATED OR OTHERWISE UNACCEPTABLE MATERIAL AND REPLACE WITH WELL—COMPACTED MATERIAL ACCEPTABLE TO VERIZON.
- 2.03 CONTRACTOR SHALL BE RESPONSIBLE FOR LOCATING, PROTECTING, AND RELOCATING AS REQUIRED ALL SERVICE AND UTILITY LINES IN VICINITY OF THE WORK SITE. ALL EXCAVATIONS NEAR THESE LINES TO BE CARRIED OUT WITH EXTREME CAUTION. COORDINATE ALL RELOCATIONS WITH THE PROPERTY OWNER.
- 2.04 CONTRACTOR TO CUT/FILL EXISTING COMPOUND SUBSOIL TO PROVIDE AN AREA AS LEVEL AS POSSIBLE FOR THE EQUIPMENT FOUNDATIONS. ALL FILL AREAS ARE TO BE FILLED WITH SUITABLE MATERIALS. FILL MATERIALS ARE TO BE PLACED, COMPACTED, AND TESTED IN MAXIMUM LAYERS OF 8". COMPACTION OF ALL FILL MATERIAL SHALL ACHIEVE 95 PERCENT OF MAXIMUM DRY DENSITY AT OPTIMUM MOISTURE CONTENT IN ACCORDANCE WITH ASTM D 698. ALL TESTS MUST MEET THE MINIMUM SPECIFIED SOIL BEARING CAPACITY. COMPACTION TESTING IS BY THE GEOTECHNICAL TESTING COMPANY DESIGNATED FOR THE PROJECT. SCHEDULING AND COORDINATION IS THE RESPONSIBILITY OF THE GENERAL CONTRACTOR. REPORTS OF ALL TESTING ARE TO BE PROMPTLY DELIVERED OR FAXED TO THE VERIZON WIRELESS PROJECT MANAGER.
- 2.05 CONCRETE SHALL HAVE A MINIMUM COMPRESSIVE STRENGTH OF 4,000 PSI AT 28 DAYS AND SHALL BE INSTALLED IN ACCORDANCE WITH THE LATEST REVISION TO ACI-318 BUILDING CODE REQUIREMENTS FOR REINFORCED CONCRETE.
- 2.06 CONCRETE SHALL HAVE A SLUMP BETWEEN 3" AND 6".
- 2.07 FIBERS FOR CONCRETE SHALL BE FIBERMESH 650, 100 PERCENT VIRGIN POLYPROPYLENE FIBRILLATED FIBERS, e3 PATENTED TECHNOLOGY PATENTED TECHNOLOGY, CONTAINING NO REPROCESSED OLEFIN MATERIALS. THE FIBERS SHALL CONFORM TO ASTM C1116 TYPE III AND MANUFACTURED SPECIFICALLY FOR THE SECONDARY REINFORCEMENT OF CONCRETE.
- 2.08 THE FIBERS SHALL BE MANUFACTURED IN AN ISO 9001: 2008 CERTIFIED MANUFACTURING FACILITY. UNLESS OTHERWISE STATED, FIBERMESH 650 MACRO—SYNTHETIC FIBERS SHALL BE ADDED TO THE CONCRETE AT THE BATCHING PLANT AT THE RECOMMENDED APPLICATION RATE OF 3 LBS/YD³ AND MIXED FOR A SUFFICIENT TIME (MINIMUM 5 MINUTES AT FULL MIXING SPEED) TO ENSURE UNIFORM DISTRIBUTION OF THE FIBERS THROUGHOUT THE CONCRETE. FIBROUS CONCRETE REINFORCEMENT SHALL BE MANUFACTURED BY FIBERMESH, 4019 INDUSTRY DRIVE, CHATTANOOGA, TN 37416 USA, TEL: 800 621-1273, WEBSITE: WWW.FIBERMESH.COM
- 2.09 AT THE REQUEST OF THE VERIZON WRELESS PROJECT MANAGER, TEST CYLINDERS SHALL BE MOLDED AND LABORATORY CURED IN ACCORDANCE WITH ASTM C31. THREE CYLINDERS SHALL BE TAKEN FOR EACH DAY'S CONCRETE PLACEMENT. CYLINDERS SHALL BE TESTED IN ACCORDANCE WITH THE LATEST REVISION TO ASTM C39.
- 2.10 CHAMFER ALL EXPOSED EXTERNAL CORNERS OF CONCRETE WITH $\frac{3}{4}$ " x 45° CHAMFER, UNLESS OTHERWISE NOTED.
- 2.11 CONCRETE FORMWORK IS TO BE STRIPPED WITHIN 48 HOURS. VIBRATION OF THE CONCRETE MUST ASSURE THAT HONEYCOMBING WILL BE AT A MINIMUM.

 MECHANICAL VIBRATION OF ALL CONCRETE IS REQUIRED UNLESS OTHERWISE DIRECTED BY VERIZON WIRELESS' PROJECT MANAGER. ABOVE GRADE CONCRETE IS TO BE RUBBED AND PATCHED TO ASSURE SMOOTH FINISH AT TIME OF FORMS REMOVAL. CONTRACTOR SHALL PROVIDE A BROOM FINISH ON THE TOP SURFACE OF THE EQUIPMENT FOUNDATION UNLESS OTHERWISE DIRECTED BY VERIZON WIRELESS' PROJECT MANAGER.
- 2.12 TOPS OF CONCRETE FOUNDATION MUST BE WITHIN 0.02' OF ELEVATION REQUIRED.
- 2.13 TOP OF FOUNDATION FINISH TO BE LEVEL ±1/2" IN 10'.
- 2.14 TOP OF FOUNDATION TO HAVE MEDIUM BROOM FINISH.

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2.15 CONTRACTOR SHALL REFER TO DRAWINGS OF OTHER TRADES AND VENDOR DRAWINGS FOR EMBEDDED ITEMS AND RECESSES NOT SHOWN ON THE STRUCTURAL DRAWINGS. CONTRACTOR SHALL VERIFY PLACEMENT OF EQUIPMENT AND LOCATION OF CONDUIT FOR MANUFACTURER'S AND VENDORS SPECIFICATIONS. IT SHALL BE THE RESPONSIBILITY OF THE CONTRACTOR TO PROVIDE ALL OPENINGS AND SLEEVES FOR PROPER DISTRIBUTION OF ALL UTILITIES.

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8921 RESEARCH DRIVE

PROJECT INFORMATION:

SITE NAME: SWALLOWTAIL SITE No.: 431713 PROJECT#: N/A 452 FARM LIFE SCHOOL RD CARTHAGE, NC 28327 MOORE COUNTY

TPLANS PREPARED BY:

Kimley Whorn

11720 AMBER PARK DRIVE, SUITE 600 ALPHARETTA, GA 30009 PHONE: 770-619-4280 WWW.KIMLEY-HORN.COM NC License F-0102

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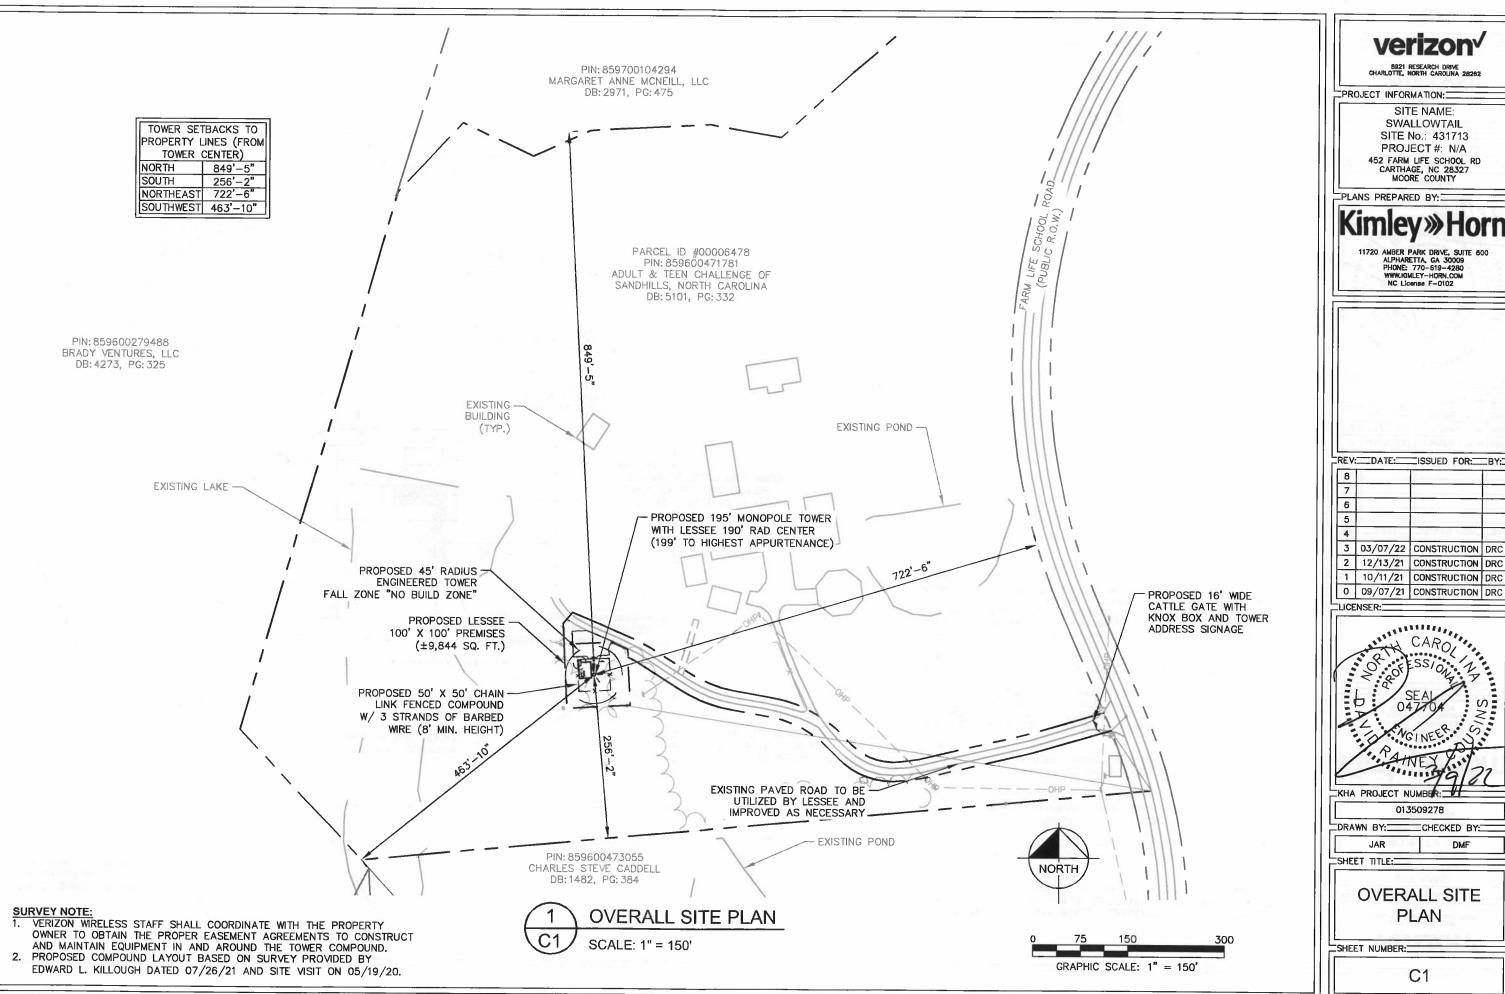
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GENERAL NOTES

SHEET NUMBER:

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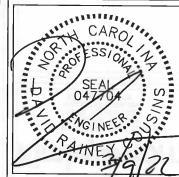
8921 RESEARCH DRIVE CHARLOTTE, NORTH CAROLINA 28282

SITE NAME: **SWALLOWTAIL** SITE No.: 431713 PROJECT#: N/A 452 FARM LIFE SCHOOL RD CARTHAGE, NC 28327 MOORE COUNTY

11720 AMBER PARK DRIVE, SUITE 800 ALPHARETTA, GA 30009 PHONE: 770-619-4280 WWW.KMLEY-HORN.COM NC LICENSE F-0102


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CHECKED BY:

OVERALL SITE PLAN



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SITE NOTES:

- 1. VERIZON WRELESS STAFF SHALL COORDINATE WITH THE PROPERTY OWNER AND/OR TOWER OWNER TO OBTAIN THE PROPER EASEMENT AGREEMENTS TO CONSTRUCT AND MAINTAIN EQUIPMENT IN AND AROUND THE TOWER COMPOUND.
- 2. PROPOSED COMPOUND LAYOUT BASED ON SURVEY PROVIDED BY EDWARD L. KILLOUGH DATED 07/26/21 AND SITE VISIT ON 07/26/21.
- 3. CONTRACTOR TO CONFIRM WITH VERIZON CONSTRUCTION MANAGER THAT THE SHELTER/EQUIPMENT SHOWN HAS BEEN ORDERED/SCHEDULED FOR DELIVERY TO THIS SITE.
- 4. THE BASIS OF EQUIPMENT DESIGN INCLUDES ONE (1) RF CABINET, ONE (1) FUTURE BATTERY CABINET, AND ONE (1) FUTURE EXPANSION CABINET.
- 5. GENERAL CONTRACTOR SHALL BE RESPONSIBLE FOR COORDINATING AND MODIFYING SCOPE OF WORK TO ACCOMMODATE ANY CHANGES IN THE EXACT EQUIPMENT PROCURED BY VERIZON WIRELESS. COORDINATE ANY CHANGES WITH VERIZON WIRELESS CONSTRUCTION MANAGER.
- 6. ROUTE COAX/FIBER UP TOWER PER STRUCTURAL ANALYSIS BY TOWER OWNER.
- 7. TOWER DIMENSIONS SHOWN ON THIS PLAN ARE FOR TOWER CENTER LOCATION. CONTRACTOR TO OBTAIN COPY OF TOWER ERECTION DRAWINGS FROM VERICON CONSTRUCTION MANAGER PRIOR TO DRILLING TOWER FOUNDATIONS. CASSIONS AND TOWER SHOWN ON THIS PLAN ARE ILLUSTRATIVE, SEE DESIGN DRAWING BY OTHERS. DO NOT

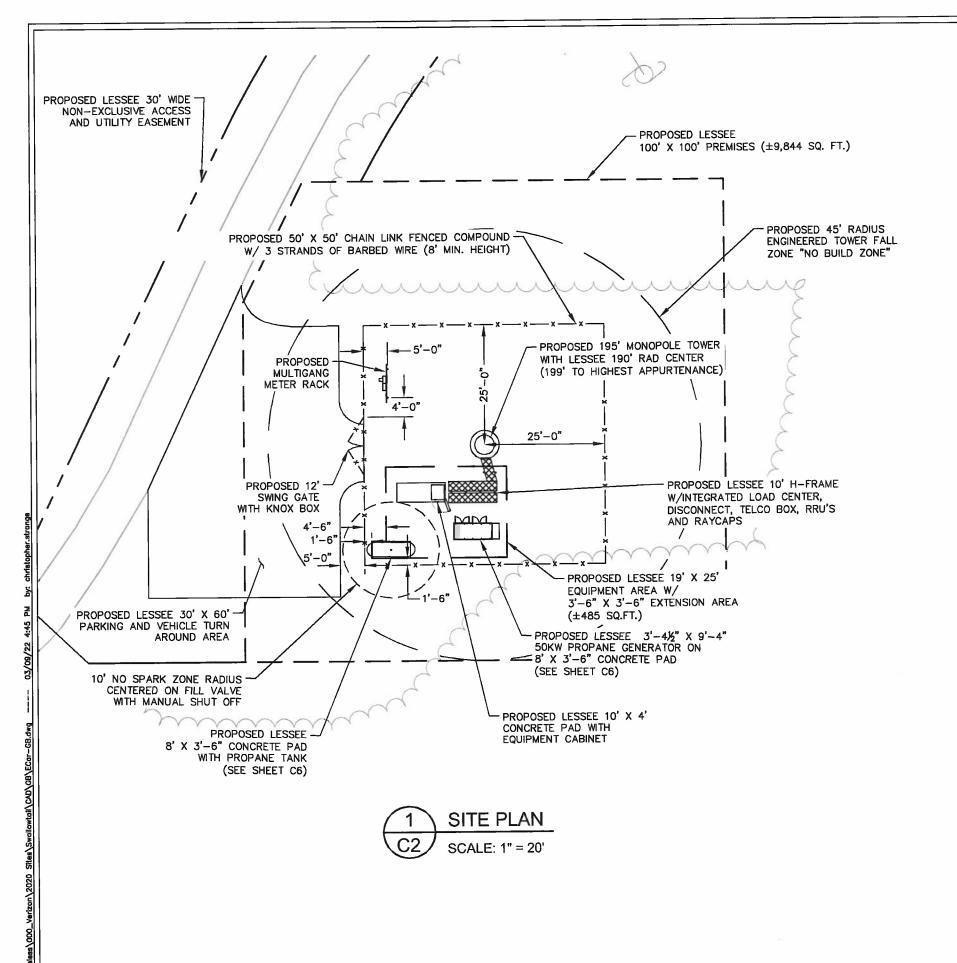8921 RESEARCH DRIVE CHARLOTTE, NORTH CAROLINA 28263

PROJECT INFORMATION:

SITE NAME: **SWALLOWTAIL** SITE No.: 431713 PROJECT#: N/A 452 FARM LIFE SCHOOL RD CARTHAGE, NC 28327 MOORE COUNTY

PLANS PREPARED BY:

AMBER PARK DRIVE, SUITE 600 ALPHARETTA, CA 30009 PHONE: 770-619-4280 WWW.KIMLEY-HORN.COM NC License F-0102

REV: DATE: ISSUED FOR: BY: 3 03/07/22 CONSTRUCTION DRC 2 12/13/21 CONSTRUCTION DRC 1 10/11/21 CONSTRUCTION DRC 0 09/07/21 CONSTRUCTION DRC

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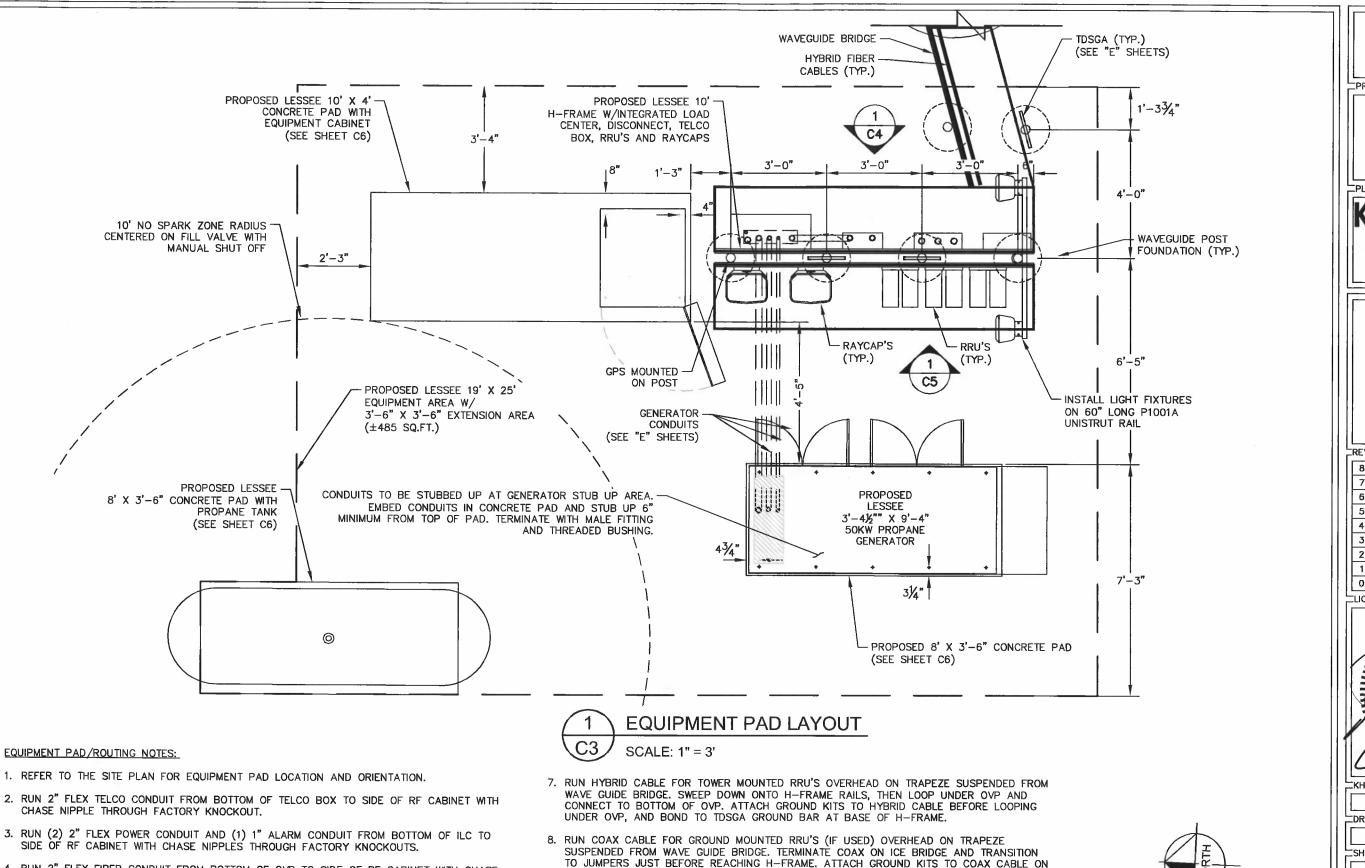
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SITE PLAN

SHEET NUMBER:

C2

GRAPHIC SCALE: 1" = 20'



4. RUN 2" FLEX FIBER CONDUIT FROM BOTTOM OF OVP TO SIDE OF RF CABINET WITH CHASE

5. RUN (1) 11/2" FLEX POWER CONDUIT FOR EVERY (6) RRU CIRCUITS FROM BOTTOM OF OVP TO

6. SUPPORT FLEX CONDUIT ON HORIZONTAL H-FRAME RAILS OR ON VERTICAL SITE STRUT

SIDE OF RF CABINET WITH CHASE NIPPLE THROUGH FACTORY KNOCKOUT.

SNT10 RAILS ADDED TO H-FRAME FOR CONDUIT/CABLE MANAGEMENT.

NIPPLE THROUGH FACTORY KNOCKOUT.

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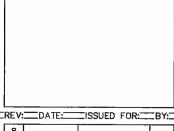
PROJECT INFORMATION:

SITE NAME: SWALLOWTAIL SITE No.: 431713 PROJECT #: N/A 452 FARM LIFE SCHOOL RD CARTHAGE, NC 28327 MOORE COUNTY

PLANS PREPARED BY:


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KHA PROJECT NUMBER:

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DRAWN BY: ____CHECKED BY:

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SHEET TITLE:

EQUIPMENT PAD LAYOUT

SHEET NUMBER:

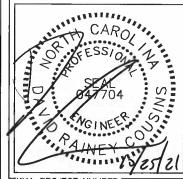C3

CABINET.

0 1.5 3

10. BOLT CABINETS AND GENERATOR TO SLAB USING FASTENERS SPECIFIED BY EQUIPMENT
MANUFACTURER IN FACTORY PROVIDED MOUNTING HOLES.


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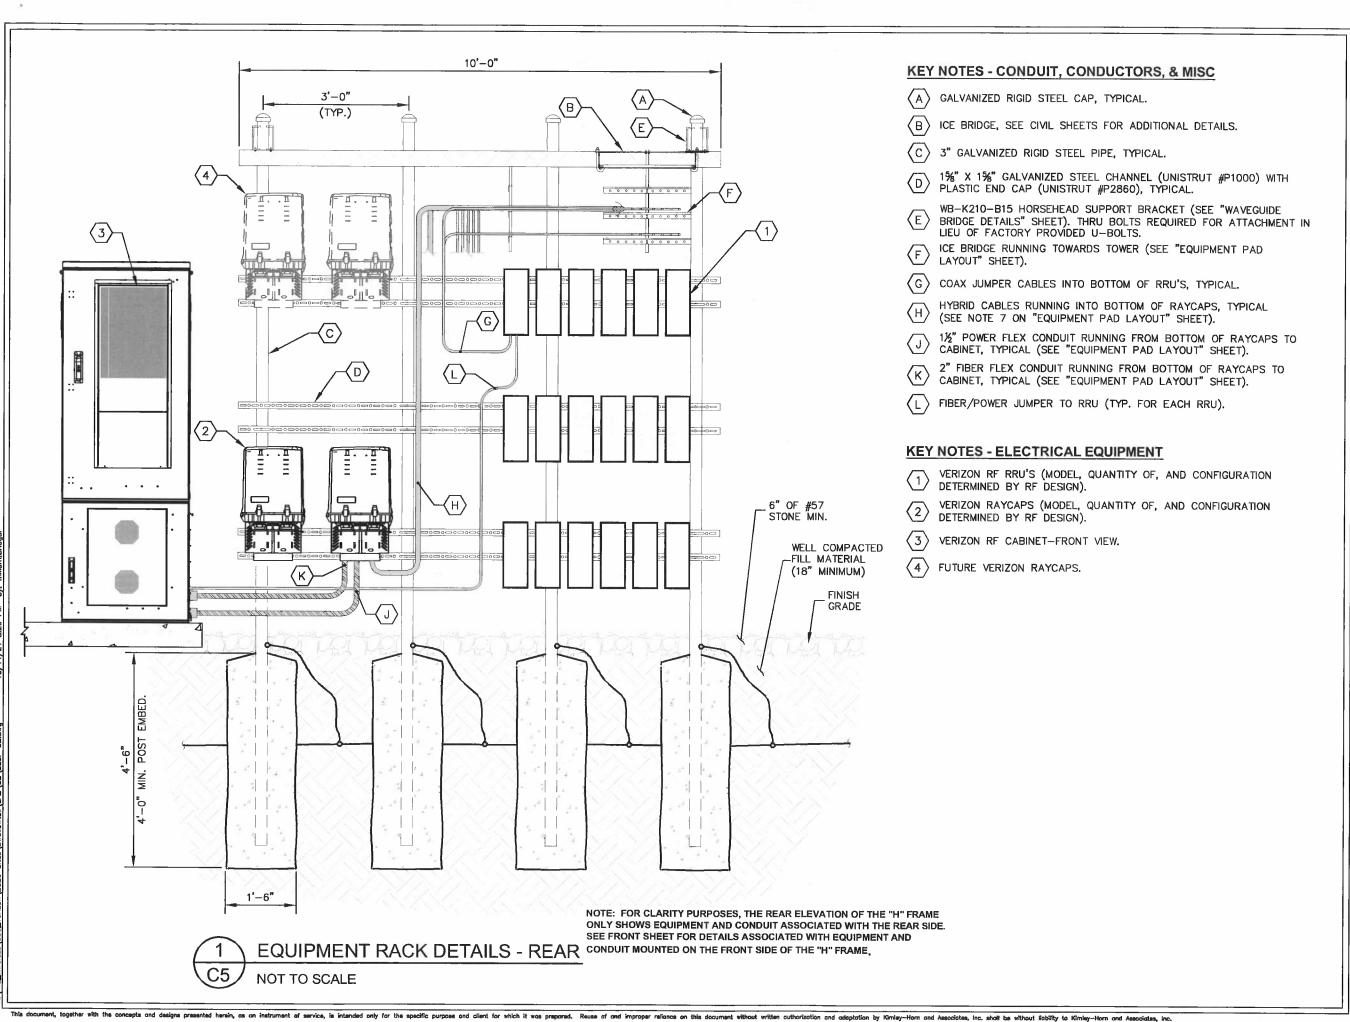
GRAPHIC SCALE: 1" = 3'

TOWER SIDE OF LAST ICE BRIDGE POST AND BOND TO TDSGA GROUND BAR NEAR TOP OF

PIPE, USING COMMSCOPE GPS-U MOUNTING KIT. MOUNT AS NEAR AS PRACTICAL TO RBA84

9. GPS ANTENNA TO BE MOUNTED TO STANDARD HEIGHT POST WITH EXTENDED MOUNTING



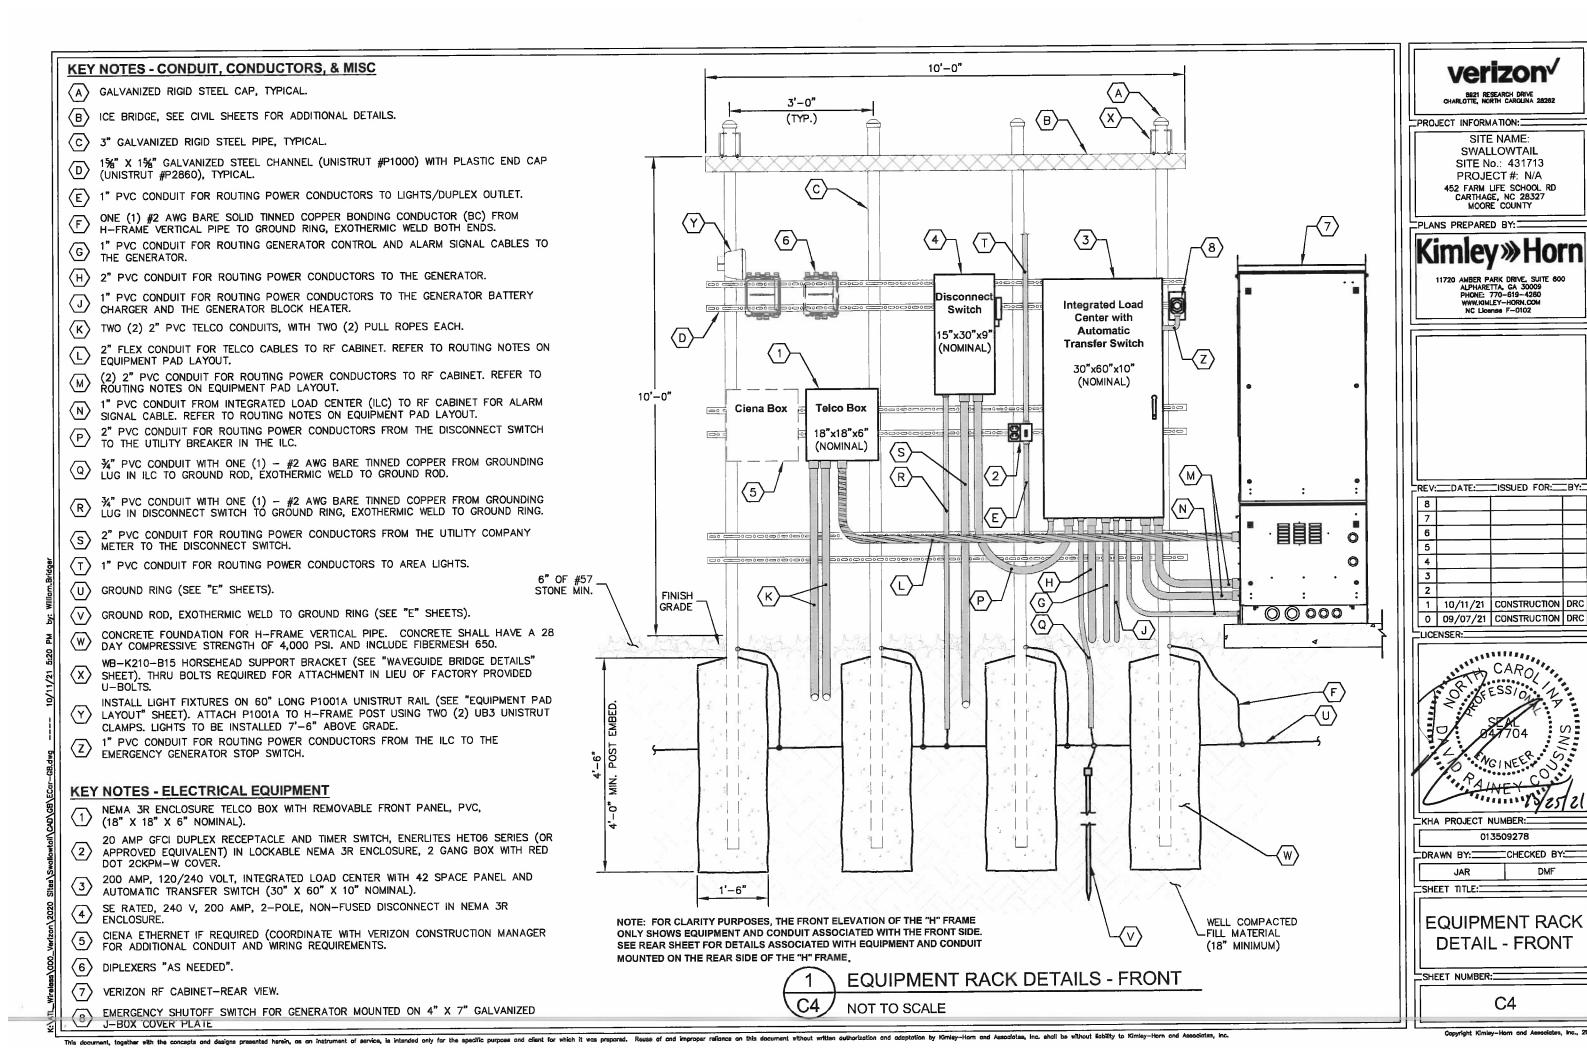

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PROJECT INFORMATION:

SITE NAME:
SWALLOWTAIL
SITE No.: 431713
PROJECT #: N/A
452 FARM LIFE SCHOOL RD
CARTHAGE, NC 28327
MOORE COUNTY


PLANS PREPARED BY:

Kimley »Horr

11720 AMBER PARK DRIVE, SUITE 600 ALPHARETTA, GA 30009 PHONE: 770-619-4280 WWW.MMLEY-HORN.COM NC License F-0102

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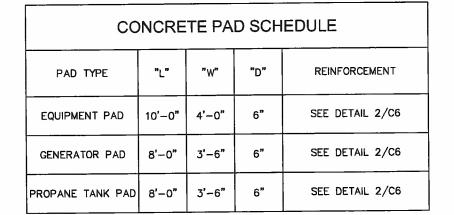
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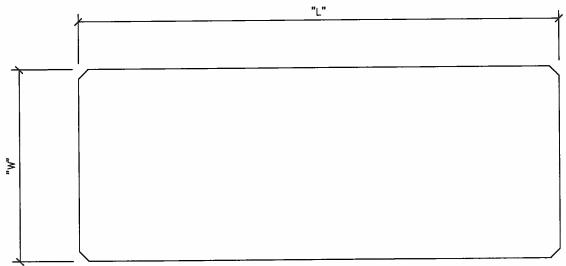
EQUIPMENT RACK DETAIL - REAR

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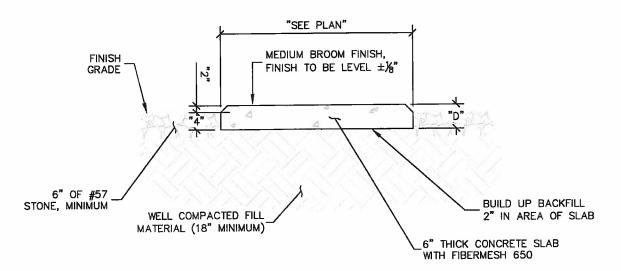
C5
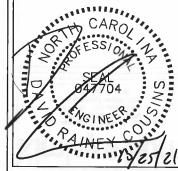
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1 CONCRETE PAD PLAN
C6 NOT TO SCALE



2 CONCRETE PAD FOUNDATION SECTION

C6 NOT TO SCALE

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8921 RESEARCH DRIVE IARLOTTE, NORTH CAROLINA 282

PROJECT INFORMATION:

SITE NAME: SWALLOWTAIL SITE No.: 431713 PROJECT #: N/A 452 FARM LIFE SCHOOL RD CARTHAGE, NC 28327 MOORE COUNTY


PLANS PREPARED BY:

Kimley WHorr

11720 AMBER PARK DRIVE, SUITE 600 ALPHARETTA, GA 30009 PHONE: 770-619-4280 WWW.KMLEY-HORN.COM NC LICENSE F-0102

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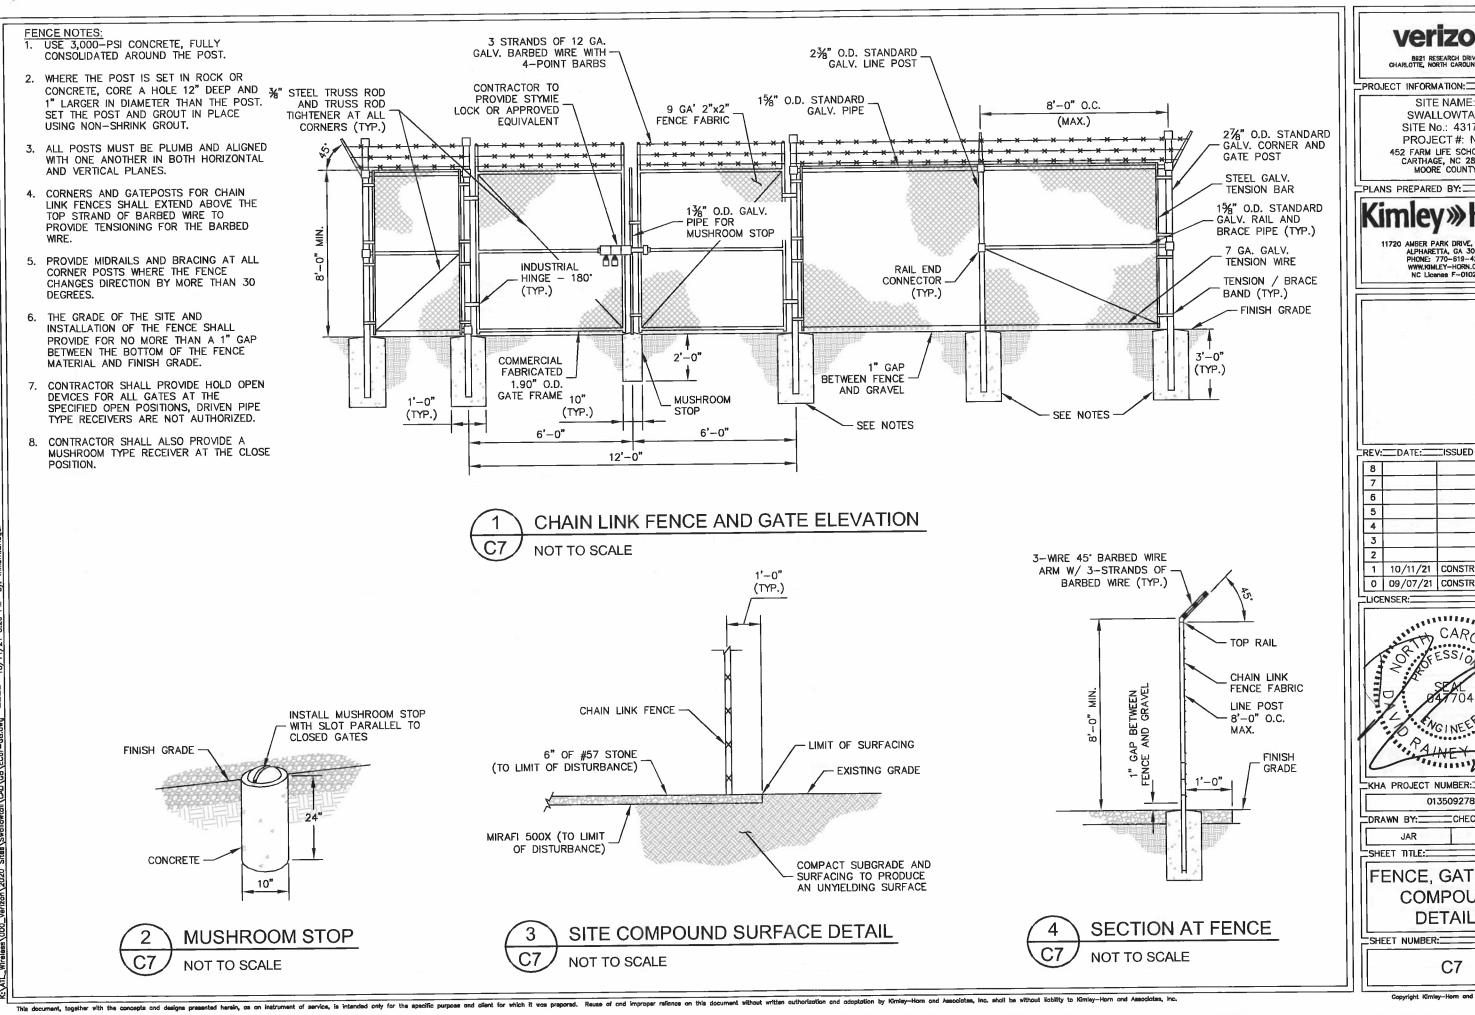
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FOUNDATION DETAILS

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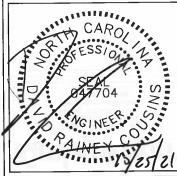
8921 RESEARCH DRIVE CHARLOTTE, NORTH CAROLINA 28262

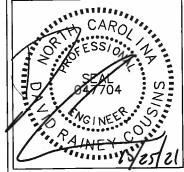SWALLOWTAIL SITE No.: 431713 PROJECT #: N/A 452 FARM LIFE SCHOOL RD CARTHAGE, NC 28327 MOORE COUNTY

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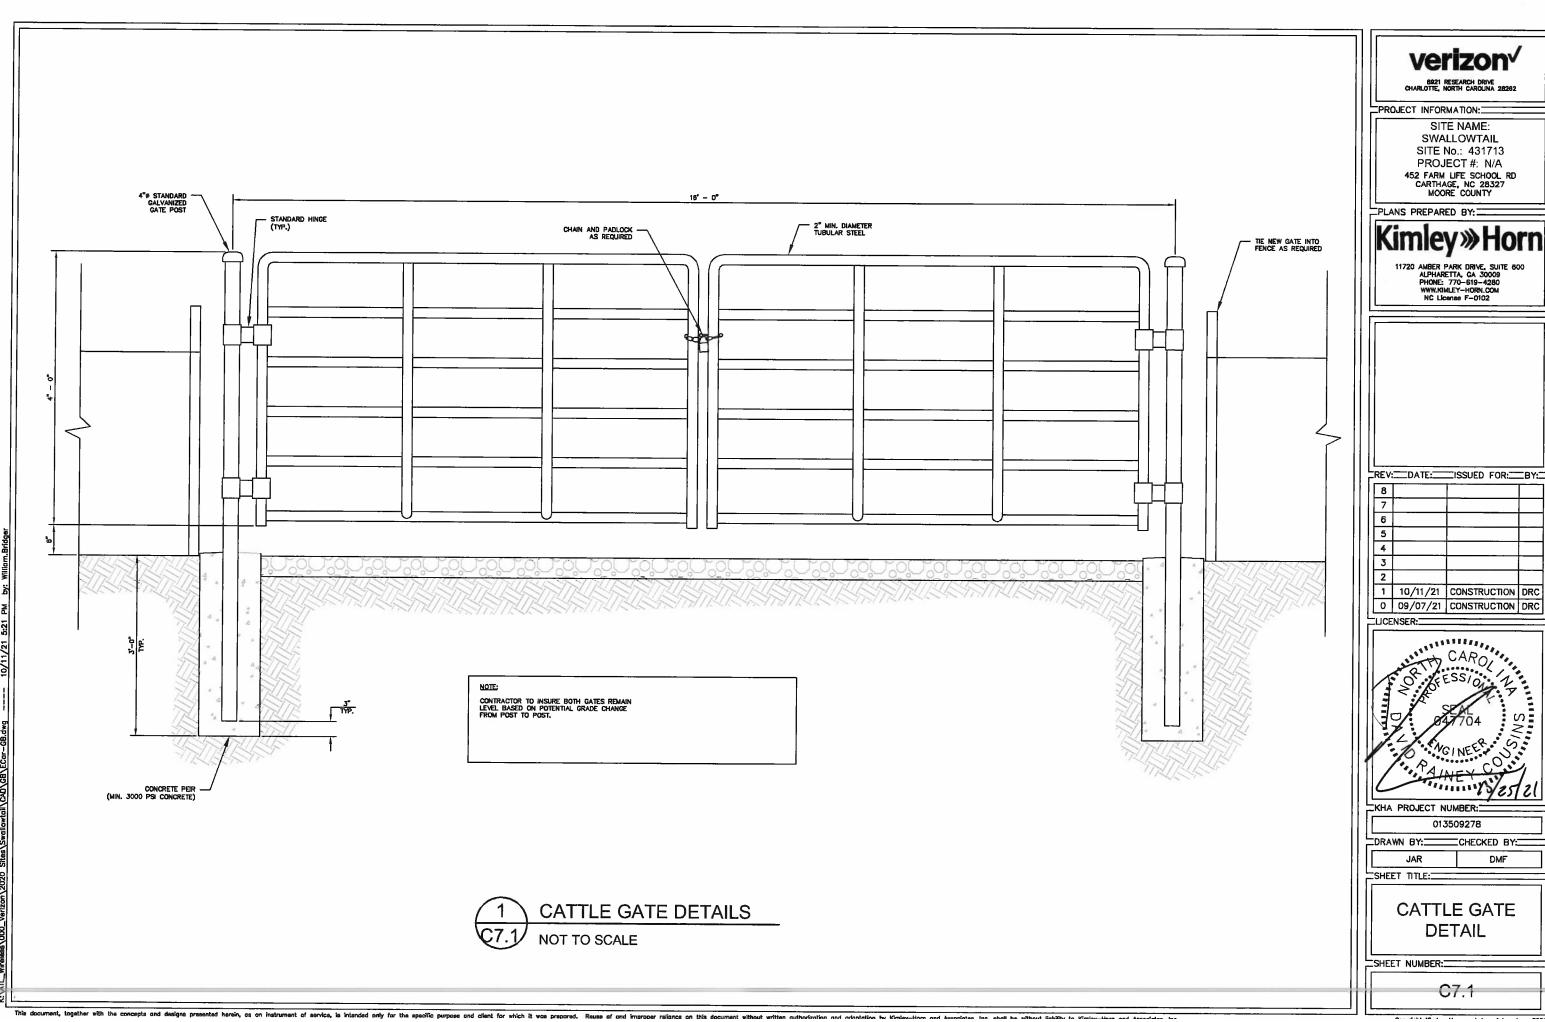
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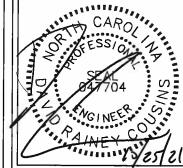
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FENCE, GATE, AND COMPOUND **DETAILS**



SITE No.: 431713

REV: DATE: ISSUED FOR: BY:





DMF

NOTE:
CURRENT DESIGN ANTICIPATES
APPROXIMATELY 7,186± SQ. FT. (.16
ACRES) OF CLEARING AND GRADING FOR
THE PROPOSED PROJECT. IF ADDITIONAL
CLEARING IS REQUIRED BEYOND WHAT IS
SHOWN IN THE PLANS THE CONTRACTOR
SHALL NOTIFY THE ENGINEER AND/OR
PROJECT MANAGER. IF DURING THE BID
WALK OR CONSTRUCTION IT IS
DETERMINED THAT MORE THAN (1) ACRE
OF LAND IS TO BE DISTURBED FOR
CONSTRUCTION AN EROSION AND
SEDIMENTATION CONTROL PLAN MUST BE
FILED 30 DAYS PRIOR TO
CONSTRUCTION.

GRADING NOTES:

- THE CONTRACTOR SHALL CLEAR AND GRUB THE SITE AND PLACE, COMPACT, AND MOISTURE CONDITION ALL FILL PER THE PROJECT GEOTECHNICAL ENGINEERS SPECIFICATIONS. FILL MATERIAL SHALL BE APPROVED BY THE GEOTECHNICAL ENGINEER PRIOR TO PLACEMENT.
- ALL PROPOSED CONTOURS AND SPOT ELEVATIONS REFLECT FINISHED GRADES.
- 3. CONTRACTOR SHALL BLEND EARTHWORK SMOOTHLY TO TRANSITION BACK TO EXISTING GRADE.
- 4. PORTIONS OF THE SITE NOT SPECIFICALLY MENTIONED WITHIN THE GEOTECHNICAL REPORT SHALL BE COMPACTED TO 95 PERCENT OF THE MATERIALS MAXIMUM DRY DENSITY WITHIN 3 PERCENT OF OPTIMUM MOISTURE CONTENT.
- 5. FILL SHALL BE PLACED IN MAXIMUM 8 INCH LOOSE LIFTS.
- 6. UNDISTURBED AREAS WITHIN 30' INGRESS/EGRESS EASEMENT NOT NEEDED FOR UTILITY ROUTING TO BE LEFT UNDISTURBED.
- 7. GROUND WATER SHOULD BE REASONABLY EXPECTED. ANY DE-WATERING OR MOISTURE CONDITIONING IS THE RESPONSIBILITY OF THE CONTRACTOR AND SHOULD BE INCLUDED IN THE CONTRACT PRICE.
- 8. SEED ALL DISTURBED AREAS NOT TOPPED WITH GRAVEL PER SEEDING SCHEDULE ON DETAIL ON SHEET C9.
- MAXIMUM CUT SLOPE = 2H:1V UNLESS OTHERWISE NOTED.
- 10. MAXIMUM FILL SLOPE = 3H:1V UNLESS OTHERWISE NOTED.

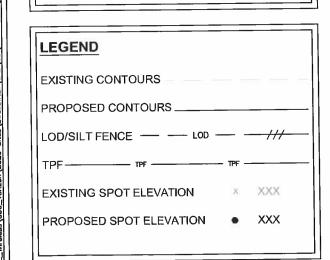

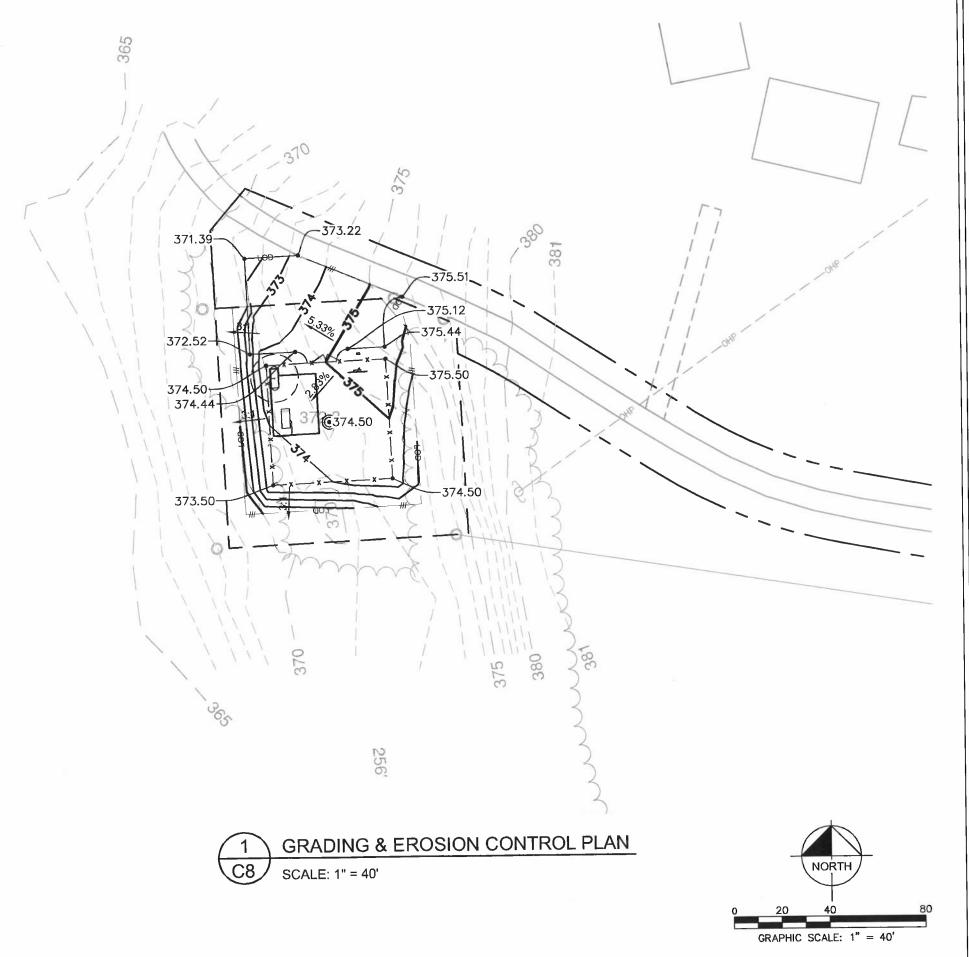

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PROJECT INFORMATION:


SITE NAME:
SWALLOWTAIL
SITE No.: 431713
PROJECT #: N/A
452 FARM LIFE SCHOOL RD
CARTHAGE, NC 28327
MOORE COUNTY

PLANS PREPARED BY:

Kimley»Horr

11720 AMBER PARK DRIVE, SUITE 600 ALPHARETTA, GA 30009 PHONE: 770-619-4280 WWW.KIMLEY-HORN.COM NC License F-0102

LICENSER:

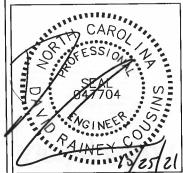

KHA PROJECT NUMBER:

013509278

DRAWN BY: ____CHECKED BY:_

SHEET TITLE:

GRADING AND EROSION CONTROL PLAN

SHEET NUMBER:

EROSION CONTROL NOTES:

- EROSION CONTROLS SHALL BE INSTALLED PRIOR TO CONSTRUCTION AND SHALL BE ADEQUATE TO MAINTAIN SEDIMENT ON SITE.
- 2. ALL EXCAVATED SOILS NOT NEEDED ON SITE FOR BACKFILL OPERATIONS SHALL BECOME PROPERTY OF THE CONTRACTOR AND SHALL BE TAKEN OFF SITE AND LEGALLY DISPOSED OF.
- 3. SOIL REMAINING ON SITE SHALL HAVE SILT FENCE TIGHTLY PLACED AROUND THE ENTIRE CIRCUMFERENCE OF THE PILE.
- 4. PROVIDE EROSION CONTROLS AS NECESSARY TO PREVENT EXISTING SOILS FROM DRAINING OFF SITE OR INTO EXISTING DRAINAGE STRUCTURES.
- ERECTION OF EROSION CONTROLS SHALL BE IN ACCORDANCE WITH STATE AND LOCAL EROSION CONTROL REGULATIONS.

SEEDING SCHEDULE FOR WINTER / SPRING CONSTRUCTION ACTIVITIES

SEEDING MIXTURE

Species Rate (Ib/acre)
Rye (grain) 120
Annual lespedeza (Kobe in
Pledmont and Coastal Plain,
Korean in Mountains) 50

Omit annual lespedeza when duration of temporary cover is not to extend beyond June.

SEEDING DATES

Mountains— Above 2500 ft: Feb 15 — May 15

Below 2500 ft.: Feb 15 — May 15

Piedmont—Jan. 1 — May 1

Coastal Plain—Dec. 1 — Apr. 15

SOIL AMENDMENTS

Follow recommendations of soil tests or apply 2,000 lb/acre ground agricultural limestone and 750 lb/acre 10-10-10 fertilizer.

MULCH

Apply 4,000 lb/acre straw. Anchor straw by tacking with asphalt, netting, or a mulch anchoring tool. A disk with blades set nearly straight can be used as a mulch anchoring tool.

MAINTENANCE

Refertilize if growth is not fully adequate. Reseed, refertilize and mulch immediately following erosion or other damage.

SEEDING SCHEDULE FOR SUMMER CONSTRUCTION ACTIVITIES

SEEDING MIXTURE

Species Rate (lb/acre)
Common Bermudagrass 40-80 (1-2 lb/1,000 sq. ft.)

SEEDING DATES

Coastal Plain——Apr. 1 — July Piedmont——Apr. 15 — June 30

SOIL AMENDMENTS


Apply lime and fertilizer according to soil tests, or apply 3,000 lb/acre ground agricultural limestone and 500 lb/acre 10-10-10 fertilizer.

MULCH

Use jute, excelsior matting, or other effective channel lining material to cover the bottom of channels and ditches. The lining should extend above the highest calculated depth of flow. On channel side slopes above this height, and in drainages not requiring temporary lining, apply 4,000 lb/acre grain straw and anchor straw by stapling netting over the top.


MAINTENANCE

A minimum of 3 weeks is required for establishment. Inspect and repair mulch frequently. Refertilize the following Apr. with 50 lb/acre nitrogen.

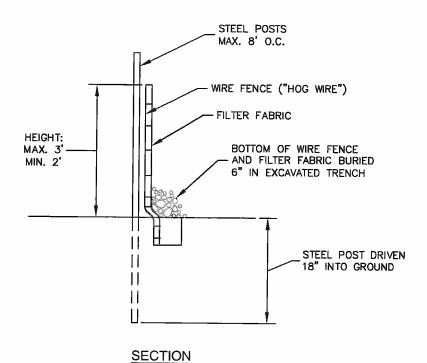

1 SEDIMENT FENCE (SILT FENCE)
NOT TO SCALE

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NOTES
INSTALL TREE PROTECTION FENCE AND SIGNAGE PRIOR TO
CALLING FOR SITE INSPECTION. MAINTAIN TREE PROTECTION
FENCE THROUGHOUT DURATION OF PROJECT. ADDITIONAL
SIGNS MAY BE REQUIRED BASED ON ACTUAL FIELD CONDITIONS.

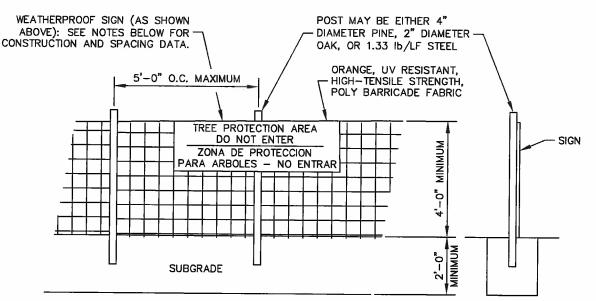

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8921 RESEARCH DRIVE CHARLOTTE, NORTH CAROLINA 28262

PROJECT INFORMATION:


SITE NAME:
SWALLOWTAIL
SITE No.: 431713
PROJECT #: N/A
452 FARM LIFE SCHOOL RD
CARTHAGE, NC 28327
MOORE COUNTY

IPLANS PREPARED BY: I

Kimley»Horn

20 AMBER PARK DRIVE, SUITE 600 ALPHARETTA, GA 30009 PHONE: 770-619-4280 WWW.IMLEY-HORN.COM NC LICENSS F-0102

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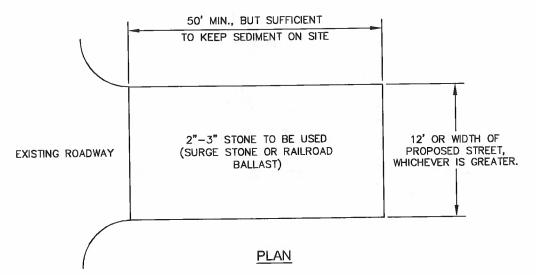
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GRADING AND EROSION CONTROL DETAILS

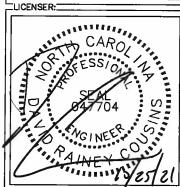SHEET NUMBER:



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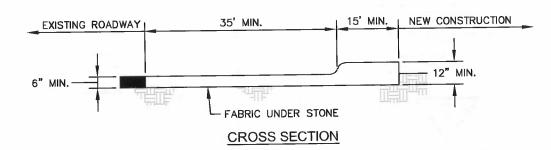
1. PUT SILT FENCE OR TREE PROTECTION FENCE UP TO ENSURE CONSTRUCTION ENTRANCE IS USED.

CONSTRUCTION ENTRANCE IS USED.

IF CONSTRUCTION ON THE SITES ARE SUCH THAT THE MUD IS NOT REMOVED BY THE VEHICLE TRAVELING OVER THE STONE, THEN THE TIRES OF THE VEHICLES MUST BE WASHED BEFORE


ENTERING THE PUBLIC ROAD.

IF A PROJECT CONTINUES TO PULL MUD AND DEBRIS ON TO THE PUBLIC ROAD, THE GOVERNING AUTHORITY WILL CLEAN THE AREA AND INVOICE THE FINANCIALLY RESPONSIBLE PERSON AS INDICATED ON THE FINANCIAL RESPONSIBILITY



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NOTE:
IF DETERMINED NECESSARY DURING GRADING AND CONSTRUCTION OF THE ACCESS ROAD BY THE VERIZON WIRELESS PROJECT MANAGER, THE CONTRACTOR SHALL INSTALL 6" BASE OF SURGE STONE OR RAILROAD BALLAST (2" TO 4" STONE TYP.)

STANDARD ACCESS ROAD AND TURN-AROUND DETAIL NOT TO SCALE

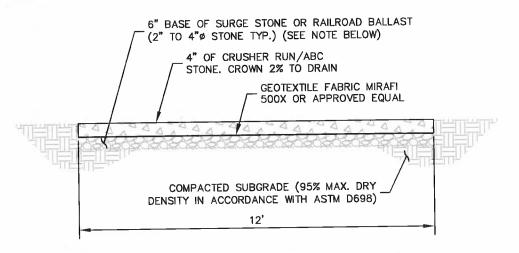

8921 RESEARCH DRIVE CHARLOTTE, NORTH CAROLINA 28262

PROJECT INFORMATION:

SITE NAME: **SWALLOWTAIL** SITE No.: 431713 PROJECT#: N/A 452 FARM LIFE SCHOOL RD CARTHAGE, NC 28327 MOORE COUNTY


PLANS PREPARED BY:

AMBER PARK DRYC, SOIT ALPHARETTA, GA 30009 PHONE: 770-619-4280 WWW.KIMLEY-HORN.COM NC License F-0102

REV: DATE: ISSUED FOR: BY:

4 3 2 1 10/11/21 CONSTRUCTION DRC 0 09/07/21 CONSTRUCTION DRC

LICENSER:

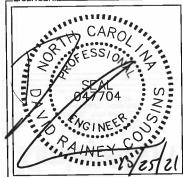

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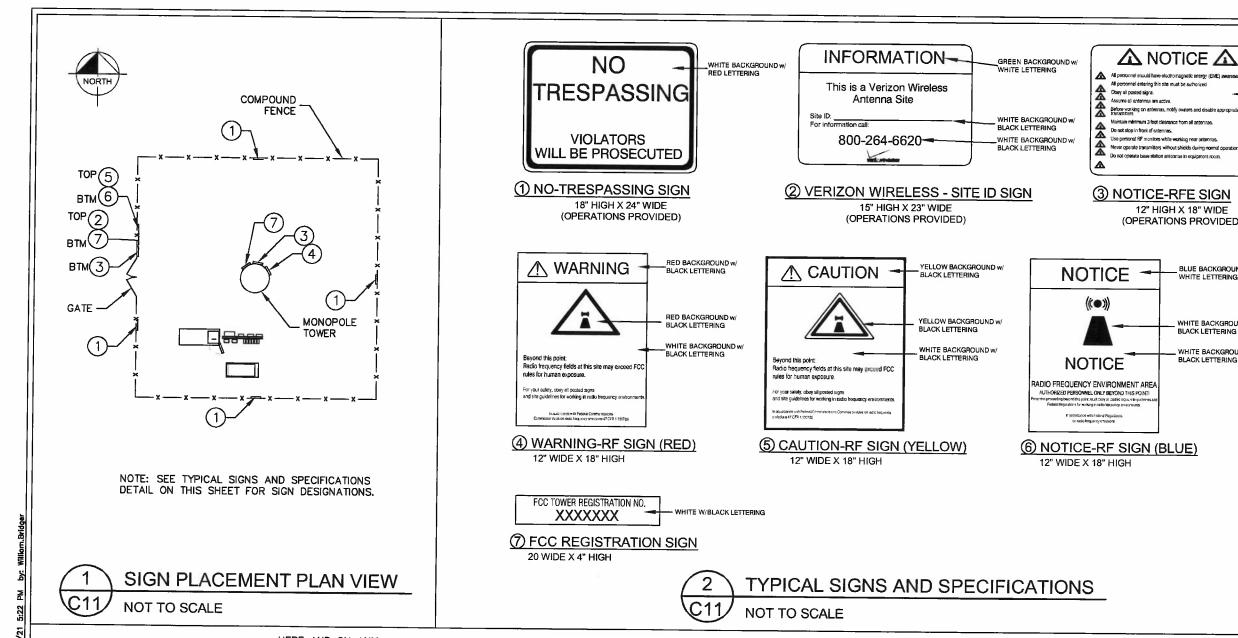
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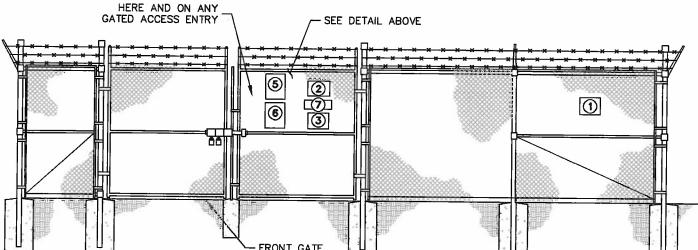
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SHEET TITLE:

ACCESS ROAD DETAILS

SHEET NUMBER:





1. SIGNS SHALL BE FABRICATED FROM CORROSION RESISTANT PRESSED METAL, AND PAINTED WITH LONG LASTING UV RESISTANT COATINGS.

 $oldsymbol{\Lambda}$ notice $oldsymbol{\Lambda}$

lever operate transmitters without shields during normal operation

12" HIGH X 18" WIDE

(OPERATIONS PROVIDED)

BLUE BACKGROUND w/ WHITE LETTERING

WHITE BACKGROUND W/

WHITE BACKGROUND w

BLACK LETTERING

 SIGNS (EXCEPT WHERE NOTED OTHERWISE) SHALL BE MOUNTED TO THE TOWER, GATE, AND FENCE USING A MINIMUM OF 9 GAUGE ALUMINUM WIRE, HOG RINGS (AS UTILIZED IN FENCE INSTALLATIONS) OR BRACKETS WHERE NECESSARY. BRACKETS SHALL BE OF SIMILAR METAL AS THE STRUCTURE TO AVOID GALVANIC CORROSION.

verizon^v

8921 RESEARCH DRIVE CHARLOTTE, NORTH CAROLINA 28262

PROJECT INFORMATION:

YELLOW BACKGROUND w/ BLACK LETTERING

SITE NAME: **SWALLOWTAIL** SITE No.: 431713 PROJECT #: N/A 452 FARM LIFE SCHOOL RD CARTHAGE, NC 28327 MOORE COUNTY

PLANS PREPARED BY:

ALPHARETTA, GA 30009 PHONE: 770-619-4280 WWW.KIMLEY-HORN.COM NC License F-0102

REV: DATE: ISSUED FOR: BY: 1 10/11/21 CONSTRUCTION DRC

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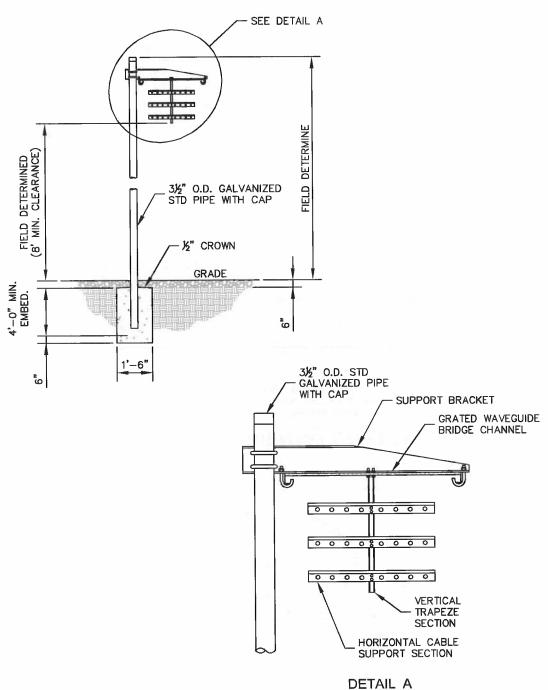
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SITE SIGNAGE **DETAILS**

SHEET NUMBER:

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FRONT GATE SIGN PLACEMENT FRONT GATE VIEW NOT TO SCALE




ANDREW 1 POST WAVEGUIDE BRIDGE KIT (PART #: WB-K210-B15, OR APPROVED EQUIVALENT)

NOTE:

1. ALL MATERIALS FURNISHED BY CONTRACTOR UNLESS OTHERWISE NOTED.

> WAVEGUIDE BRIDGE DETAIL NOT TO SCALE

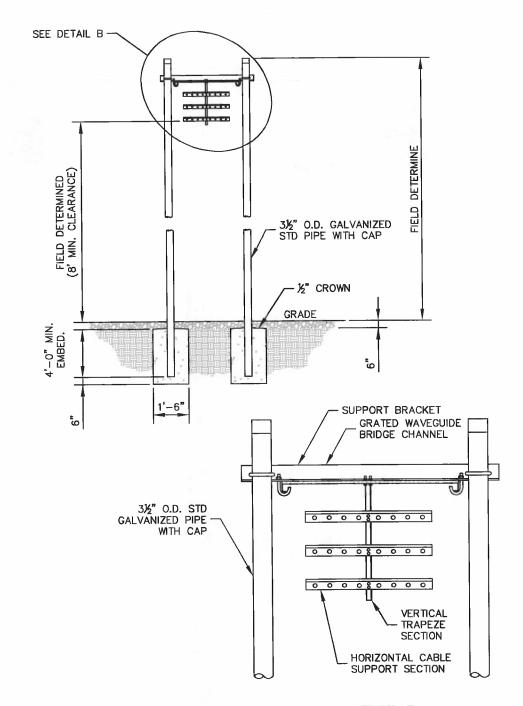

NOTE:

1. ALL MATERIALS FURNISHED BY CONTRACTOR UNLESS OTHERWISE NOTED.

DETAIL B

ANDREW 2 POST WAVEGUIDE BRIDGE KIT (PART #: WB-K410-B15, OR APPROVED EQUIVALENT)



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WAVEGUIDE BRIDGE DETAIL (ALT DESIGN - 2 PIPE COLUMNS)

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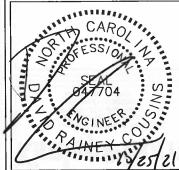
PROJECT INFORMATION:

SITE NAME: SWALLOWTAIL SITE No.: 431713 PROJECT#: N/A 452 FARM LIFE SCHOOL RD CARTHAGE, NC 28327 MOORE COUNTY

PLANS PREPARED BY:

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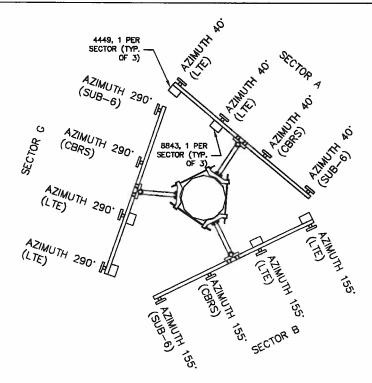
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SHEET TITLE:

WAVEGUIDE **BRIDGE DETAILS**

SHEET NUMBER:







ANTENNA ORIENTATION PLAN

(NOT TO SCALE, FOR ILLUSTRATIVE PURPOSES ONLY, SEE STRUCTURAL ANALYSIS BY OTHERS TO CONFIRM ANTENNA MOUNT TYPE)

NOTE:

REFER TO RFDS PROVIDED BY VERIZON.
CONTRACTOR TO CONTACT THE VERIZON WIRELESS
CONSTRUCTION MANAGER PRIOR TO CONSTRUCTION
FOR THE CONSTRUCTION RFDS.


OTES:

1. ALL INFORMATION ON THIS PAGE IS PROVIDED BY VERIZON WIRELESS AND/OR OTHERS AND IS SHOWN FOR ILLUSTRATIVE PURPOSES ONLY. CONTRACTOR SHALL CONTACT THE VERIZON WIRELESS CONSTRUCTION MANAGER PRIOR TO CONSTRUCTION FOR ALL DETAILED ANTENNA, AND COAX CABLE INFORMATION.

2. REFER TO STRUCTURAL ANALYSIS BY TOWER OWNER FOR ANALYSIS OF PROPOSED TOWER.

3. IT IS UNDERSTOOD THAT KIMLEY—HORN MAKES NO WARRANTY, EITHER EXPRESSED OR IMPLIED, FINDINGS, DESIGNS, RECOMMENDATIONS, SPECIFICATIONS, OPINION, OR PROFESSIONAL ADVICE RELATING TO THE STRUCTURAL ADEQUACY OF THE PROPOSED TOWER OR ATTACHMENT OF ANTENNAS OR OTHER APPURTENANCES.

NOTE: GENERAL CONTRACTOR TO INSTALL RAYCAP OVP, NUMBER AND TYPE PER VERIZON CONSTRUCTION MANAGER.

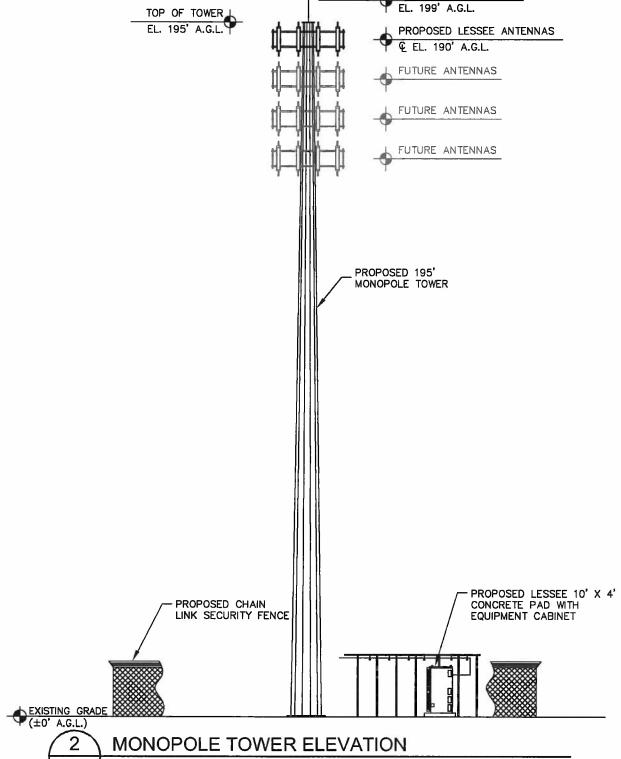

TOP OF LIGHTNING ROD

NOT TO SCALE

NOTES:

- 1. ALL PROPOSED ATTACHMENTS TO TOWER BASED ON TOWER DESIGN DRAWINGS BY OTHERS (SEE GENERAL NOTE 1.07, SHEET N1).
- 2. THE TOWER ELEVATION SHOWN IS FOR REFERENCE ONLY.
- COAX/FIBER CABLE LENGTHS ARE APPROXIMATE. CONTRACTOR TO VERIFY CORRECT LENGTH IN FIELD AT TIME OF CONSTRUCTION.
- 4. PROPOSED TOWER WILL BE GALVANIZED STEEL-GRAY IN COLOR.

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8921 RESEARCH DRIVE CHARLOTTE, NORTH CAROLINA 28262

PROJECT INFORMATION:

SITE NAME: SWALLOWTAIL SITE No.: 431713 PROJECT #: N/A 452 FARM LIFE SCHOOL RD CARTHAGE, NC 28327 MOORE COUNTY

PLANS PREPARED BY:

Kimley » Horr

11720 AMBER PARK DRIVE, SUITE 600 ALPHARETTA, GA 30009 PHONE: 770-619-4280 WWW.MMLEY-HORN.COM NC License F-0102

0 D9/07/21 CONSTRUCTION DRC

LICENSER:

FOR ILLUSTRATIVE
PURPOSES ONLYNO SIGNATURE
REQUIRED

KHA PROJECT NUMBER:

013509278

DRAWN BY: CHECKED BY:

SHEET TITLE:

ANTENNA AND TOWER ELEVATION DETAILS

SHEET NUMBER:

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KEY NOTES - CONDUIT, CONDUCTORS, & MISC

- 1" SCHEDULE 40 STEEL PIPE. PIPE MATERIAL TO COMPLY WITH SECTION 403.4.2 OF THE 2018 NORTH CAROLINA FUEL GAS CODE. PIPE SIZED FOR AN INLET PRESSURE OF 11" IN W.C.I AND A MAXIMUM LENGTH OF 50 LF.
- B 1" POLYETHYLENE PIPE WITH A TRACER WIRE. PIPE MATERIAL TO COMPLY SECTION 403.6 OF THE 2018 NORTH CAROLINA FUEL GAS CODE. PIPE SIZED FOR INLET PRESSURE OF 11" IN W.C. AND MAXIMUM LENGTH OF 50 LF. TRACER WIRE SHALL COMPLY WITH SECTION 404.17.3 OF 2018 NORTH CAROLINA FUEL GAS CODE.
- (C) 4" SCHEDULE 80 PVC SLEEVE.
- (D) CONNECTIONS TO BE MADE WITH FLEXIBLE FITTINGS.

KEY NOTES - EQUIPMENT


- LIQUID PROPANE TANK <u>WITH AN INTEGRAL MANUAL</u>

 SHUTOFF VALVE, SIZE AND TYPE PER VERIZON WIRELESS.

 TANK SHALL COMPLY WITH ALL REQUIREMENTS OF THE NFPA AND INTERNATIONAL FUEL GAS CODE.
- $\overline{2}$ FIRST STAGE REGULATOR PER NFPA 58 SECTION 6.8.1.1.
- (3) 4" PVC CAP.
- PROPOSED VALVE, DRIP LEG, SECOND STAGE REGULATOR,
 AND FLEXIBLE CONNECTORS. ALL MATERIALS SHALL BE
 INSTALLED PER THE 2018 NORTH CAROLINA FUEL GAS CODE.
- 5 PROPOSED LP GENERATOR.

ADDITIONAL NOTES

- 1. UPON COMPLETION OF ASSEMBLY, PIPING SYSTEMS (INCLUDING HOSE) SHALL BE TESTED AND PROVED FREE OF LEAKS IN ACCORDANCE WITH SECTION 406 OF THE 2018 NORTH CAROLINA FUEL GAS CODE.
- 2. GENERATOR SUPPLY LINE UPSTREAM OF SECOND STAGE REGULATOR SIZED FOR 632 THOUSAND BTU AT 30 FEET MAXIMUM PIPING LENGTH. LINES SIZED PER TABLES 402.4(28) AND 402.4(35) OF THE 2018 NORTH CAROLINA FUEL GAS CODE. IF THE INSTALLATION OF THE SERVICE LINE CANNOT BE MADE WITHIN 30 FEET, THE CONTRACTOR SHALL CONTACT THE ENGINEER PRIOR TO ORDERING MATERIALS TO RECEIVE DIRECTION.
- 3. COORDINATE ALL ROUTING WITH OTHER TRADES SHOWN ON CIVIL AND ELECTRICAL DRAWINGS.
- 4. MINIMUM SEPARATION BETWEEN POINT OF DISCHARGE OF CONTAINER PRESSURE RELIEF VALVE, VENT OF A FIXED MAXIMUM LIQUID LEVEL GAUGE ON A CONTAINER, AND THE CONTAINER FILLING CONNECTION TO EXTERIOR SOURCES SHALL BE NO LESS THAN FIVE FEET TO ANY SPARK SOURCE. NOTE THAT THIS SEPARATION IS DETERMINED BY SECTION 6.26.3 OF THE NFPA AND IS ONLY VALID IF A MANUAL SHUT OFF VALVE IS INSTALLED.

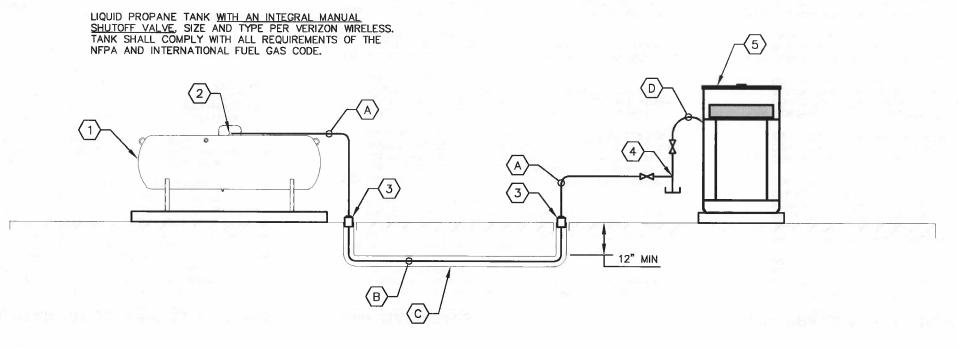

MECHANICAL PLAN AND NOTES

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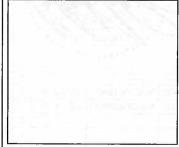
SITE NAME:
SWALLOWTAIL
SITE No.: 431713
PROJECT #: N/A
452 FARM LIFE SCHOOL RD
CARTHAGE, NC 28327
MOORE COUNTY

PLANS PREPARED BY:

PROJECT INFORMATION:

Kimley »Horn

11720 AMBER PARK DRIVE, SUITE 600 ALPHARETTA, GA 30009 PHONE: 770-619-4280 WWW.IGIMLEY-HORN.COM NC License F-0102



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SHEET TITLE:

MECHANICAL PLAN & NOTES

SHEET NUMBER:

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ELECTRICAL NOTES

1.00 CODES, STANDARDS, & SPECIFICATIONS

- 1.01 IT IS THE CONTRACTOR'S RESPONSIBILITY TO ENSURE THAT ALL MATERIALS AND LABOR RELATED DIRECTLY OR INDIRECTLY TO ALL ELECTRICAL WORK DOCUMENTED IN THESE DRAWINGS SHALL BE PROVIDED AND PERFORMED IN CONFORMANCE WITH ALL CURRENT GOVERNING CODES, STANDARDS, AND PROFESSIONAL STANDARD OF CARE TO INCLUDE THE AMERICAN SOCIETY FOR TESTING AND MATERIALS (ASTM), UNDERWRITERS LABORATORY (UL), NATIONAL ELECTRICAL MANUFACTURERS ASSOCIATION (NEMA), AMERICAN STANDARDS ASSOCIATION (ASA), NATIONAL FIRE PROTECTION ASSOCIATION (NFPA), AND THE NATIONAL ELECTRICAL CODE (NEC).
- 1.02 MATERIALS SHALL BE NEW AND SHALL CONFORM TO ALL APPLICABLE CURRENT GOVERNING STANDARDS ESTABLISHED FOR EACH ITEM BY ASTM, UL, NEMA, ASA, AND NFPA.
- 1.03 ALL ELECTRICAL WORK SHALL COMPLY WITH ALL APPLICABLE STATE, COUNTY, AND MUNICIPAL CODES AND ORDINANCES, AS WELL AS ALL CURRENT GOVERNING STANDARDS AND PRACTICES AS REQUIRED BY NEC, NEMA, ANSI, NFPA, UBC, UL, IEEE, AND THE LOCAL UTILITY COMPANY.
- 1.04 ALL ELECTRICAL GROUNDING SHALL COMPLY WITH THE CURRENT EDITION OF THE NEC.
- 1.05 CONTRACTOR SHALL MAINTAIN UL LISTED FIRE RATINGS AT ALL WALL PENETRATIONS.
- 1.06 CONTRACTOR SHALL MAINTAIN A MINIMUM CLEARANCE OF 36" IN FRONT OF ALL ELECTRICAL EQUIPMENT AS REQUIRED BY NEC. MINIMUM CLEARANCE SHALL BE OBSERVED FOR BOTH THE FRONT AND THE REAR OF THE METER H-FRAME RACK AND THE EQUIPMENT H-FRAME RACK.

2.00 GENERAL

- 2.01 CONTRACTOR SHALL BE RESPONSIBLE FOR ALL PERMITS AND ASSOCIATED FEES RELATED TO THE PROJECT AND SHALL DELIVER A COPY OF ALL PERMITS TO THE VERIZON REPRESENTATIVE.
- 2.02 CONTRACTOR SHALL SCHEDULE AND SHOULD ATTEND ALL INSPECTIONS REQUIRED BY THE JURISDICTION HAVING AUTHORITY.
- 2.03 CONTRACTOR SHALL FURNISH ALL LABOR, MATERIALS, TOOLS, ACCESSORIES, ETC., FOR A COMPLETE WORKING ELECTRICAL INSTALLATION
- 2.04 ALL WORK SHALL BE PERFORMED IN STRICT ACCORDANCE WITH APPLICABLE BUILDING CODES AND LOCAL ORDINANCES, INSTALLED IN A NEAT MANNER, AND SHALL BE SUBJECT TO APPROVAL BY THE ENGINEER.
- 2.05 CONTRACTOR SHALL PROTECT ADJACENT EQUIPMENT AND FINISHES FROM DAMAGE AND SHALL REPAIR TO ORIGINAL CONDITION ANY ITEMS DAMAGED AS A RESULT OF THE WORK.
- 2.06 CONTRACTOR SHALL REPAIR ANY LANDSCAPING DISTURBED DURING CONSTRUCTION.
- 2.07 IF CONDUIT RUNS HAVE MORE THAN THREE (3) CONSECUTIVE 90 DEGREE TURNS, THE CONTRACTOR SHALL INSTALL PULL BOXES AS REQUIRED BY NEC.
- 2.08 CONTRACTOR SHALL INDICATE THE LOCATION OF ALL CAPPED UNDERGROUND SPARE CONDUIT ON THE RECORD DRAWINGS SUBMITTED TO THE OWNER.
- 2.09 CONTRACTOR SHALL COORDINATE EXACT ROUTING OF CONDUIT WITH OWNER. ALL CONDUIT SHALL BE ROUTED WITHIN 3 FEET, EITHER SIDE, OF PERIMETER FENCING.

3.00 MATERIALS

- 3.01 ALL EQUIPMENT AND MATERIALS SHOWN SHALL BE CONSIDERED NEW UNLESS SPECIFICALLY NOTED OTHERWISE ON THE DRAWINGS.
- 3.02 FINAL CONNECTIONS OF EQUIPMENT SHALL BE PER MANUFACTURER'S APPROVED WIRING DIAGRAMS, DETAILS, AND INSTRUCTIONS. THE ELECTRICAL CONTRACTOR SHALL PROVIDE MATERIALS AND EQUIPMENT COMPATIBLE WITH EQUIPMENT SUPPLIED BY VERIZON.
- 3.03 CONTRACTOR SHALL PROVIDE AN UPDATED PANELBOARD DIRECTORY FOR THE PANEL FROM WHICH THE NEW VERIZON EQUIPMENT CIRCUIT WILL BE CONNECTED. CONTRACTOR SHALL SUBMIT UPDATED DIRECTORY IN A PLASTIC COVER TO THE BUILDING OWNER FOR APPROVAL PRIOR TO INSTALLATION.
- 3.04 CONTRACTOR SHALL FIELD DETERMINE ACTUAL CONDUIT ROUTING AND SHALL OBTAIN APPROVAL FROM THE TOWER OWNER OF THE PROPOSED ROUTING PRIOR TO CONDUIT INSTALLATION
- 3.05 ALL CONDUCTORS SHALL BE COPPER WITH THWN INSULATION AND ALL TERMINATIONS SHALL BE RATED FOR AT LEAST 75 DEGREES CELSIUS.
- 3.06 ALL NEUTRAL CONDUCTORS SHALL HAVE WHITE INSULATION. ALL GROUND CONDUCTORS SHALL HAVE GREEN INSULATION. COLOR TAPE IDENTIFICATION OF THESE CONDUCTORS IS NOT PERMITTED.
- 3.07 CONTRACTOR SHALL SEAL ALL CONDUITS ENTERING AN ENCLOSURE WITH CONDUIT SEALANT THAT IS COMPATIBLE WITH THE INSULATION OF THE CONDUCTORS IN THE CONDUIT.
- 3.08 CONDUIT RUNS SHALL HAVE A CONTINUOUS DOWNWARD SLOPE AWAY FROM ALL EQUIPMENT TO PREVENT WATER INFII TRATION.
- 3.09 ALL CONDUIT SHALL BE SCHEDULE 40 PVC UNLESS NOTED OTHERWISE ON THE PLANS. WHEN CONDUIT IS ROUTED UNDER A ROADWAY, SCHEDULE 80 PVC CONDUIT SHALL BE UTILIZED. MANUFACTURED BEND RADII SHALL BE PER NEC.
- 3.10 CONTRACTOR SHALL PROVIDE TWO (2) 200 POUND TEST POLYETHYLENE PULL CORDS IN ALL CONDUITS AND ALL INNERDUCTS. PULL CORDS SHALL BE SECURED AT EACH END OF CONDUIT RUNS. ALL SPARE CONDUIT ENDS SHALL BE CAPPED WITH MANUFACTURED PVC FITTINGS.
- 3.11 CONTRACTOR SHALL BOND EACH METALLIC CONDUIT ENTERING A METALLIC ENCLOSURE WITH A #8 MIN AWG INSULATED COPPER BONDING JUMPER PER NEC. CONTRACTOR SHALL BOND ALL ELECTRICAL EQUIPMENT TO THE H-FRAME RACK ON WHICH EQUIPMENT IS MOUNTED WITH #8 MIN AWG INSULATED COPPER BONDING JUMPERS PER NEC.
- 3.12 CONTRACTOR SHALL IDENTIFY THE END OF ALL SPARE UNDERGROUND CONDUITS AND PROVIDE AND INSTALL 90 DEGREE ELBOWS WITH VERTICAL CONDUIT EXTENSIONS TO EXTEND 3" ABOVE FINISHED CRUSHED AGGREGATE GRADE. CONTRACTOR SHALL TERMINATE CONDUITS WITH MANUFACTURED CONDUIT CAPS THAT THE CONTRACTOR HAS PAINTED ORANGE.
- 3.13 CONTRACTOR SHALL PROVIDE AND INSTALL AN ENGRAVED PHENOLIC PLATE ON THE FRONT OF THE INTEGRATED LOAD CENTER. THE WORDING ON THE PLATE SHALL READ AS FOLLOWS: "MAXIMUM DRAW OF ALL RECTIFIERS AND EQUIPMENT ON THE LOAD CENTER CANNOT EXCEED 50kW. IF ADDITIONAL POWER IS REQUIRED, THE EXISTING 50kW GENERATOR MUST BE REPLACED."

4.00 PRE-CONSTRUCTION COORDINATION

- 4.01 CONTRACTOR SHALL VISIT THE SITE PRIOR TO BID AND NOTE EXISTING CONDITIONS THAT MIGHT AFFECT THEIR WORK. ALL SUCH CONDITIONS SHALL BE REPORTED TO THE ENGINEER PRIOR TO BID
- 4.02 THE CONTRACTOR SHALL PROVIDE A UTILITY LOCATOR AND SHALL VERIFY THE ACTUAL LOCATION OF ALL UTILITIES PRIOR TO CONSTRUCTION. THE CONTRACTOR SHALL BE RESPONSIBLE FOR PROTECTING ALL EXISTING UTILITIES. ANY DAMAGE TO EXISTING UTILITIES SHALL BE REPAIRED AT THE CONTRACTOR'S EXPENSE.
- 4.03 CONTRACTOR SHALL VERIFY, PRIOR TO ROUGH-IN, THAT SITE CONDITIONS ALLOW FOR THE PLACEMENT OF THE ELECTRICAL EQUIPMENT AS SHOWN ON THE PLANS.
- 4.04 CONTRACTOR SHALL COORDINATE WITH LOCAL ELECTRICAL UTILITY REGARDING THE EXACT LOCATION OF THE TRANSFORMER, ALL METERING REQUIREMENTS, AND CONDUIT ROUTING BETWEEN TRANSFORMER AND METER.
- 4.05 CONTRACTOR SHALL COORDINATE WITH LOCAL TELCO UTILITY REGARDING THE EXACT LOCATION OF THE TELCO SERVICE ENTRY POINT.
- 4.06 CONTRACTOR SHALL COORDINATE WITH AUTHORITY HAVING JURISDICTION REGARDING LOCAL FROST LINE REQUIREMENTS FOR RACEWAY MATERIAL SELECTION AND INSTALLATION.
- 4.07 CONTRACTOR SHALL PERFORM AN ARC FLASH ANALYSIS AT THE INTEGRATED LOAD CENTER AND PROVIDE ARC FLASH LABEL PER NEC.
- 4.08 ALL CIRCUIT BREAKERS AND EQUIPMENT SHALL HAVE A MINIMUM AIC RATING OF 10,000 AMPS. IF THE RATING OF THE UTILITY TRANSFORMER PROVIDING THE ELECTRICAL SERVICE IS GREATER THAN 75 kVA, THE CONTRACTOR SHALL PERFORM A SHORT CIRCUIT ANALYSIS TO DETERMINE THE REQUIRED AIC RATING FOR THE CIRCUIT BREAKERS AND EQUIPMENT. PRIOR TO PURCHASING EQUIPMENT, THE CONTRACTOR SHALL CONTACT THE ELECTRIC UTILITY AND OBTAIN IN WRITING THE MAXIMUM AVAILABLE FAULT CURRENT (AFC) AT THE UTILITY SERVICE POINT. PROVIDE MAX. AFC SIGNAGE AS REQUIRED PER NEC 110.24. THE CONTRACTOR SHALL ENSURE ALL ELECTRICAL EQUIPMENT, CIRCUIT BREAKERS, DISCONNECTS, FUSES, AND PANELBOARDS HAVE A FAULT CURRENT INTERRUPTING RATING GREATER THAN THE AVAILABLE FAULT CURRENT.

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8921 RESEARCH DRIVE

PROJECT INFORMATION:

SITE NAME: SWALLOWTAIL SITE No.: 431713 PROJECT #: N/A 452 FARM LIFE SCHOOL RD CARTHAGE, NC 28327 MOORE COUNTY

TPLANS PREPARED BY:

Kimley WHorn

11720 AMBER PARK DRIVE, SUITE 600 ALPHARETTA, GA 30009 PHONE: 770-619-4280 WWW.KIMLEY-HORN.COM NC Licenss F-0102

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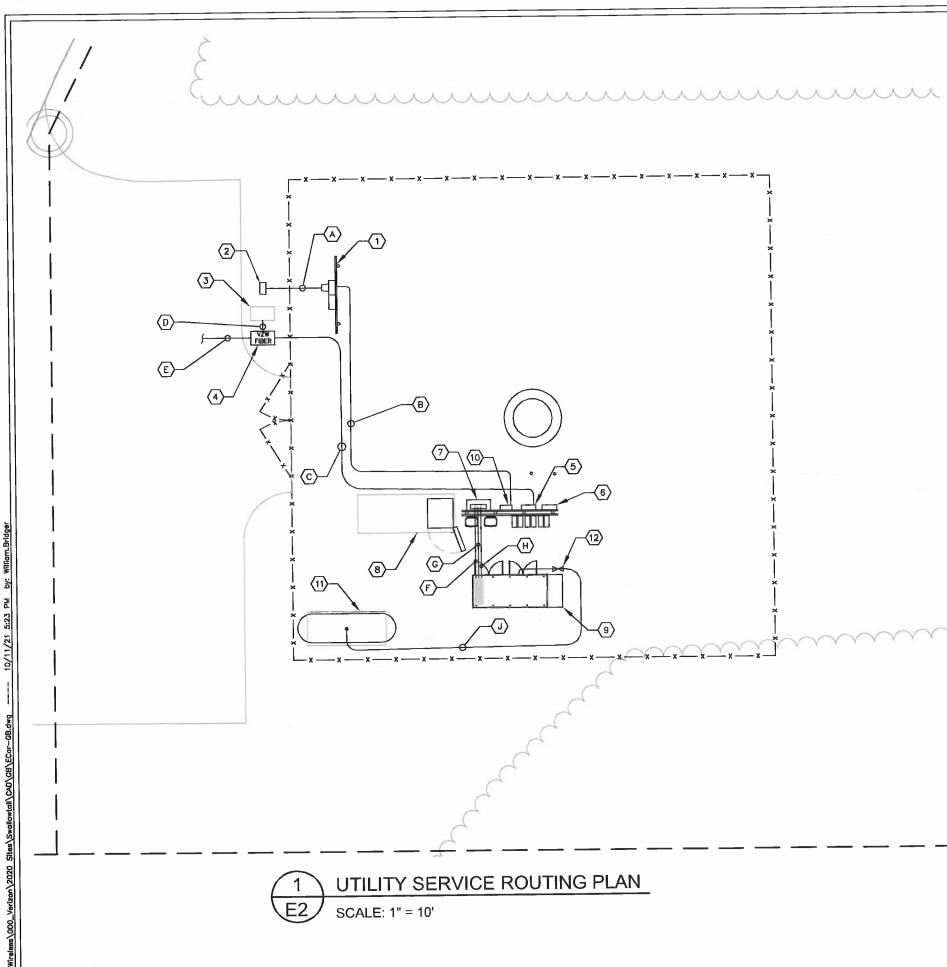
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ELECTRICAL NOTES

SHEET NUMBER:

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KEY NOTES - ELECTRICAL EQUIPMENT

- (1) UTILITY METER H-FRAME (SEE DETAIL 1/E4).
- POWER STUB UP (SEE NOTE 4.04 ON SHEET E1).
- EXISTING LIT FIBER HANDHOLE/PEDESTAL. (CONTRACTOR TO CONFIRM EXISTENCE AND LOCATION).
- TRAFFIC RATED TELCO VAULT LABELED "VZW FIBER". (SEE NOTE 4.05 ON SHEET E1)
- (5) TELCO BOX (SEE SHEET C4).
- (6) CIENA UNIT, IF NEEDED (SEE SHEET C4).
- $\overline{7}$ INTEGRATED LOAD CENTER (SEE SHEET C4).
- 8 VERIZON CONCRETE EQUIPMENT PAD (SEE SHEET C6).
- (9) VERIZON CONCRETE GENERATOR PAD (SEE SHEET C6).
- (10) DISCONNECT SWITCH (SEE SHEET C4).
- (11) VERIZON CONCRETE PROPANE TANK PAD. (SEE SHEET C6)
- (12) SHUT OFF VALVE. (SEE SHEET M1)


KEY NOTES - CONDUIT, CONDUCTORS, & MISC.

- TWO (2) 4" PVC POWER CONDUITS FOR INCOMING SERVICE LATERALS FROM LOCAL UTILITY (SEE TRENCH DETAIL 2/E7).
- B 2" PVC POWER CONDUIT FROM PROPOSED METER RACK TO EQUIPMENT RACK (SEE TRENCH DETAIL 2/E7).
- TWO (2) 2" PVC TELCO CONDUITS, WITH TWO (2) PULL ROPES EACH (SEE TRENCH DETAIL 2/E7).
- 4" PVC BRIDGE FIBER CONDUIT. (IF NO EXISTING LIT FIBER HANDHOLE/PEDESTAL IS PRESENT CONTRACTOR TO PROVIDER A 5' LONG CAPPED STUB BRIDGE CONDUIT).
- TWO (2) 2" PVC CONDUITS FROM RIGHT OF WAY W/TWO (2) PULL ROPES (SEE TRENCH DETAIL 2/E7 AND SHEET E3).
- 2" PVC CONDUIT FOR ROUTING POWER CONDUCTOR TO THE GENERATOR. (SEE TRENCH DETAIL 2/E7).
- 1" PVC CONDUIT FOR ROUTING GENERATOR CONTROL AND ALARM SIGNAL CABLES TO THE GENERATOR (SEE TRENCH DETAIL 2/E7).
- 1" PVC CONDUIT FOR ROUTING POWER CONDUCTOR TO THE GENERATOR BATTERY CHARGER AND THE GENERATOR BLOCK HEATER (SEE TRENCH DETAIL 2/E7).
- (J) PROPANE SERVICE LINE. (SEE SHEET M1)

NOTES:

GENERAL CONTRACTOR IS TO CONFIRM WITH VERIZON CONSTRUCTION MANAGER WHETHER INSTALLATION OF THE TWO (2) 2" CONDUITS TO THE RIGHT OF WAY WILL BE PART OF THE INITIAL CONSTRUCTION.



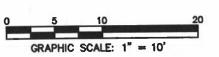



8921 RESEARCH DRIVE CHARLOTTE, NORTH CAROLINA 28262


PROJECT INFORMATION:

SITE NAME: SWALLOWTAIL SITE No.: 431713 PROJECT #: N/A 452 FARM LIFE SCHOOL RD CARTHAGE, NC 28327 MOORE COUNTY

PLANS PREPARED BY:

Kimley Whorr

720 AMBER PARK DRIVE, SUITE 600 ALPHARETTA, GA 30009 PHONE: 770-619-4280 WWW.IGMLEY-HORN.COM NC License F-0102

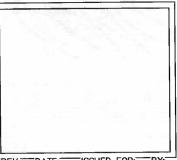

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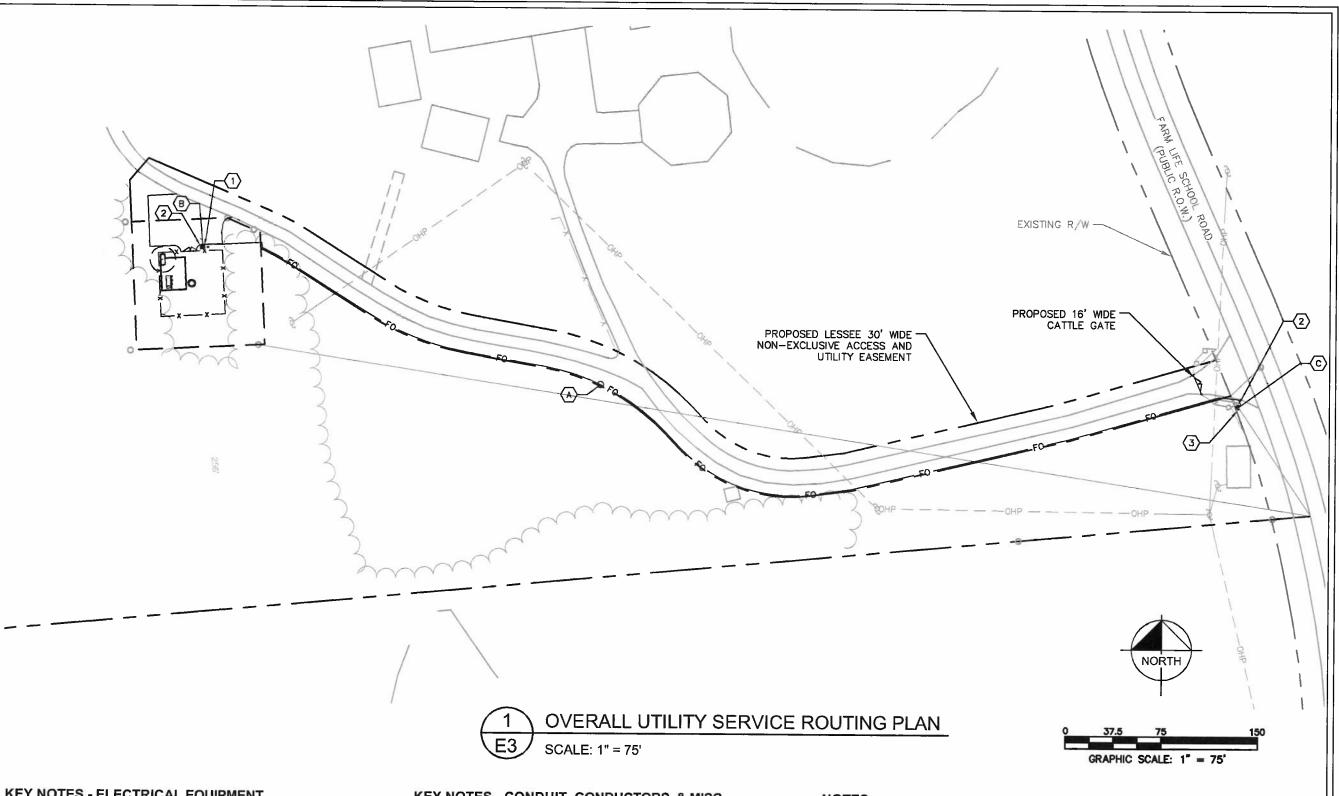
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UTILITY SERVICE ROUTING PLAN

SHEET NUMBER:

E2



KEY NOTES - ELECTRICAL EQUIPMENT

- 1 EXISTING LIT-FIBER HANDHOLE/PEDESTAL.
- TRAFFIC RATED TELCO VAULT LABELED "VZW FIBER". (SPACED EVERY 500', AT MAJOR TRANSITIONS, AND AS NEEDED TO ALLOW DAR FIBER TO BE PULLED)(SEE NOTE 4.05 ON SHEET E1)
- EXISTING ONE FIBER HANDHOLE (CONTRACTOR TO CONFIRM EXISTENCE AND LOCATION)

KEY NOTES - CONDUIT, CONDUCTORS, & MISC.

- TWO (2) 2" PVC CONDUIT FOR "VZW FIBER" WITH TWO (2) PULL ROPES. (SEE DETAIL 2/E6); (APPROXIMATELY 918± LF); GENERAL CONTRACTOR TO CONFIRM NEED FOR CONDUITS TO RIGHT OF WAY AND HANDHOLE AT RIGHT OF WAY WITH VERIZON CONSTRUCTION MANAGER.
- 4" PVC BRIDGE FIBER CONDUIT. (IF NO EXISTING LIT FIBER HANDHOLE/PEDESTAL IS PRESENT CONTRACTOR TO PROVIDER A 5' LONG CAPPED STUB BRIDGE CONDUIT).
- 4" PVC BRIDGE FIBER CONDUIT. (IF NO EXISTING ONE FIBER HANDHOLE IS PRESENT, BRIDGE CONDUIT WILL BE BY OTHERS)

NOTES:

GENERAL CONTRACTOR IS TO CONFIRM WITH VERIZON CONSTRUCTION MANAGER WHETHER INSTALLATION OF THE TWO (2) 2" CONDUITS TO THE RIGHT OF WAY WILL BE PART OF THE INITIAL CONSTRUCTION.

PROPOSED VERIZON TELCO VAULT WITHIN RIGHT OF WAY LOCATED APPROXIMATELY 35' 18' 29.41"N, 79' 21' 09.28"W BASED ON GOOGLE EARTH IMAGERY.


verizon

PROJECT INFORMATION:

SITE NAME: **SWALLOWTAIL** SITE No.: 431713 PROJECT#: N/A 452 FARM LIFE SCHOOL RD CARTHAGE, NC 28327 MOORE COUNTY

PLANS PREPARED BY:

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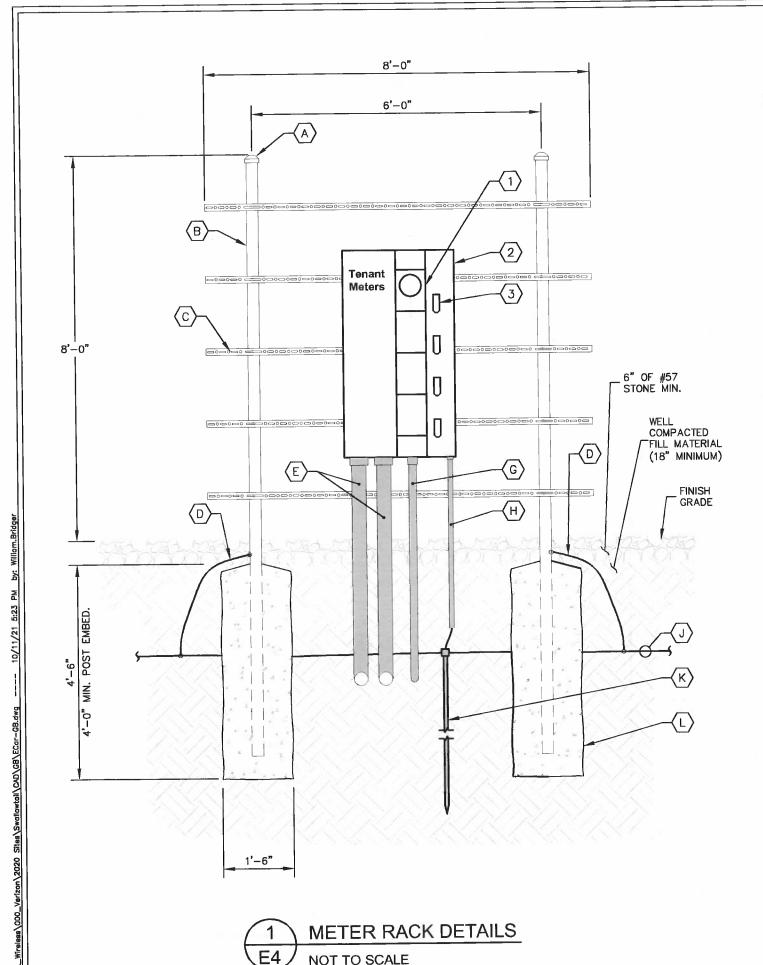
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SHEET TITLE:

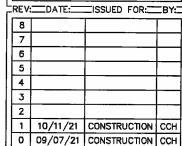OVERALL UTILITY ROUTING PLAN

SHEET NUMBER:



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KEY NOTES - CONDUIT, CONDUCTORS, & MISC

- igap A iggr) GALVANIZED RIGID STEEL CAP, TYPICAL.
- B 3" GALVANIZED RIGID STEEL PIPE, TYPICAL.
- C 1%" x 1%" GALVANIZED STEEL CHANNEL (UNISTRUT #P1000 OR APPROVED EQUIVALENT) WITH PLASTIC END CAP (UNISTRUT #P2860), TYPICAL.
- ONE (1) #2 AWG BARE SOLID TINNED COPPER BONDING CONDUCTORS (BC) FROM H-FRAME VERTICAL PIPE TO GROUND RING, EXOTHERMIC WELD BOTH ENDS.
- $\langle E \rangle$ 4" PVC CONDUIT FOR INCOMING SERVICE LATERALS FROM LOCAL UTILITY, TYPICAL OF 2.
- F KEYNOTE NOT USED.
- G 2" PVC CONDUIT FOR ROUTING FEEDERS TO NON-FUSED DISCONNECT SWITCH.
- H PVC CONDUIT WITH ONE (1) 2/0 BARE STRANDED TINNED COPPER GROUNDING ELECTRODE CONDUCTOR (GEC) FROM GROUNDING LUG TO GROUND ROD, EXOTHERMIC WELD GEC TO GROUND ROD.
- (J) GROUND RING (SEE "E" SHEETS).
- (K) GROUND ROD, EXOTHERMIC WELD TO GROUND RING. (SEE "E" SHEETS).
- CONCRETE FOUNDATION FOR H-FRAME VERTICAL PIPE. CONCRETE SHALL HAVE A 28 DAY COMPRESSIVE STRENGTH OF 4,000 PSI. AND INCLUDE FIBERMESH 650-3E.

KEY NOTES - ELECTRICAL EQUIPMENT

- 200 AMP METER SOCKET IN NEMA 3R ENCLOSURE, TYPICAL OF 4. ONLY TOP SOCKET WILL RECEIVE METER UNDER THIS CONTRACT.
- 800 AMP, 22KAIC, 4 GANG, SERVICE ENTRANCE RATED METER CENTER IN NEMA 3R ENCLOSURE. BOND TO RACK PER NEC.
- 200 AMP, 2 POLE (22KAIC) DISCONNECT CIRCUIT BREAKER FOR TOP METER ONLY. CONTRACTOR SHALL MOUNT THE METER CENTER SUCH THAT THE TOP CIRCUIT BREAKER IS NO MORE THAN 6' ABOVE GRADE.



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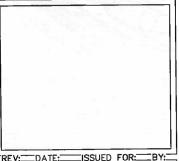
PROJECT INFORMATION: _____ SITE NAME:

SWALLOWTAIL
SITE No.: 431713
PROJECT #: N/A
452 FARM LIFE SCHOOL RD
CARTHAGE, NC 28327
MOORE COUNTY


TPLANS PREPARED BY:

Kimley » Horr

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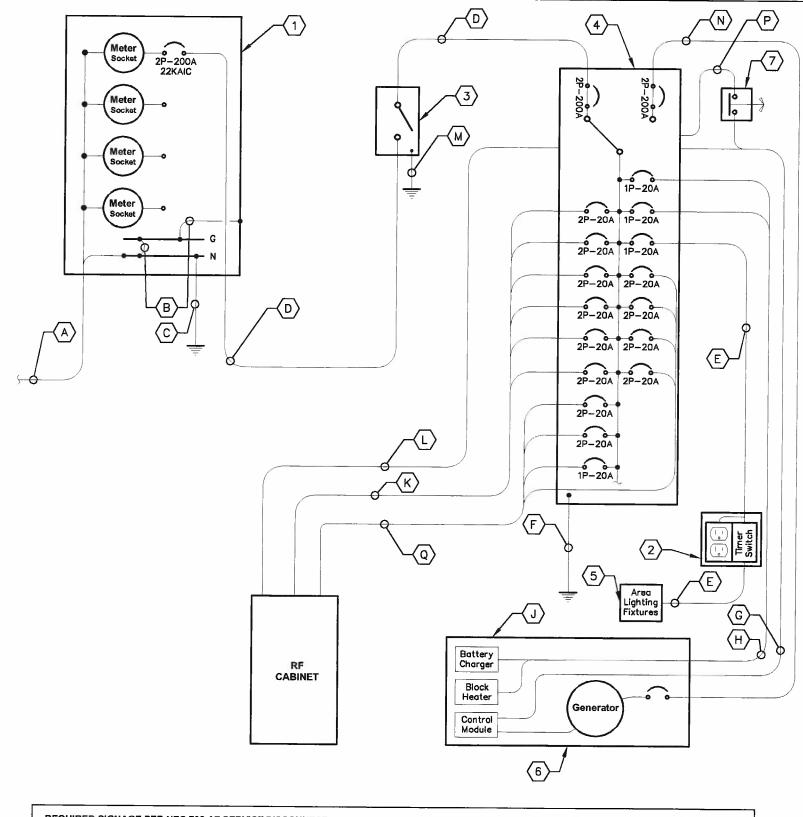
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METER RACK DETAILS

SHEET NUMBER:

E4

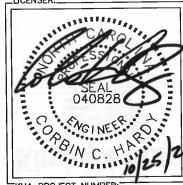

REQUIRED SIGNAGE PER NEC 702 AT SERVICE DISCONNECT

"WARNING: Shock hazard exists if grounding electrode conductor or bonding jumper connection in this equipment is removed while alternate source(s) is energized. Opening the equipment disconnect will cause the stand-by generator to start. To remove power entirely from the equipment, the generator must be turned OFF using emergency stop switch."

REQUIRED SIGNAGE PER NEC 702 AT SERVICE **DISCONNECT & INTEGRATED LOAD CENTER**

"NOTE: Emergency power is supplied by a stand-by generator located behind Verizon equipment rack."

ELECTRICAL SINGLE LINE DIAGRAM NOT TO SCALE

KEY NOTES - CONDUIT, CONDUCTORS, & MISC

- TWO (2) 4" CONDUITS BY CONTRACTOR FOR INCOMING SERVICE LATERALS BY LOCAL UTILITY FOR 800 AMP, 120/240 VOLT SINGLE PHASE SERVICE.
- BOND GROUND BUS TO NEUTRAL BUS AND GROUND BUS TO ENCLOSURE WITH 2/0 BONDING JUMPERS.
- ONE (1) 2/0 BARE STRANDED TINNED COPPER GEC TO GROUND ROD, EXOTHERMIC WELD GEC TO GROUND ROD.
- THREE (3) 3/0 CONDUCTORS AND ONE (1) #6 AWG GROUND IN 2"
- TWO (2) #12 AWG CONDUCTORS AND ONE (1) #12 AWG GROUND IN 1"
- ONE (1) #2 BARE TINNED COPPER FROM GROUNDING LUG IN ILC TO GROUND ROD, EXOTHERMIC WELD TO GROUND ROD.
- AUTOMATIC TRANSFER SWITCH ALARM AND GENERATOR CONTROL CABLES IN 1" CONDUIT.
- FOUR (4) #12 CONDUCTORS AND ONE (1) #12 AWG GROUND IN 1" CONDUIT
- THE GENERATOR, WHEN UTILIZING A TWO POLE ATS WITH A SOLID NEUTRAL, IS NOT A SEPARATELY DERIVED SYSTEM. THEREFORE, DO NOT BOND THE NEUTRAL TO THE GROUND AT THE GENERATOR.
- TWELVE (12) #10 AWG THHN CONDUCTORS AND THREE (3) #10 AWG EG IN 2" PVC CONDUIT.
- ALARM CABLES IN 1" PVC CONDUIT.
- ONE (1) #2 BARE TINNED COPPER FROM GROUNDING LUG IN DISCONNECT SWITCH TO GROUND RING, EXOTHERMIC WELD TO GROUND
- THREE (3) 3/0 AWG CONDUCTORS AND ONE (1) #4 AWG EG IN 2" CONDUIT. VERIFY GENERATOR BREAKER DOES NOT EXCEED 200 AMPS.
- 1" PVC CONDUIT FOR ROUTING POWER CONDUCTORS FROM THE ILC TO THE EMERGENCY GENERATOR STOP SWITCH.
- TWELVE (12) #10 AWG THHN CONDUCTORS AND THREE (3) #10 AWG. FOR RECTIFIERS AND TWO (2) #10 THHN CONDUCTORS AND ONE (1) #10 AWG FOR CABINET MOUNTED GFI OUTLET, ALL IN ONE 2" PVC CONDUIT.

KEY NOTES - ELECTRICAL EQUIPMENT

- FURNISH AND INSTALL 800 AMP, 3-WIRE, SINGLE PHASE, 120/240 VOLT, 22KAIC, FOUR-SPACE MULTI-GANG METER CENTER WITH 200 AMP RATED METER SOCKETS IN NEMA 3R ENCLOSURE, SE RATED. CONTRACTOR SHALL FURNISH AND INSTALL 200 AMP CIRCUIT BREAKER AT METER BASE IF NOT
- 20 AMP GFCI DUPLEX OUTLET RECEPTACLE AND TIMER SWITCH, ENERLITES HETO6 SERIES (OR APPROVED EQUIVALENT) IN LOCKABLE NEMA 3R
- FURNISH AND INSTALL SE RATED 240 V, 200 AMP, 2 POLE, NON-FUSED DISCONNECT IN NEMA 3R ENCLOSURE.
- 200 AMP, 120/240 VOLT, ILC WITH 42 SPACE PANEL AND AUTOMATIC TRANSFER SWITCH. ALL CIRCUIT BREAKERS SHALL BE RATED 10KAIC MINIMUM. ILC IS FURNISHED BY VZW AND INSTALLED BY GENERAL CONTRACTOR.
- FURNISH AND INSTALL TWO (2) AREA LIGHTS, (LITHONIA HFR-250M-TA120-DNA-LP1), (OR APPROVED EQUIVALENT).
- 50 KW DIESEL GENERATOR, CONTRACTOR SHALL COORDINATE SPECIFIC GENERATOR CONFIGURATION WITH OWNER AND INSTALL THE GENERATOR IN ACCORDANCE WITH MANUFACTURER'S INSTALLATION INSTRUCTIONS. GENERATOR BREAKER SIZED AND PROVIDED BY GENERATOR
- EMERGENCY GENERATOR STOP SWITCH IN NEMA 3R ENCLOSURE WILL BE FURNISHED BY VERIZON AND INSTALLED BY GC.

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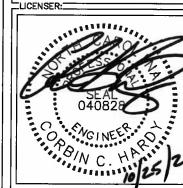
EPROJECT INFORMATION:

SWALLOWTAIL SITE No.: 431713 PROJECT #: N/A 452 FARM LIFE SCHOOL RD CARTHAGE, NC 28327 MOORE COUNTY

TPLANS PREPARED BY:

ALPHARETTA, GA 30009 PHONE: 770-619-4280 WWW.KIMI.FY-HORN COM

REV: DATE: ISSUED FOR: BY: 3 1 10/11/21 CONSTRUCTION CCH 0 09/07/21 CONSTRUCTION CCH



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ELECTRICAL SINGLE LINE DIAGRAM

PANEL SCHEDULE - VERIZON INTEGRATED LOAD CENTER

Voltage: 240/120 Volts
Phase, Wires: Single Phase, 3 Wire
Mounting Type: Surface

Enclosure Type: NEMA 3R

MCB Size: 200 Amps AIC Rating: 10,000 Amps min Bus Rating: 200 Amps Neutral Rating: 100%

	Load (kVA)		Circuit	Ckt	Pha	ase	Ckt	Circuit	Load	(kVA)	_
Load Served	Α	В	Bkr Size	Nbr	Α	В	Nbr	Bkr Size	Α	В	Load Served
RECTIFIER 1	1.78		2P-20	1	-1-+-	1	2	1P-20	0.58		AREA LIGHTS/GFCI
		1.78	21-20	3		1	4	1P-20		1.50	GEN BLOCK HEATER
RECTIFIER 2	1.78		2P-20	5		-	6	1P-20	0.30		GEN BATTERY CHARGE
		1.78	21-20	7		•	8			0.00	SPACE
RECTIFIER 3	1.78		2P-20	9		├	10	1P-20	0.18		CAB DUPLEX OUTLET
		1.78	27-20	11		•	12			0.00	SPACE
RECTIFIER 4	1.78		2P-20	13		1	14	2P-20	1.78		DECTIFIED A
		1.78	27-20	15		+	16	2F-20		1.78	RECTIFIER 9
RECTIFIER 5	1.78		2P-20	17	-	1	18	2P-20	1.78		DECTIFIED 10
		1.78	21-20	19		-	20	25-20		1.78	RECTIFIER 10
RECTIFIER 6	1.78		2P-20	21		1	22	2P-20	0.00		DECTIFIED 44 (CDADE)
		1.78	27-20	23		•	24	2F-20		0.00	RECTIFIER 11 (SPARE)
RECTIFIER 7	1.78		2P-20	25		-1-	26	2P-20	0.00		DECTIFIED 40 (CDADE)
		1.78	21-20	27		+	28	27-20		0.00	RECTIFIER 12 (SPARE)
RECTIFIER 8	1.78		2P-20	29		-	30		0.00		SPACE
		1.78	21-20	31		•	32			0.00	SPACE
SPACE	0.00			33	•	-	34		0.00		SPACE
SPACE		0.00		35	•	••	36			0.00	SPACE
SPACE	0.00			37	•	+•	38		0.00		SPACE
TVSS		0.00	2P-30	39	-1-	•	40			0.00	SPACE
(INTERNAL TO ILC)	0.00		27-30	41			42		0.00		SPACE
Sub-Total (kVA)	14.24	14.24							4.62	5.06	Sub-Total (kVA)

LOAD SUMMARY

Total Connected (kVA)

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18.86 19.30

38.16

		nected (kVA)	Demand		nand (kVA)
Load Description	Α	В	Factor	Α	В
RECTIFIERS/EQUIP	17.80	17.80	1.00	17.80	17.80
LARGEST MOTOR	0.00	0.00	1.00	0.00	0.00
ALL OTHER MOTORS	0.00	0.00	1.00	0.00	0.00
LIGHTING	0.40	0.00	1.25	0.50	0.00
DUPLEX RECEPTACLES	0.36	0.00	1.00	0.36	0.00
TOTAL MISCELLANEOUS	0.30	1.50	1.00	0.30	1.50
Total Power per Phase				18.96	19.30
Total Demand Current per Phase				158.00	161.00
Total Demand Power				38	.26

*NOTE: CIRCUIT LOAD AND DEMAND FACTOR PROVIDED BY VERIZON.



verizon/

ARLOTTE, NORTH CAROLINA 28262

PROJECT INFORMATION:

SITE NAME: SWALLOWTAIL SITE No.: 431713 PROJECT #: N/A 452 FARM LIFE SCHOOL RD CARTHAGE, NC 28327 MOORE COUNTY

PLANS PREPARED BY:

Kimley»Horn

20 AMBER PARK DRIVE, SUITE 600 ALPHARETTA, GA 30009 PHONE: 770-619-4280 WWW.KUMLEY-HORN.COM NC License F-0102

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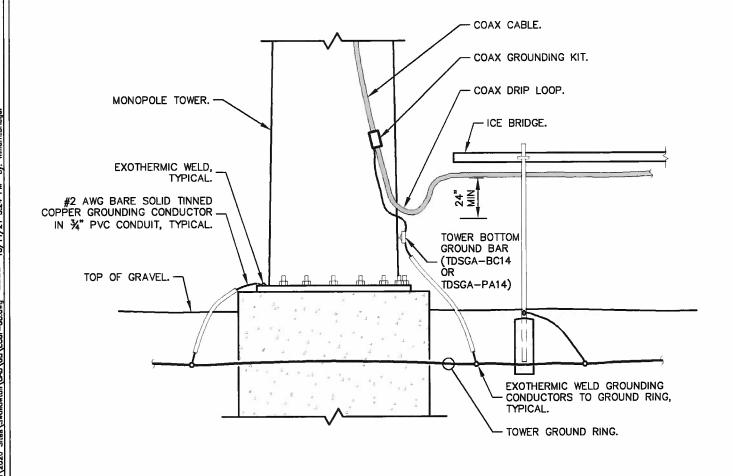
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PANEL SCHEDULE


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DRIP LOOP DETAIL

NOT TO SCALE



1. IF GROUND SURFACE IS OTHER THAN NEWLY GRAVELED AREA. CONTRACTOR IS TO RESTORE TO ORIGINAL CONDITION.

PROVIDE PVC CONDUIT BELOW GRADE EXCEPT AS NOTED BELOW.
PROVIDE SCHEDULE 40 OR SCHEDULE 80 PVC CONDUIT & ELBOWS AT STUB UP LOCATIONS (I.E. POLES, EQUIPMENT, ETC.)

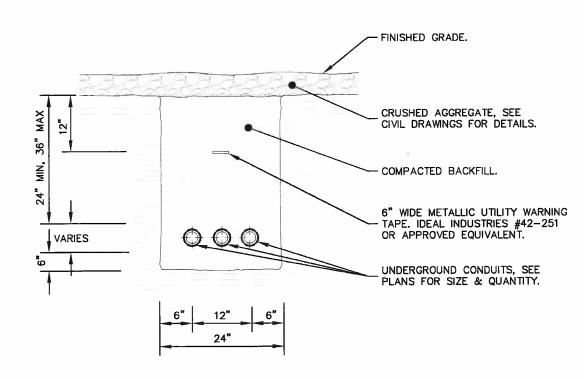4. PROVIDE SCHEDULE 80 PVC CONDUIT BELOW PARKING LOTS AND ROADWAYS.

TYPICAL TRENCH DETAIL

NOT TO SCALE

PROJECT INFORMATION:

verizon/

SITE NAME: SWALLOWTAIL SITE No.: 431713 PROJECT #: N/A 452 FARM LIFE SCHOOL RD CARTHAGE, NC 28327 MOORE COUNTY


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SHEET TITLE:

ELECTRICAL DETAILS

SHEET NUMBER:

E7

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GROUNDING NOTES

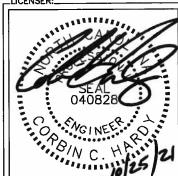- THE GROUND RING SHALL CONSIST OF #2 AWG BARE SOLID TINNED COPPER (STC) CONDUCTOR, UNLESS NOTED OTHERWISE, BURIED AT 30" BELOW FINISHED GRADE (OR BELOW FROST LINE). LOCATE 24" MINIMUM AND 36" MAXIMUM FROM EQUIPMENT AREA AND FROM TOWER FOUNDATION. ALL CONNECTIONS SHALL BE MADE USING A PARALLEL TYPE EXOTHERMIC WELD, UNLESS NOTED OTHERWISE.
- 2. INSTALL GROUND RODS AS SHOWN AND AS REQUIRED. GROUND RODS TO BE COPPER CLAD STEEL, 5/8" DIAMETER AND 10FT IN LENGTH. SPACING BETWEEN GROUND RODS SHALL BE 10FT MINIMUM AND 15FT MAXIMUM. TOP OF GROUND ROD TO BE 30" MINIMUM BELOW GRADE (OR BELOW FROST LINE). BOND TOP OF GROUND ROD TO GROUND WIRE WITH EXOTHERMIC WELD. DO NOT EXOTHERMICALLY WELD ANYTHING TO GROUND ROD EXCEPT GROUND WIRE WHICH PASSES OVER TOP OF GROUND ROD (CLAMPED CONNECTIONS TO GROUND ROD PER TOWER MANUFACTURERS DETAILS ARE ACCEPTABLE).
- 3. EQUIPMENT GROUND RING SHALL HAVE A MINIMUM OF 4 GROUND RODS, INSTALLED AT THE CORNERS OF THE GROUND RING PLUS ADDITIONAL RODS AS REQUIRED TO COMPLY WITH THE SPACING REQUIREMENTS. TOWER GROUND RING SHALL HAVE A MINIMUM OF 3 GROUND RODS, EXCEPT USE 4 RODS AT A MONOPOLE TOWER. WHERE SPREAD TOWER FOOTING WOULD PREVENT GROUND RODS FROM BEING DRIVEN INTO SOIL ADJACENT TO TOWER, PROVIDE VERTICAL 1" DIAMETER PVC SLEEVES EMBEDDED IN FOOTING TO ALLOW INSTALLATION OF GROUND RODS.
- 4. EQUIPMENT GROUND RING AND TOWER GROUND RING SHALL BE BONDED TOGETHER WITH TWO #2 STC GROUND LEADS, TYPICALLY ONE ON EACH SIDE OF ICE BRIDGE.
- 5. BOND TOWER TO TOWER GROUND RING AT THREE LOCATIONS WITH #2 STC GROUND LEAD. SELF SUPPORT TOWERS SHALL HAVE EACH LEG BONDED TO GROUND RING, MONOPOLES AND GUYED TOWERS SHALL HAVE GROUND LEADS EQUALLY SPACED AROUND TOWER. EXOTHERMICALLY WELD GROUND LEADS TO TOP OF BASE PLATES, OR ATTACH TO TOWER USING TOWER MANUFACTURER PROVIDED DETAIL.
- 5. PROVIDE #2 STC RADIALS FROM THE TOWER GROUND RING TO EACH FENCE CORNER POST. RADIALS SHALL HAVE GROUND RODS AS PER THE REQUIRED SPACING. THE GROUND ROD AT THE END OF EACH RADIAL SHALL BE 24" MAXIMUM FROM FENCE CORNER POST. EQUIPMENT AREA GROUND RING AND CONNECTING GROUND LEADS [BETWEEN EQUIPMENT AREA AND TOWER GROUND RINGS] MAY BE USED AS PART OF THE RADIAL GOING TO THE FENCE CORNER POST CLOSEST TO THE EQUIPMENT AREA.
- MINIMUM BEND RADIUS FOR #2 AWG GROUND WIRE IS 12", EXCEPT USE 24" FOR TOWER GROUND RINGS AND EQUIPMENT PAD GROUND RINGS.
- 8. GROUND ALL EXTERIOR EXPOSED METAL OBJECTS. USE TWO HOLE LUGS FOR CONNECTION TO FLAT METAL SURFACES. USE ONLY STAINLESS STEEL HARDWARE ON ALL MECHANICAL CONNECTIONS. CLEAN ALL SURFACES (AND STRIP PAINTED SURFACES) TO BARE BRIGHT METAL PRIOR TO MAKING GROUND CONNECTIONS. APPLY ANTI—OXIDE COMPOUND TO ALL CONNECTIONS. APPLY ZINC RICH PAINT (COLD GALV.) TO ALL EXOTHERMIC WELDS, AND TO ANY METAL EXPOSED BY CLEANING, STRIPPING, GRINDING, CUTTING OR DRILLING.
- 9. ALL GROUNDING CONDUCTORS ABOVE GRADE SHALL BE RUN IN 3/4" FLEXIBLE PVC CONDUIT. CONDUIT SHALL BEGIN WITHIN 3/4" OF ABOVE GROUND CONNECTION POINT, SHALL EXTEND 24" BELOW GRADE MINIMUM, AND SHALL BE FILLED WITH SEALANT AT ABOVE GROUND CONNECTION POINT. SECURE CONDUIT EVERY 24" ON VERTICAL RUNS AND EVERY 36" ELSEWHERE WITH NON-METALLIC TIES.

- 10A. AT GUYED AND SELF SUPPORT TOWERS MOUNT TDSGA-PA14
 TOWER BOTTOM GROUND BAR ON DEDICATED POST DIRECTLY BELOW
 COAX CABLES COMING OFF TOWER. POST TO BE 3.5" OD
 GALVANIZED SCHEDULE 40 PIPE WITH GALVANIZED PIPE CAP. TOP
 OF POST TO BE 78" ABOVE GRADE. EMBED POST 30" MINIMUM IN
 12" DIAMETER BY 36" DEEP MINIMUM CONCRETE FOOTING WITH TOP
 OF FOOTING 6" BELOW GRADE. IF TOWER FOUNDATION OBSTRUCTS
 AUGERED FOOTING, USE POST WITH 10" SQUARE GALVANIZED STEEL
 FLANGE PLATE WELDED TO BOTTOM AND BOLT FLANGE TO TOP OF
 CONCRETE TOWER FOOTING.
- 10B. AT MONOPOLE TOWERS CLAMP TDSGA—BC14 TOWER BOTTOM GROUND BAR DIRECTLY TO TOWER. IF RUNNING COAX INSIDE MONOPOLE, CLAMP ONTO BOTTOM LIP OF EXIT PORT. IF BANDING COAX TO OUTSIDE OF TOWER, CLAMP ONTO STEEL ANGLE WHICH IS BANDED TO TOWER. BOND TDSGA—BC14 TO TOWER GROUND RING WITH TWO #2 STC LEADS LUGGED TO GROUND BAR AND EXOTHERMICALLY WELDED TO GROUND RING.
- 11. AT EQUIPMENT AREA, INSTALL TDSGA—PA14 EXTERIOR GROUND BAR (THRU—BOLTED STYLE) AT BASE OF (2) INTERIOR H—FRAME POSTS AND AT TOP OF ICE BRIDGE POST WHICH IS NEAREST TO (BUT CLOSER TO TOWER THAN) THE COAX CABLE TERMINATION. MOUNT GROUND BAR TO H—FRAME POSTS AT 6" ABOVE GRAVEL AND TO ICE BRIDGE POST AT 6FT ABOVE GRAVEL.
- 12. ALL ICE BRIDGE SECTIONS ARE TO BE JUMPERED TOGETHER WITH #2 WIRE, EITHER BARE TINNED COPPER OR GREEN INSULATED STRANDED. ICE BRIDGE SHALL BE GROUNDED AT EACH END WITH #2 STC WIRE LUGGED TO ICE BRIDGE AND EXOTHERMICALLY WELDED TO UPPER PORTION OF NEAREST ICE BRIDGE POST. ICE BRIDGE SECTIONS ABOVE H-FRAME SHALL BE BONDED TO EACH OTHER WITH JUMPERS AT EACH END THIS ASSEMBLY WILL BE CONSIDERED AS A SINGLE ICE BRIDGE SECTION FOR GROUNDING PURPOSES.
- 13. BOND EACH ICE BRIDGE POST, H-FRAME POST OR DEDICATED GROUNDING POST TO BURIED GROUNDING SYSTEM WITH #2 STC LEAD EXOTHERMICALLY WELDED TO POST BELOW TOP OF GRAVEL AND EXOTHERMICALLY WELDED TO GROUND RING. EACH POST TO HAVE SEPARATE GROUND LEAD DIRECTLY TO GROUND RING DO NOT DAISY CHAIN POSTS TOGETHER.
- 14. BOND EACH RF CABINET TO EQUIPMENT GROUND RING WITH #2
 AWG TINNED SOLID BARE COPPER CONDUCTOR LUGGED TO CABINET
 BODY AND EXOTHERMICALLY WELDED TO GROUND RING. LUG TO
 CABINET BODY USING LOCATION AT WHICH STUDS ON CABINET
 CHASSIS HAVE DIRECT GROUND WIRE CONNECTION TO CABINET
 INTERNAL GROUND BAR. RUN CONDUIT AND CONDUCTOR ACROSS
 BACK OF CABINET (DO NOT RUN TOWARDS NEAREST CORNER OF
 CABINET AND THEN BEND GROUND WIRE SHARPLY), ACROSS
 CONCRETE PAD BELOW CABLE LADDER, THEN DOWN INTO GRAVEL
 AREA.
- 15. BOND EACH BATTERY CABINET TO GROUND RING WITH #2 AWG TINNED SOLID BARE COPPER CONDUCTOR LUGGED TO CABINET BODY AND EXOTHERMICALLY WELDED TO GROUND RING. RUN GROUND LEAD IN FLEX CONDUIT ALONG BACK OF RBA72 CABINET, ACROSS CONCRETE PAD BELOW CABLE LADDER, THEN DOWN INTO GRAVEL AREA. CONNECT TWO HOLE LUG TO BACK OF CABINET AT FACTORY PROVIDED GROUNDING STUDS.
- 16. BOND GENERATOR TO GROUND RING WITH #2 STC AT TWO DIAGONALLY OPPOSITE LOCATIONS BY DRILLING AND BOLTING TWO HOLE LUG TO FINS ON GENERATOR BASE STRUCTURE. GROUND LEADS SHOULD TAKE SHORTEST PATH ACROSS CONCRETE PAD TO GRAVEL AREA, THEN CONTINUE TO GROUND RING.

- 17. WHERE PROPANE TANK IS INSTALLED TO FUEL GENERATOR, BOND PROPANE TANK TO GROUND RING WITH A SINGLE #2 STC CLAMPED TO FILLER PIPE OF PROPANE TANK AND EXOTHERMICALLY WELDED TO GROUND RING. GROUND LEAD SHOULD RUN TO TANK SUPPORT AND TAKE SHORTEST PATH ACROSS CONCRETE PAD TO GRAVEL AREA, THEN CONTINUE TO GROUND RING. IF PROPANE TANK FUEL LINE IS METALLIC AND CROSSES EQUIPMENT GROUND RING, BOND FUEL LINE TO EQUIPMENT GROUND RING WHERE THE TWO LINES CROSS WITH A SINGLE #2 STC CLAMPED TO FUEL LINE AND EXOTHERMICALLY WELDED TO GROUND RING.
- 18. BOND GPS ANTENNA and GPS ANTENNA MOUNT TO TSDGA GROUND BAR AT BOTTOM OF H-FRAME POST WITH #2 GREEN INSULATED STRANDED GROUND WIRE.
- 19. PROVIDE TWO GROUND RODS OUTSIDE GATES OF COMPOUND.
 DISTANCE BETWEEN GROUND RODS SHALL MATCH WIDTH OF GATE
 OPENING, AND DISTANCE FROM FENCE SHALL MATCH LENGTH OF
 LONGEST INDIVIDUAL GATE LEAF. BOND GATE POSTS TOGETHER WITH
 #2 STC LEAD WHICH RUNS PAST AND CONNECTS TO GROUND RODS
 OUTSIDE GATES.
- BOND EACH GATE POST WITH #2 STC TO NEAREST PORTION OF GROUNDING SYSTEM INSIDE COMPOUND.
- 21. BOND EACH GATE TO GATE POST WITH FLEXIBLE INSULATED OR BRAIDED #4/O COPPER STRAP. EXOTHERMICALLY WELD STRAP TO BOTH GATE AND GATE POSTS.
- 22. ANY METAL FENCE POST WITHIN 6FT OF A GROUNDED METAL OBJECT SHALL BE BONDED TO THE NEAREST GROUND RING. ANY METAL FENCE WITHIN 6FT OF A GROUND RING SHALL HAVE THE LINE POSTS BONDED TO THE GROUND RING AT 20FT MAXIMUM INTERVALS AS MEASURED ALONG THE LENGTH OF THE FENCE.
- 23. WHERE GROUND BASED RRU'S, RAYCAP OVP'S OR DIPLEXERS ARE INSTALLED AT THE EQUIPMENT AREA, BOND EACH COMPONENT TO NEAREST TDSGA GROUND BAR BELOW THE COMPONENT WITH #2 GREEN INSULATED STRANDED GROUND WIRE. SINGLE HOLE LUG OR RING TYPE CONNECTOR IS SUITABLE FOR CONNECTION TO GROUNDING STUD ON EACH COMPONENT.
- 24. NOTIFY VZW CM TO INSPECT GROUND RING BEFORE BACKFILLING. CONTRACTOR SHALL HIRE A 3RD PARTY TO PERFORM AN IEEE81 FALL OF POTENTIAL METHOD GROUND TEST. MAXIMUM ALLOWABLE RESISTANCE TO GROUND IS 5 OHMS. PROVIDE ADDITIONAL GROUND SYSTEM COMPONENTS AS REQUIRED TO ACHIEVE THIS VALUE.
- 25. REFER TO TOWER GROUNDING DIAGRAM AND NOTES FOR GROUND SYSTEM REQUIREMENTS ON THE TOWER.
- 26. GROUNDING OF ALL ELECTRICAL EQUIPMENT SHALL BE AS PER NEC, MUNICIPAL AND UTILITY COMPANY REQUIREMENTS.

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8921 RESEARCH DRIVE CHARLOTTE, NORTH CAROLINA 28262


PROJECT INFORMATION:

SITE NAME: SWALLOWTAIL SITE No.: 431713 PROJECT #: N/A 452 FARM LIFE SCHOOL RD CARTHAGE, NC 28327 MOORE COUNTY

PLANS PREPARED BY:


Kimley»Horn

11720 AMBER PARK DRIVE, SUITE 600 ALPHARETTA, GA 30009 PHONE: 770-619-4280 WWW.KIMLEY-HORN.COM NC License F-0102

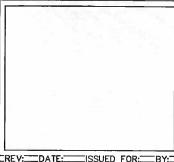

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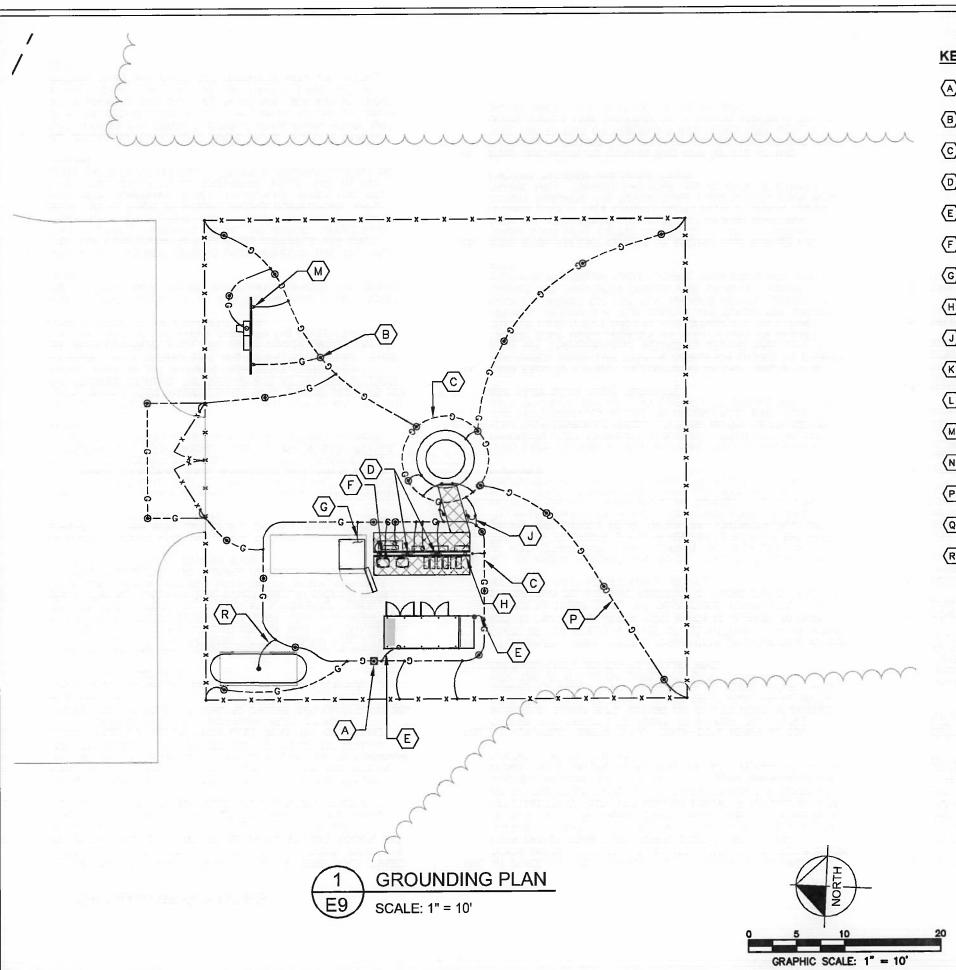
GROUNDING NOTES

SHEET NUMBER:

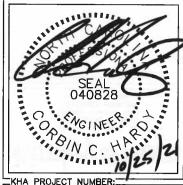E8

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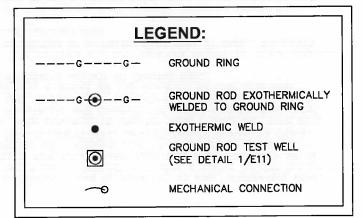
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KEY NOTES - GROUNDING EQUIPMENT

- (A) GROUND ROD TEST WELL (SEE DETAIL 1/E11).
- GROUND ROD, TYPICAL (SEE DETAIL 2/E11 AND NOTES 2 AND 3 ON E8).
- TOWER AND EQUIPMENT GROUND RING (SEE NOTES 1, 3, 4, 5, 6 AND 7 ON E8).
- TDSGA-PA14 OR TDSGA-BC14 WHERE APPLICABLE (SEE NOTES 10 AND 11 ON E8).
- (E) GENERATOR GROUNDING (SEE NOTE 16 ON E8).
- $\langle F \rangle$ GPS ANTENNA GROUNDING (SEE NOTE 18 ON E8).
- G RF CABINET GROUNDING (SEE NOTE 14 ON E8).
- $\langle H \rangle$ RRU'S AND OVP'S GROUNDING (SEE NOTE 23 ON E8).
- ICE BRIDGE POST BOND TO GROUND RING, TYPICAL (SEE NOTES 12 AND 13 ON E8).
- FENCE POST GROUNDING, TYPICAL. (SEE NOTE 22 ON E8).
- GATE GROUNDING, TYPICAL. (SEE NOTES 19, 20 & 21 ON E8).
- UTILITY H-FRAME GROUNDING, TYPICAL. (SEE SHEET E4 AND NOTE 13 ON E8).
- TOWER GROUNDING, TYPICAL. (SEE NOTES 5, 6 & 25 ON E8).
- (P) GROUND RADIALS, TYPICAL (SEE NOTE 6 ON E8).
- REFER TO SHEETS E8, E10, E11 & E12 FOR GROUNDING NOTES, DETAILS, AND SPECIFICATIONS.
- PROPANE TANK GROUNDING, IF INSTALLED (SEE NOTE 17 ON E8).






8921 RESEARCH DRIVE CHARLOTTE, NORTH CAROLINA 28262

PROJECT INFORMATION:

SITE NAME: SWALLOWTAIL SITE No.: 431713 PROJECT #: N/A 452 FARM LIFE SCHOOL RD CARTHAGE, NC 28327 MOORE COUNTY

PLANS PREPARED BY:

ALPHARETTA, GA 30009 PHONE: 770-619-4280 WWW.KIMLEY-HORN.COM NC License F-0102

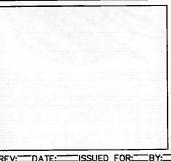

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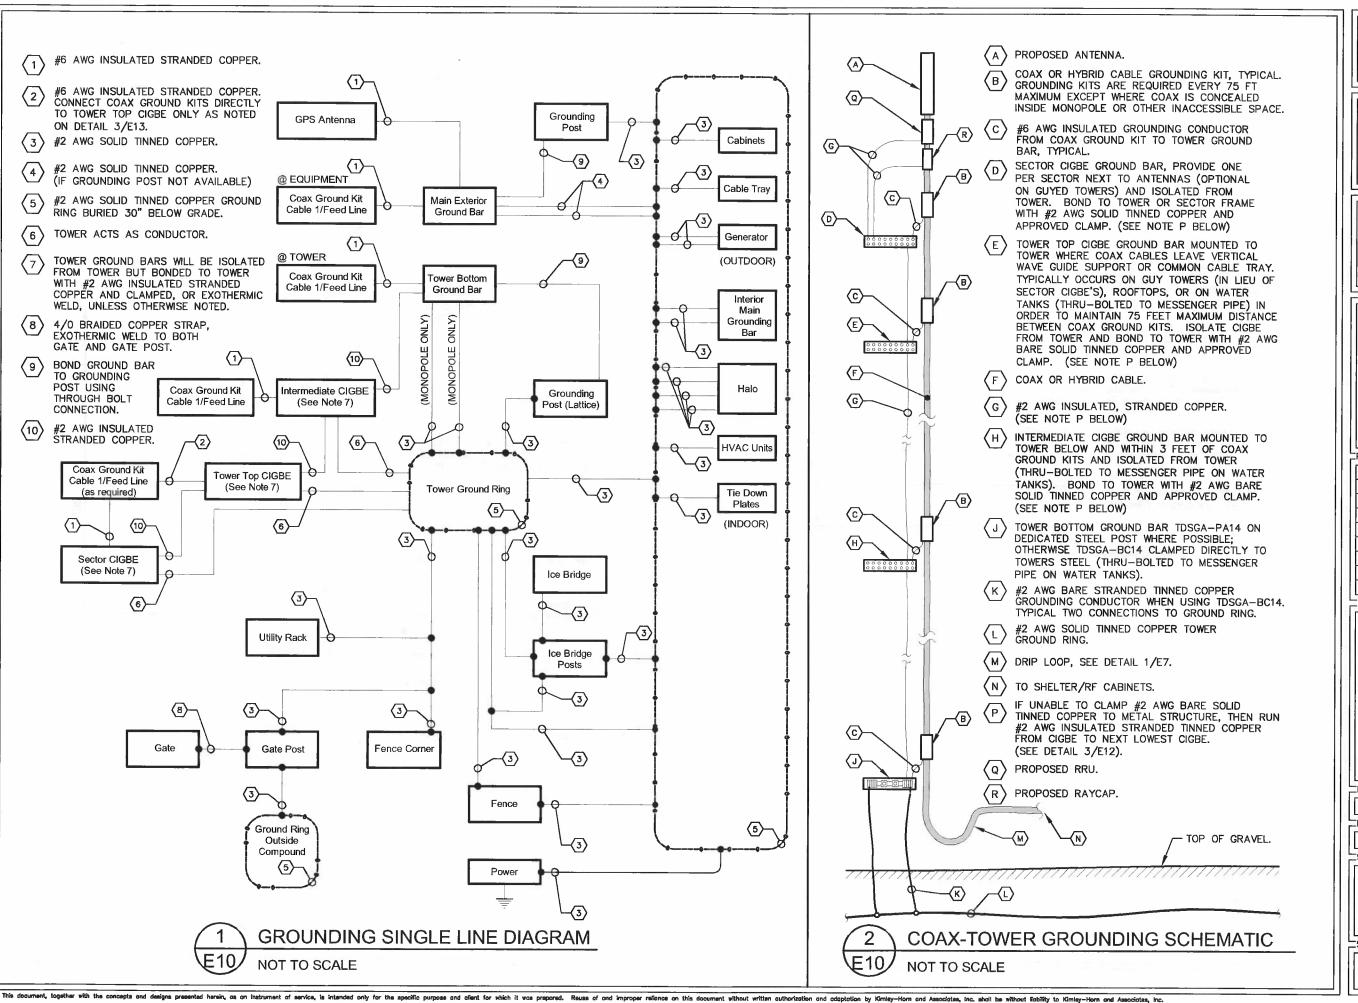
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GROUNDING PLAN

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8921 RESEARCH DRIVE CHARLOTTE, NORTH CAROLINA 28262

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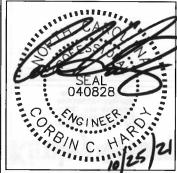
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PLANS PREPARED BY:

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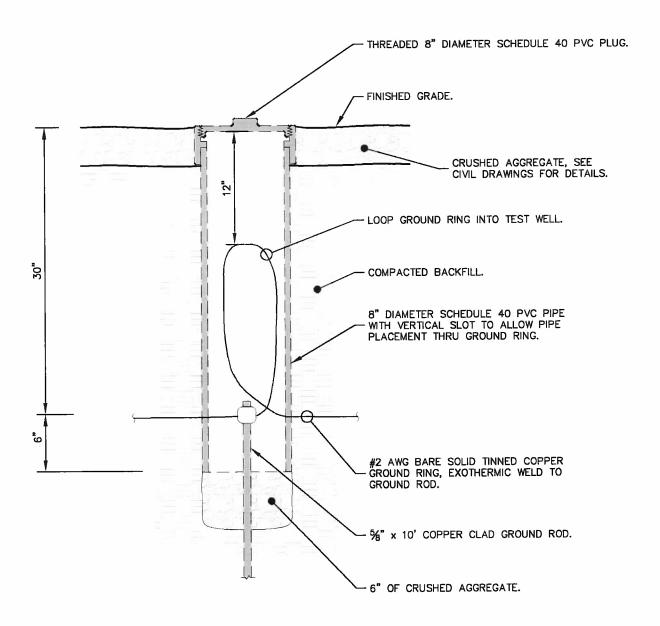
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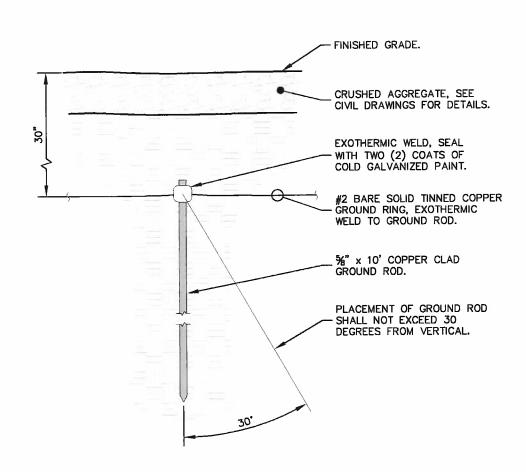
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GROUNDING SINGLE LINE DIAGRAM

SHEET NUMBER:

E10





GROUND ROD TEST WELL DETAIL NOT TO SCALE

GROUND ROD INSTALLATION DETAIL NOT TO SCALE

8921 RESEARCH DRIVE CHARLOTTE, NORTH CAROLINA 28262

PROJECT INFORMATION:


SITE NAME: SWALLOWTAIL SITE No.: 431713 PROJECT #: N/A 452 FARM LIFE SCHOOL RD CARTHAGE, NC 28327 MOORE COUNTY

TPLANS PREPARED BY:

11720 AMBER PARK DRIVE, SUITE 600 ALPHARETTA, CA 30009 PHONE: 770-619-4280 WWKIMLEY-HORN.COM NC License F-0102

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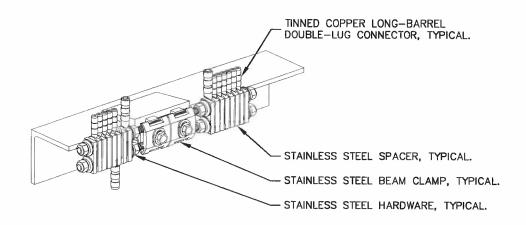
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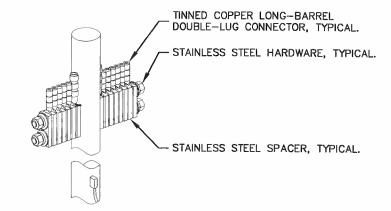
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GROUNDING DETAILS

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E11

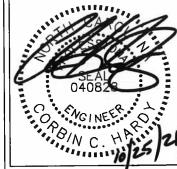




BAR NONE GROUNDED BEAM CLAMP (TDSGA-BC14)

NOT TO SCALE

#6 AWG INCOMING GROUNDING CONDUCTORS FROM COAX GROUNDING KITS. (FOR TOWER TOP CIGBE'S OCCURS ONLY ON GUYED TOWERS, OR ON OTHER STRUCTURES WHERE REQUIRED TO ACHIEVE 75 FT MAXIMUM DISTANCE BETWEEN COAX GROUNDING LOCATIONS.)

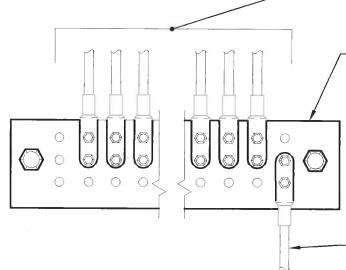

CIGBE GROUND BARS ON ANTENNA TOWER, ISOLATE FROM TOWER.

#2 AWG GROUNDING CONDUCTOR RUN FROM CIGBE TO TOWER USING CLAMP, OR RUN #2 AWG INSULATED GROUNDING CONDUCTOR TO NEXT LOWER CIGBE.

ANTENNA GROUND WIRE INSTALLATION DETAIL

NOT TO SCALE


NOTES:

1. ALL CIGBE GROUND BARS ON TOWER ARE TO BE ERICO TDSGA. TYPICALLY USE TDSGA-WB17 ISOLATED FROM UNISTRUT BRACKET.

2. IF CIGBE CANNOT BE CONNECTED TO TOWER WITH #2 AWG GROUNDING CONDUCTOR, VIA CLAMP OR EXOTHERMIC WELD, THEN RUN #2 AWG BLACK GROUND LEAD FROM CIGBE DOWN TO NEXT LOWER CIGBE. SECURE GROUND LEAD WITH NON-METALIC TIES AT SAME SPACING AS COAX SUPPORTS.

BAR NONE POST MOUNTED (TDSGA-PA14)

NOT TO SCALE

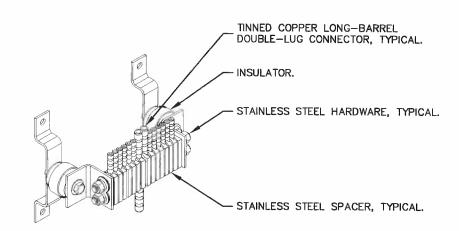

BAR NONE INSULATED (TDSGA-WB17)

NOT TO SCALE

8921 RESEARCH DRIVE CHARLOTTE, NORTH CAROLINA 2826

SITE NAME: **SWALLOWTAIL** SITE No.: 431713 PROJECT#: N/A 452 FARM LIFE SCHOOL RD CARTHAGE, NC 28327 MOORE COUNTY

PLANS PREPARED BY:

PROJECT INFORMATION:

REV: DATE: ISSUED FOR: BY: 6 5 4 3 1 10/11/21 CONSTRUCTION CCH 0 09/07/21 CONSTRUCTION CCH

LICENSER:

KHA PROJECT NUMBER: 013509278

DRAWN BY: CHECKED BY:

SHEET TITLE:

GROUNDING DETAILS

SHEET NUMBER:

sented herein, as on instrument of service, is intended only for the specific purpose and affent for which it was prepared. Reuse of and improper reliance on this document without written authorization

Am

FOR REGISTRATION REGISTER OF DEEDS Judy D. Martin Moore County, No.

March 18, 2019 11:08:17 AM

Book 5101 Page 332-334 FEE: \$26.00 NC REVENUE STAMP: \$700.00 INSTRUMENT # 2019003319



INSTRUMENT # 2019003319

NORTH CAROLINA SPECIAL WARRANTY DEED

Excise Tax: \$700.00	
Parcel Identifier No <u>859600472658</u> , Verified by <u>Moore Cou</u> By:	inty on the day of, 20
Mail to: Diardner H. Altman, Jr. PO Box 459, Selma, North C	Carolina 27576
This instrument was prepared by: Gardner H. Altman, Jr., I TAX ADVICE)	P.A. (NO TITLE CERTIFICATION, TITLE EXAMINATION OR
Brief description for the Index: 444 Farm Life School Road.	, Carthage; 30.9 acres
THIS DEED made this 12th day of March, 2019, by and better	ween
Grantor	Grantee
Teen Challenge Training Center, Inc. a Pennsylvania non-profit corporation PO Box 98 Reheresburg, PA 19550	Adult & Teen Challenge of Sandhills, North Carolina a North Carolina non-profit corporation 444 Farm Life School Road Carthag NC 28388
Enter in appropriate block for each Grantor and Grantee: na corporation or partnership.	ame, mailing address, and, if appropriate, character of entity, e.g.
The designation Grantor and Grantee as used herein shall in singular, plural, masculine, feminine or neuter as required by	aclude said parties, their heirs, successors, and assigns, and shall include y context.
and by these presents does grant, bargain, sell and convey ur	on paid by the Grantee, the receipt of which is hereby acknowledged, has not the Grantee in fee simple, all that certain lot or parcel of land situated hip, Moore County, North Carolina and more particularly described as
See attache	d Exhibit "A"
All or a portion of the property herein conveyed [include:	s or 🔀 does not include the primary residence of a Grantor.
The property hereinabove described was acquired by Granto	or by instrument recorded in Book <u>567</u> , Page <u>07</u> .
TO HAVE AND TO HOLD the aforesaid lot or parcel of lar	nd and all privileges and appurtenances thereto belonging to the Grantee

NC Bar Association Form No. 6 © 1/1/2010 Printed by Agreement with the NC Bar Association And the Grantor covenants with the Grantee, that Grantor has done nothing to impair such title as Grantor received, and Grantor will warrant and defend the title against the lawful claims of all persons claiming by, under or through Grantor, other than the following exceptions:

- 1. Exception is taken to 2019 ad valorem taxes
- 2. Subject to easements, restrictions, conveyances and rights of way of record as of this day of conveyance.
- 3. Exception is taken to all applicable zoning ordinances

IN WITNESS WHEREOF, the Grantor has duly executed the foregoing as of the day and year first above written.

Teen Challenge Training Center, Inc. a Pennsylvania non-profit corporation

RV.

Krstapher I Mchaden, President

State of Jennsylvania, County of Lancasty

Witness my hand and Notarial stamp or seal this 12th day of March 2019.

Notary Public; My Commission Expires: 101/10/2023

Commonwealth of Pennsylvania - Notary Seal Phyllis L. Bireley, Notary Public Lancaster County My commission expires January 10, 2023 Commission number 1194992

Member, Pennsylvania Association of Notaries

Exhibit A to be attached and made part of the deed dated March 12, 2019 from Teen Challenge Training Center, Inc. to Adult & Teen Challenge of Sandhills, North Carolina.

Exhibit A

Moore County (Carthage)

A certain tract of parcel of land in Carthage Township, Moore County, North Carolina, fronting on the west side of State Road No. 1832 about 0.40 miles southwest of its intersection with State Road No. 1805 and bounded on the south by an 11.05 acres tract, on the southwest by McDonald, and on the north by Dunhams Creek, and beginning at a PK nail in the centerline of a bridge over Dunhams Creek, said bridge being on State Road No. 1832 about 0.40 miles southwest of its intersection with State Road No. 1805, running thence from the beginning as the centerline of State Road No. 1832 the following chords; South 41 degrees, 12 minutes West 155.29 feet to a PK nail; South 31 degrees 56 minutes West 136.71 feet to a PK nail; South 20 degrees, 28 minutes West 156.13 feet to a PK nail; South 12 degrees, 35 minutes West 163.39 feet to a PK nail; South 3 degrees, 30 minutes West 141.96 feet to a PK nail; South 5 degrees 55 minutes East 128.88 feet to a PK nail; South 14 degrees 24 minutes East 156.82 feet to a PK nail; South 19 degrees 50 minutes East 203.32 feet to a PK nail; South 15 degrees 50 minutes East 125.39 feet to a PK nail in the centerline of State Road No. 1832, the northeast corner of an 11.05 acres tract; thence as the north line of said 11.05 acres tract, South 88 degrees, 00 minutes West 1239.78 feet to an iron bar in a lake, said iron bar being near the west bank of said lake and having an oak pointer, said iron bar also common corner with Catawba Timber Co., McDonald and the aforementioned 11.05 acres tract; thence a common line with McDonald, North 39 degrees, 30 minutes West 276.75 feet to an iron pipe with poplar and oak pointers in the McDonald line; thence along a marked line, North 19 degrees, 14 minutes East 874.09 feet to an iron pipe in the centerline of Dunhams Creek; thence down the run of Duhams Creek the following chords; North 46 degrees, 41 minutes East 148.72 feet; South 61 degrees, 39 minutes East North 120.26 feet; North 69 degrees, 04 minutes East 97.66 feet; South 89 degrees 39 minutes East 190.34 feet; South 76 degrees 53 minutes East 110.09 feet; North 51 degrees 25 minutes East 150.78 Feet; North 52 degrees, 45 minutes East 131.48 feet; North 42 degrees 06 minutes

Agenda Item: _____ Meeting Date: April 7, 2022

MEMORANDUM TO THE PLANNING BOARD

FROM: Debra Ensminger

Planning and Inspections Director

DATE: March 3, 2022

SUBJECT: General Use Rezoning Request: Residential & Agricultural-40 (RA-

40) & to Highway Business (B-2) - NC 73 Highway

PRESENTER: Jaimie Walters

REQUEST

Southern Golf & Land, LLC is requesting a General Use Rezoning from Residential and Agricultural-40 (RA-40) to Highway Commercial (B-2) of one parcel of approximately 2.49 acres located on NC 73 Highway, owned by Southern Golf & Land, LLC, per Deed Book 5604 Page 221 and further described as ParID 00021818 in Moore County Tax Records.

Public notification consisted of publishing a legal notice in the local newspaper for two consecutive weeks, notification by mail to adjacent property owners, and placing public hearing signs on the property.

BACKGROUND

The subject property currently has a single-family residence located on it. The property is located within the Urban Transition portion of the Highway Corridor Overlay District. Adjacent properties include single family dwellings, manufactured homes, a church and commercial businesses.

The parcel is within a half-mile of a Voluntary Agricultural District. The parcel is within the Little River (CPF) WS-IIIP watershed (24% limited built upon area; up to 70% with SNIA) and the High-Quality Water area. This area is part of NCDOT STIP Project R-5726 and will be part of future right-of-way acquisition, with construction scheduled to start in 2025 (see attached map).

ZONING DISTRICT COMPATIBILITY

The requested rezoning to Highway Commercial (B-2) is consistent with the existing uses located near the property, including commercial and industrial uses. The surrounding area is zoned Residential & Agricultural-20 (RA-20), Residential & Agricultural-40 (RA-40), Highway Commercial (B-2) and Industrial (I).

CONSISTENCY WITH THE 2013 MOORE COUNTY LAND USE PLAN

The future land use map identifies the property as the Commercial/Office/Retail/Institutional Classification. The requested rezoning to Highway Commercial (B-2) is compatible with the


Commercial/Office/Retail/Institutional Land Use Classification as the B-2 district will permit the desired uses to support the surrounding areas.

The Land Use Plan states the Commercial/Office/Retail/Institutional Classification's primary use of the land includes shopping/retail uses, dining, entertainment, services, general office space, medical offices, banks, schools, daycares, places of worship, libraries, etc.

The Moore County Unified Development Ordinance states the Highway Commercial (B-2) district provides for the development of commercial and service centers that serve community, countrywide, or regional commercial needs, are accessible by residents from surrounding neighborhoods, and are of such nature so as to minimize conflicts with surrounding residential areas.

The rezoning request aligns with the following recommendation as included in the attached Land Use Plan Consistency Statement, including Action 1.8.5: Support and promote infill development that will optimize the use of existing infrastructure; and Action 3.1.2: Encourage non-residential development to locate near major transportation routes and areas served by adequate water, sewer, natural gas, broadband, and electric power.

MOORE COUNTY FUTURE LAND USE MAP

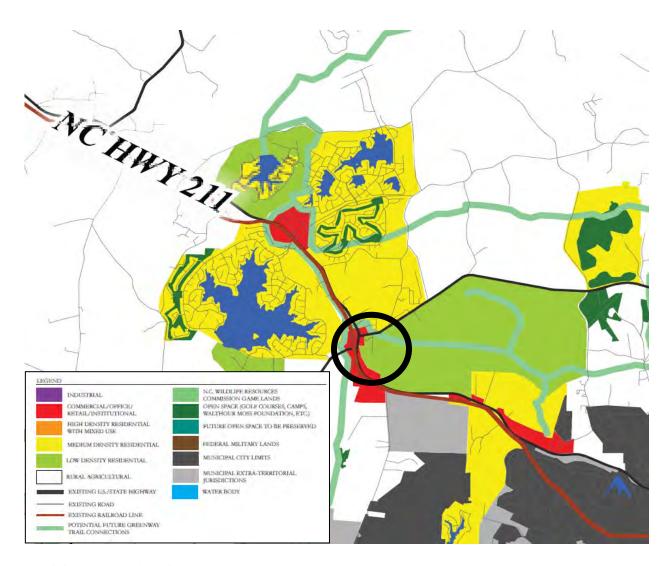

RECOMMENDATION

Staff recommends the Moore County Planning Board make two separate motions:

Motion #1: Make a motion to adopt the attached **Approval** or **Denial** Moore County Planning Board Land Use Plan Consistency Statement and authorize its Chairman to execute the document as required by North Carolina General Statute 160D-604.

Motion #2: Make a motion to recommend **Approval** or **Denial** to the Moore County Board of Commissioners of the General Use Rezoning from Residential and Agricultural-40 (RA-40) to Highway Commercial (B-2) of one parcel of approximately 2.49 acres located on NC 73 Highway, owned by Southern Golf & Land, LLC, per Deed Book 5604 Page 221 and further described as ParID 00021818 in Moore County Tax Records.

ATTACHMENTS

- Pictures of Property and Adjacent Properties
- Vicinity Map
- Land Use Map
- Rezoning Map
- Planning Board Consistency Statement Approval
- Planning Board Consistency Statement Denial
- Submitted Rezoning Application
- UDO Chapter 6. Table of Uses
- Deed Book 5604 Page 221

View of subject property- 4020 NC 73 Highway





NC 73 Highway – General Use Rezoning – Staff Report

Adjacent property – 4015 NC 73 HWY




Adjacent property – 5307 NC 211 HWY



NC 73 Highway – General Use Rezoning – Staff Report


Adjacent property – 3985 NC 73 HWY



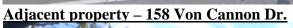





NC 73 Highway – General Use Rezoning – Staff Report

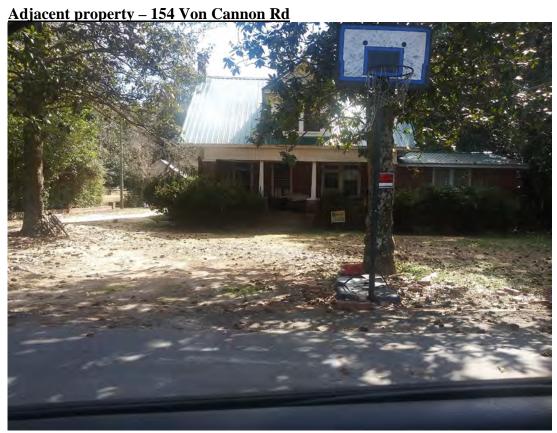




NC 73 Highway – General Use Rezoning – Staff Report

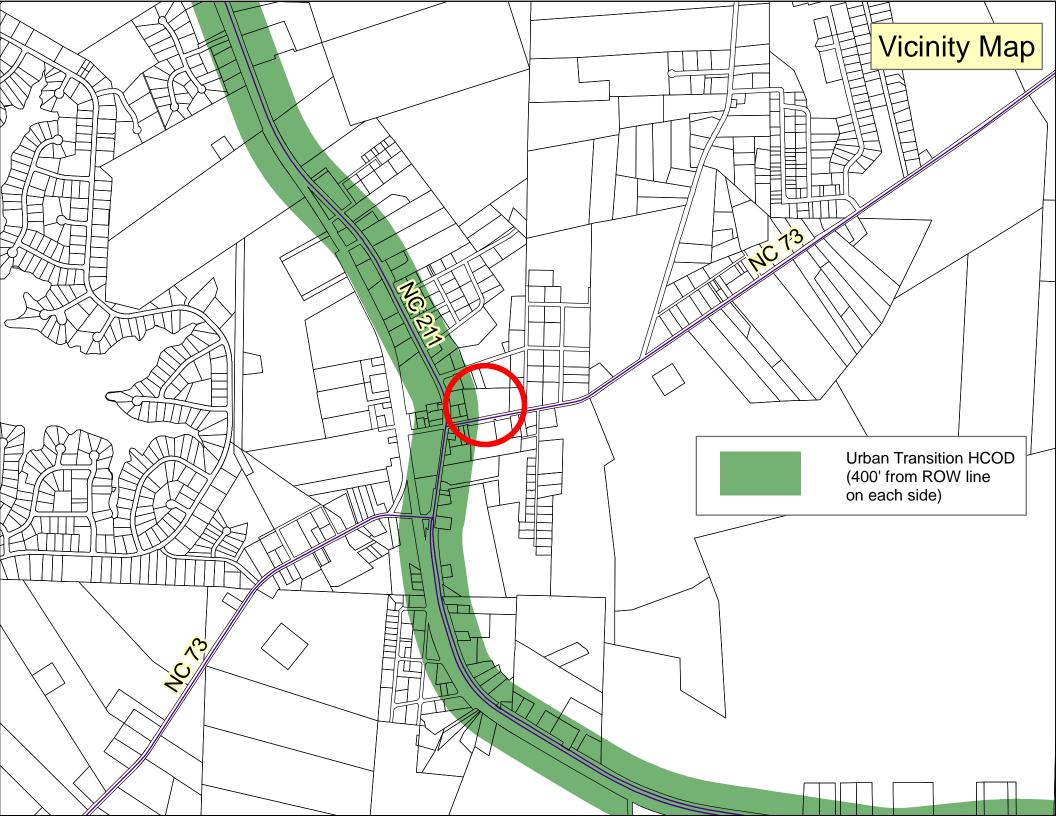

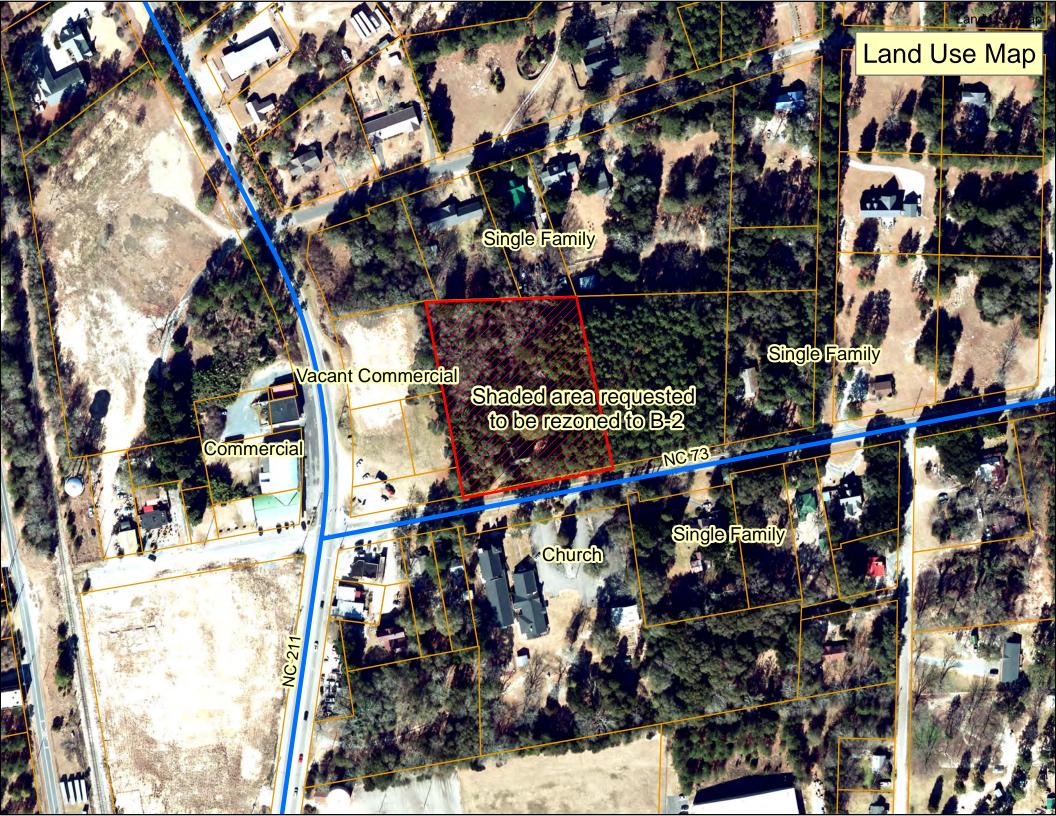

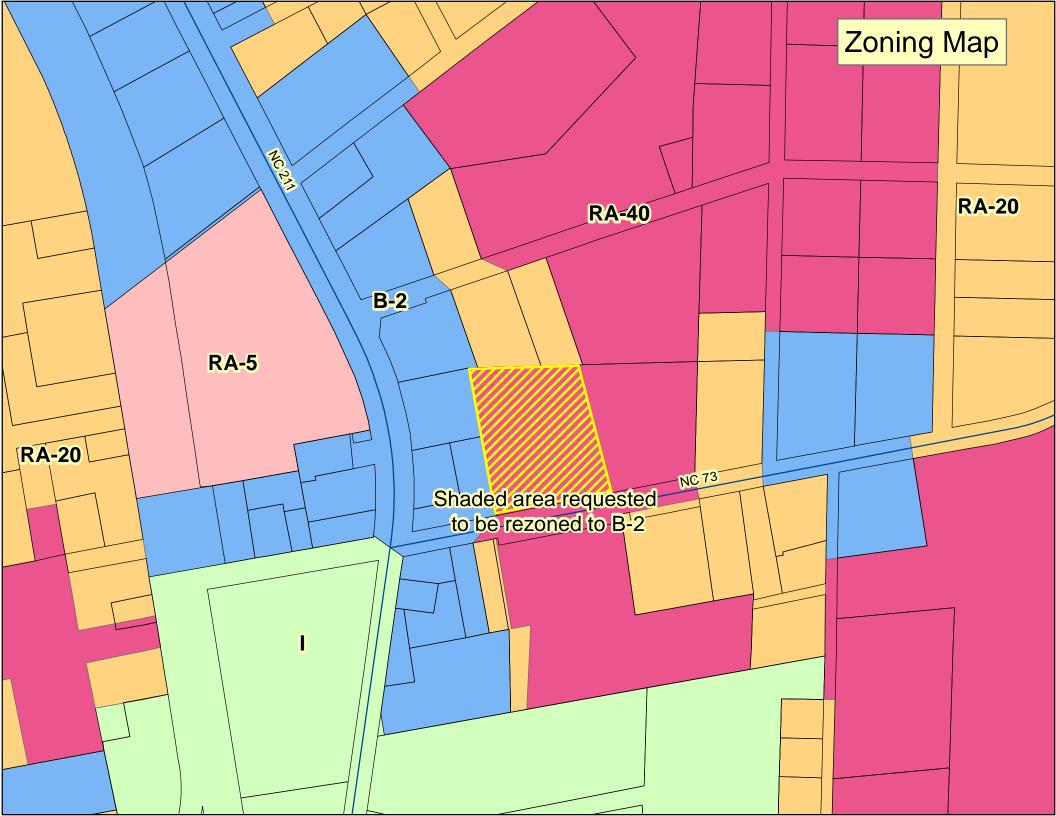

Moore County Planning Board Land Use Plan Consistency Statement

General Use Rezoning Request Residential & Agricultural-40 (RA-40) to Highway Commercial (B-2)

The Moore County Planning Board finds that:

1. The rezoning request is consistent with the following goals as listed in the 2013 Moore County Land Use Plan:

Goal 1: Preserve and Protect the Ambiance and Heritage of the County of Moore (inclusive of areas around the municipalities)

• Action 1.8.5: Support and promote infill development that will optimize the use of existing infrastructure; and

Goal 3: Maximize accessibility among living, working, and shopping areas

- Action 3.1.2: Encourage non-residential development to locate near major transportation routes and areas served by adequate water, sewer, natural gas, broadband, and electric power.
- 2. The rezoning request is reasonable and in the public interest considering the property is located adjacent to an existing road with no outlet and the requested zoning district will remain in harmony with surrounding zoning.

Therefore, the Moore County Planning Board recommends **APPROVAL** of the General Use Rezoning from Residential and Agricultural-40 (RA-40) to Highway Commercial (B-2) of one parcel of approximately 2.49 acres located on NC 73 Highway, owned by Southern Golf & Land, LLC, per Deed Book 5604 Page 221 and further described as ParID 00021818 in Moore County Tax Records.

Joe Garrison, Chair	Date	
Moore County Planning Board		

Moore County Planning Board Land Use Plan Consistency Statement

General Use Rezoning Request Residential & Agricultural-40 (RA-40) to Highway Commercial (B-2)

The Moore County Planning Board finds that:

1. The rezoning request is consistent with the following goals as listed in the 2013 Moore County Land Use Plan:

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• Action 1.8.5: Support and promote infill development that will optimize the use of existing infrastructure; and

Goal 3: Maximize accessibility among living, working, and shopping areas

- Action 3.1.2: Encourage non-residential development to locate near major transportation routes and areas served by adequate water, sewer, natural gas, broadband, and electric power.
- 2. The proposed rezoning is not reasonable and not in the public interest because the proposed rezoning will have an unreasonable impact on the surrounding community.

Therefore, the Moore County Planning Board recommends **DENIAL** of the General Use Rezoning from Residential and Agricultural-40 (RA-40) to Highway Commercial (B-2) of one parcel of approximately 2.49 acres located on NC 73 Highway, owned by Southern Golf & Land, LLC, per Deed Book 5604 Page 221 and further described as ParID 00021818 in Moore County Tax Records.

Joe Garrison, Chair	Date	
Moore County Planning Board		




County of Moore Planning and Inspections


Inspections/Permitting: (910) 947-2221

Planning: (910) 947-5010 Fax: (910) 947-1303

GENERAL USE REZONING APPLICATION

Applicant: SOUTHERN GOLF AND LAND, LLC Phone:						
City: PINE	hest !	St: MC	Zip: 28374			
	F	Phone: 👭	0.986-0401			
City: PINEX	NPST S	St: NC	Zip: 28374			
Proposed Zoni	ng District:	-2				
I (We), the undersigned, certify that all statements furnished in this application are true to the best of my (our) knowledge, and do hereby agree to follow all reasonable requests for information as designated by the County of Moore Zoning Administrator.						
Dale						
Date						
Ap	p# 38702	2				
	City: Proposed Zoning Shed in this appropriate Proposed Zoning Shed in the proposed Zoning Shed in the proposed Zoning Shed in this appropriate Date	City: PINEMURST City: PINEMURST Proposed Zoning District: Shed in this application are tronable requests for information 2/21/2022 Date Date	City: PINENDEST St: NC Phone: 11 City: PINENDEST St: NC Proposed Zoning District: B-2 shed in this application are true to the onable requests for information as design 2/21/2022 Date			

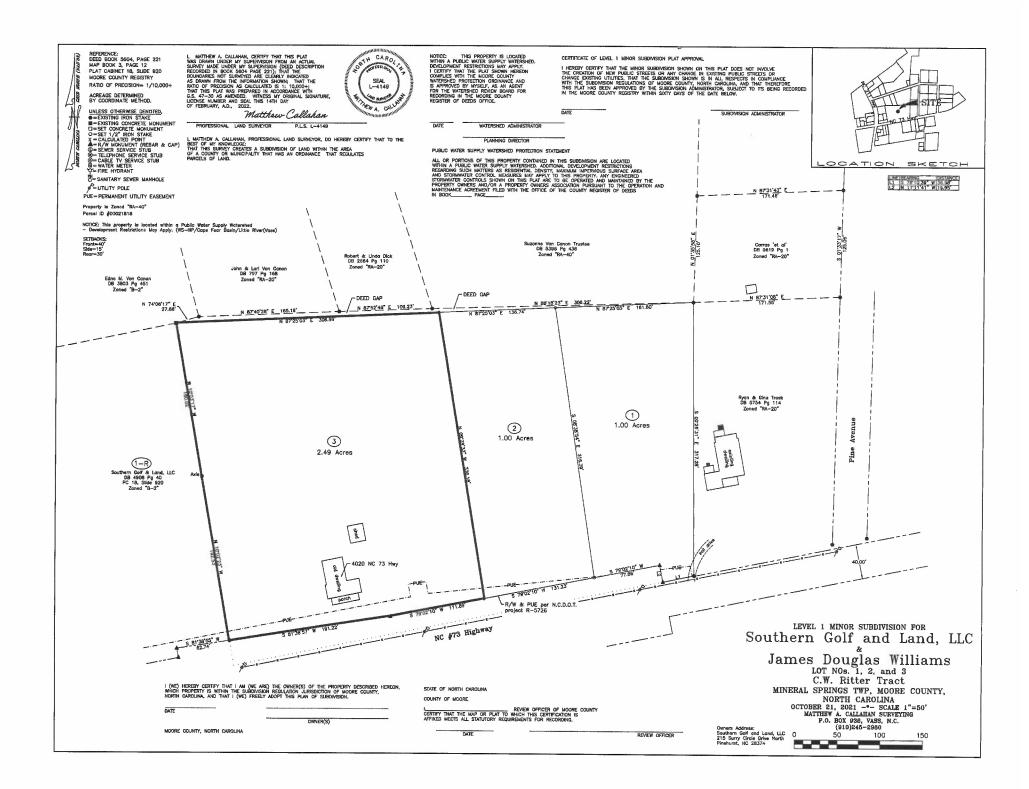

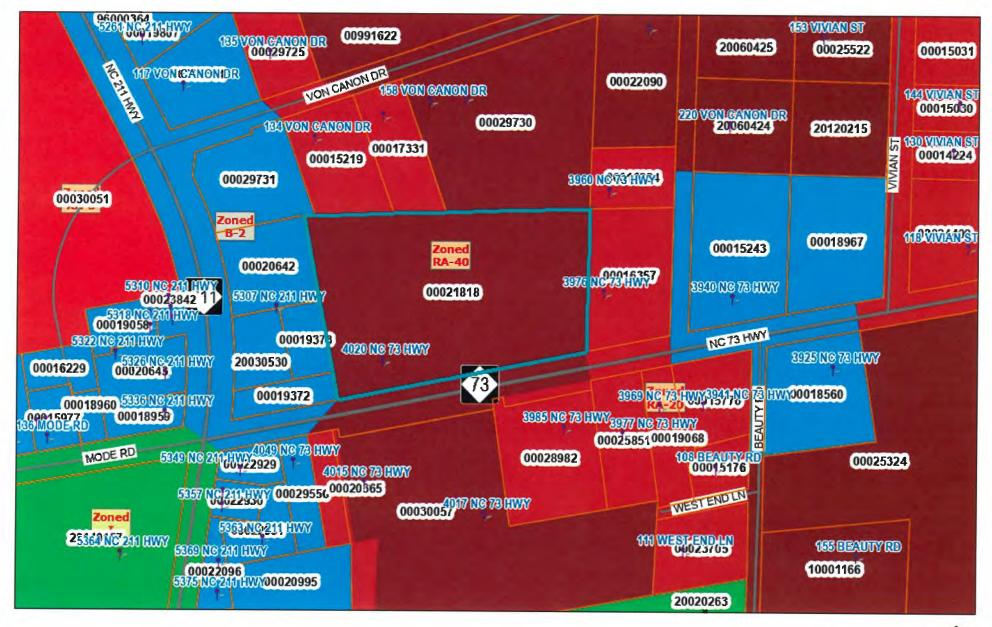

1 inch = 200 feet February 21, 2022




Name: SOUTHERN GOLF AND LAND, LLC

Parcel ID: 00021818

Deeded Acres: 4.9

0 90 180 360 Feet

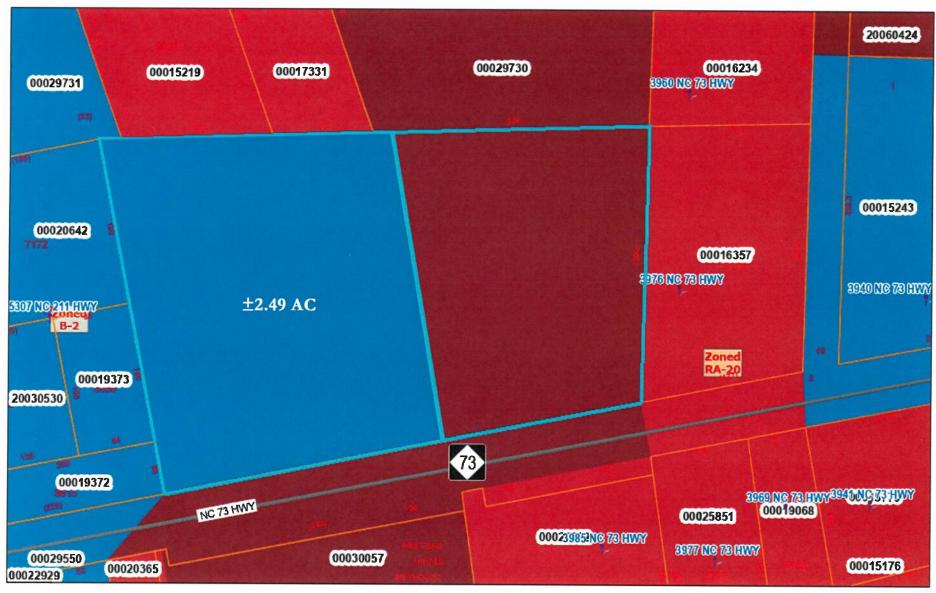


Name: SOUTHERN GOLF AND LAND, LLC

Parcel ID: 00021818

Deeded Acres: 4.9

1 inch = 100 feet February 21, 2022



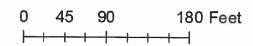

CHAPTER 6 TABLE OF USES

6.1 Use Table

- A. <u>Permitted Uses</u>. P = Permitted uses are a use-by-right approved by the Administrator.
- B. <u>Conditional Uses</u>. C = Conditional Use Permit approval required. (Refer to Chapter 12.)
- C. <u>Conditional Zoning</u>. Z = Conditional Rezoning within a parallel conditional zoning district required. (Refer to Chapter 11.)
- D. Building Code Classification.

The "Bldg. Code Group" column is intended for reference purposes only and is subject to change without notice. Classifications should be verified by the Building Inspector and should follow the regulations of the applicable "Use & Occupancy Classification" per the 2012 NC Building Code. Change of uses will require sealed plans to be approved by the Building Inspector.

A = Assembly	M = Mercantile		
B = Business	R = Residential		
E = Education	S = Storage		
F = Factory Industrial	U = Utility & Miscellaneous		
H = Hazardous	Mix = Mixed Uses (Separation		
I = Institutional	standards may apply)		

- E. <u>Prohibited Uses</u>. Blank = Districts in which particular uses are prohibited, unless the Administrator determines that the use is similar to an allowed individual use by applying the following criteria:
 - 1. The actual or projected characteristics of the activity.
 - 2. The relative amount of site area or floor space and equipment utilized.
 - 3. Relative amounts of sales from the activity and costumer type for the activity.
 - 4. The relative number of employees and hours of operation.
 - 5. Building and site arrangement and likely impact on surrounding properties.
 - Types of vehicles used, parking requirements, and vehicle trips generated.

When uncertainty exists, the Administrator, after consultation with the County Attorney, shall be authorized to make the interpretation.

ACCESSORY USES & ACCESSORY BUILDINGS	RA-20	RA-40	RA-2	RA-5	GCSL	GCWL	RE		RA	P-C	VB	B-1	B-2		Specific Use Standards	Bldg. Code Group
Accessory Uses & Buildings	P	P	P	P	P	P	P	P	Р	P	Р	Р	P	P	8.1	R, S, U

AGRICULTURAL USES	RA-20	RA-40	RA-2	RA-5	CCSL	GCWL	RE	RA-USB	RA	P-C	VB	B-1	B-2	I	Specific Use Standards	Bldg. Code Group
Agricultural Uses and Buildings (Not a Bona Fide Farm)	Р	P	Р	Р	Р	Р	Р	P	Р	Р	P	Р	P	Р	8.2	U
Bona Fide Farm									on s lanı						8.3	S, U

RESIDENTIAL USES	RA-20	RA-40	RA-2	RA-5	CCSL	GCWL	RE	RA-USB	RA	P-C	VB	B-1	B-2	I	Specific Use Standards	Bldg. Code Group
SII	NGL	E F.	ΑM	ILY	но	US	ЕНС	DLD)							
Accessory Dwelling Located within Stick Built Dwelling	P	P	P	P			P	P	P						8.4	R
Accessory Dwelling Located within Non- Residential Building											P	P	P		8.5	Mix
Accessory Manufactured Home	P	P	P	Р			P	Р	P						8.6	R
Accessory Stick Built Dwellings	P	P	P	P			P	P	P						8.7	R
Dwellings, Single Family	P	P	P	Р	P	P	P	Р	P						8.8	R-3
Dwellings, Duplexes	P	P				P	P								8.9	R-3
Family Care Home (6 or less)	P	P	P	Р	P	P	P	Р	Р						8.10	I, R
Home Occupation, Level 1	P	P	P	P	P	P	P	P	P						8.11	R
Home Occupation, Level 2			Z	Z			Z		Z						8.12	R
Manufactured Home	P	P	P	P			P	P	P						8.13	R-3
Manufactured Home Park									Z						8.14	Mix
Personal Workshop / Storage Building	P	P	P	P			P	P	P						8.15	R, S
Planned Unit Development – Mixed Use		Co	ndit	iona	al Re	ezor	ing	to I	UD	-CZ	is r	equ	ired		8.16	Mix
MULTIFAMILY RESIDENTIAL																
Group Care Facility									Z			С	P		8.17	I, R
Multifamily Dwellings (3 or more units per lot)		Co	ndit	iona	al Re	ezor	ning	to I	ΛF-(CZ i	s re	quir	ed.		8.18	R-2
Nursing Home	С	C	С	С					С			Р	P		8.19	В, І

COMMERCIAL USES	RA-20	RA-40	RA-2	RA-5	CCSL	GCWL	RE	RA-USB	RA	P-C	VB	B-1	B-2	I	Specific Use Standards	Bldg. Code Group
	A	NI	MA	L SI	ERV	ICE	S									
Animal Shelter									Z					Р	8.20	В
Animal Training Facility, Military									Z					Р	8.21	В
Kennels, Overnight									Z			Z	Z	Р	8.22	В
Pet Day Care, Grooming, Obedience Training									Z		Р	P	P		8.23	В
Veterinary Clinic							Р		Z		Р	P	P		8.24	В
OFI	FICE	S &	GE	ENE	RAI	. SE	RV]	ICES	S							
Automatic Teller Machine (ATM)											P	P	P	P	8.25	U
Beauty / Barber Shop / Nail Salon						Р					Р	P	P		8.26	В
Bed and Breakfast	Z	Z	Z	Z				Z	Z						8.27	
Dry Cleaning and Laundromat						Р					Р	P	P	Р	8.28	В
Equestrian Cottage							Z								8.29	
Hotel and Motel													P		8.30	R-1
Office											Р	P	P	Р	8.31	В
Small Appliance Repair Shop											Р	P	P	Р	8.32	В
Trade Contractor Office and Workshop											Р	Z	P	Р	8.33	B, S
COMMERCIAL USES	RA-20	RA-40	RA-2	RA-5	CCSL	GCWL	RE	RA-USB	RA	P-C	VB	B-1	B-2	I	Specific Use Standards	Bldg. Code Group
	I	RET	ΊΑΙΙ	L SE	RVI	CES	S									
Auction House												P	P	Р	8.34	A-3, B
Convenience Store						Р			С		Р	P	P	Р	8.35	M
Feed and Seed Sales							С		С			P	P	P	8.36	В, М
Florist									Р		Р	Р	P	Р	8.37	В
Flea Market									Z			Z	P		8.38	B, M
Garden Center											Р	Р	P		8.39	M, U
Manufactured or Modular Home Sales													P	Р	8.40	В
Restaurant						Р			\Box		Р	P	P	Р	8.41	A-2
Retail						\Box			\Box		Р	P	P		8.42	M
Shopping Centers													Z	С	8.43	M
Wholesales											С		P	Р	8.44	M

COMMERCIAL USES (CONTINUED)	RA-20	RA-40	RA-2	RA-5	CCSL	GCWL	RE	RA-USB	RA	P-C	VB	B-1	B-2	I	Specific Use Standards	Bldg. Code Group
	V	EHI	[CL]	E SE	ERV	ICE	ES									
Boat & RV Storage					P						Z		Z		8.45	S-1
Car Wash or Auto Detailing											Р	P	P	Р	8.46	В
Commercial Truck Wash												С	P	Р	8.47	В
Parking Lot as principal use of lot											Р	P	P	Р	8.48	S-2
Taxi Service												Z	P	P	8.49	В, А-3
Vehicle, Auto Parts, Tires, Farm Equipment, Boat, RV - Sales, Rental, or Service											Р	Р	P	Р	8.50	B, S-1
Vehicle Service Stations (Gas Stations)											Z	P	P	P	8.51	M
Vehicle Wrecker Service												Z	Z	P	8.52	S-1
		A	DU	LT I	USE	S										
Adult Gaming Establishments														С	8.53	В
Bars / Tavern											С		P		8.54	A-2
Brewery / Winery									С		P		P	P	8.55	A-2, F
Dance Club, Night Club, Billiard											Z		P		8.56	A-2, A-3
Distillery														P	8.57	F-1
Massage & Bodywork Therapy Practice											Р	P	P	Р	8.58	В
Pawn Shop											Z		P	Р	8.59	В
Sexually Oriented Business														Z	8.60	A-2, M
Tattoo Parlor, Body Piercing													P		8.61	В

EDUCATIONAL & INSTITUTIONAL USES	RA-20	RA-40	RA-2	RA-5	CCSL	GCWL	RE	RA-USB	RA	P-C	VB	B-1	B-2	I	Specific Use Standards	Bldg. Code Group
Cemetery or Mausoleum, Commercial			С	С			С		С			P			8.62	n/a
Cemetery, Family	Р	P	P	P	Р	Р	Р	Р	Р						8.63	n/a
Child Care Facility	С	C	С	P		С	С	С	С		С	P	P		8.64	E, I
Child Care Home Facility	С	P	Р	Р			С	С	Р						8.65	E, R
Colleges, Business & Trade Schools									С				P	Р	8.66	В
Funeral Home, accessory crematorium											Р	P	P	Р	8.67	A-3, B
Government Facility	Р	P	Р	Р	P	Р	Р	Р	Р	Р	Р	Р	P	Р	8.68	В
Hospital	Р	P	Р	Р	С	С	Р	Р	Р	Р		Р	P	Р	8.69	I
Museums and Art Galleries									С		Р	Р	P		8.70	A-3
Religious Institutions	Р	P	Р	Р	Р		Р	Р	Р	Р	Р	Р	P		8.71	A-3, E
Security Training Facility									С						8.72	В
Schools, Elementary, Middle, High												Р	P		8.73	E

RECREATIONAL USES	RA-20	RA-40	RA-2	RA-5	CCSL	GCWL	RE	RA-USB	RA	P-C	VB	B-1	B-2	I	Specific Use Standards	Bldg. Code Group
Accessory, Swimming Pool	P	P	P	P	P	Р	Р	P	P	P	Р	Р	P	P	8.74	A, R
Airport, Public or Private									C					Z	8.75	A-3, B
Airstrip, Small Private									C			Р			8.76	В
Assembly Hall						Z			Z		Z		Z	P	8.77	A-4, A-5
Camp or Care Centers									P						8.78	A-3, R-1
Campground, Public and Private									P						8.79	A-3, R-1
Camp, Recreation Day									P						8.80	A-3
Civic / Social Club, Lodge, & Organization			P	Р	С	С			C		Р	P	P		8.81	A-2, A-3
Golf Driving Range					С	С				Р			P		8.82	A-3
Golf Course, including Par 3					С	С				P			P		8.83	U
Marina (fuel supplies)					P	Р									8.84	M
Neighborhood Park	P	P	P	Р	P	Р	Р	P	P	Р	Р	P	P		8.85	U
Recreation, Indoor											С	С	P		8.86	A-5
Recreation, Low Impact Outdoor		P P	Р	Р	Р	Р	Р	Р	Р		С	P	P		8.87	A-5
Recreation, High Impact Outdoor									Z		Z		P		8.88	
Shooting Range, Indoor									Z				P		8.89	A-5
Shooting Range, Outdoor									Z				P		8.90	A-5
Zoo, Petting Zoo									Z				P		8.91	A-5, U

INDUSTRIAL USES	RA-20	RA-40	RA-2	RA-5	CCSL	GCWL	RE	RA-USB	RA	P-C	VB	B-1	B-2	I	Specific Use Standards	Bldg. Code Group
		PI	ROI	OUC	CTIC	N										
Manufacturing & Sales, Pottery									P		P	P	P	P	8.92	F
Manufacturing, Light (no odors, no smoke)														Р	8.93	F
Manufacturing, General														Z	8.94	F-1, F-2
	UT	TILI	TIE	S/S	SER	VIC	ES									
Amateur Radio and Receive-only Antennas	P	P	P	P	P	Р	Р	Р	Р	P	Р	Р	P	Р	8.95	U
Contractors Storage Yard and Office									Z				P	Р	8.96	S-1, U
Crematorium Facility													Z	Р	8.97	В
Public & Private Utility Facilities	P	P	Р	Р	Р	Р	Р	Р	Р	Р	Р	Р	P	Р	8.98	U
Solar Collector Facility														С	8.99	U
Solar Collectors, On-Site Use	P	P	Р	Р	Р	Р	Р	Р	Р	Р	Р	Р	P	Р	8.100	U
									Z				Z	Z	8.101	
Wireless Communication Facility															8.101	U

INDUSTRIAL USES	RA-20	RA-40	RA-2	RA-5	CCSL	GCWL	RE	RA-USB	RA	P-C	VB	B-1	B-2	I	Specific Use Standards	Bldg. Code Group
		WA	RE	НО	USI	NG										
Mini-Warehouse (Self-Service)						P					Z	Z	Z	Z	8.103	S
Warehousing and/or Distribution Center									Z				C	Р	8.104	S-1, S-2
v	VAS	ΓE R	RELA	ATE	D S	ERV	VIC	ES								
Debris Management Facility									Z			Z		P	8.105	U
Hazardous Waste /Toxic Chemicals Disposal or Processing														С	8.106	U
Landfill														С	8.107	U
Mining / Quarry Operation									Z					С	8.108	U
Salvage Yard														С	8.109	U

TEMPORARY USES	RA-20	RA-40	RA-2	⋖	CCSL	GCWL	RE	RA-USB	RA	P-C	VB	B-1	B-2	I	Specific Use Standards	Bldg. Code Group
Construction Office, Temporary	P	P	P	P	P	P	P	Р	Р	Р	P	Р	P	P	8.110	S-1
Drop-In Child Care Facility											Р	Р	P		8.111	
Itinerant Merchant											Р	P	P	P	8.112	n/a
Land Clearing	Р	P	P	P	P	P	Р	Р	Р	P	Р	Р	P	P	8.113	F-1
Manufactured Home or RV, Temporary	P	P	P	P			Р	Р	Р						8.114	R-3
Real Estates Office, Temporary	P	P	P	P	P	P	Р	Р	Р	Р	Р	P	P	P	8.115	S-1
Temporary Events (Special Event)	Р	P	P	P	Р	Р	Р	Р	Р	Р	P	P	P	Р	8.116	n/a
Yard Sales, Residential and Civic	P	P	Р	P	Р	Р	Р	Р	Р			P	P		8.117	n/a

OTHER USES	RA-20	RA-40	RA-2	RA-5	CCSL	GCWL	RE	RA-USB	RA	P-C	VB	B-1	B-2	I	Specific Use Standards	Bldg. Code Group
Major Subdivision – Residential (1)	С	C						C							18.6-18.11	Mix
Major Subdivision – Non-Residential (Business Park)													C	С	18.6-18.11	Mix

For Registration Register of Deeds

Judy D. Martin

Moore County, NC Electronically Recorded

April 30, 2021 9:36:21 AM

Book: 5604 221 - 224 Page:

#Pages: 4

Fee: \$26.00

NC Rev Stamp: \$245.00

Instrument# 2021010133

SPECIAL WARRANTY DEED

THIS INSTRUMENT PREPARED BY:

John Hall Greenbacker, Esq. Lorenz & Creed Law Firm, PLLC 230 N. Bennett Street Southern Pines, NC 28387

> TO BE RECORDED IN THE DEED RECORDS OF MOORE COUNTY, NO

Excise Tax: \$ 245.00 oril THIS DEED made this 2021, by and between: **GRANTOR** GRANTEE TRUIST BANK F/K/A BRANCH BANKING SOUTHERN GOLF & LAND, LLC, a North Carolina Limited Liability Company

AND TRUST COMPANY, AS TRUSTEE OF THE MARY R. LEWIS REVOCABLE TRUST **U/A/D SEPTEMBER 13, 1979**

WITNESSETH:

Tax address:

215 Surry Circle Drive North Pinehurst, NC 28374

The designation Grantor and Grantee as used herein shall include said parties, their heirs, successors, and assigns, and shall include singular, plural, masculine, feminine or neuter as required by context.

WITNESSETH, the Grantor, for valuable consideration paid by the Grantee, the receipt of which is hereby acknowledged, has and by these presents does grant, bargain, sell and convey unto the Grantee in fee simple, all that certain lot or percel of land (referred to in the singular, whether one or more) situated in Moore County, North Carolina, and more particularly described as follows:

See Exhibit "A" attached hereto and incorporated herein by reference for a description of the real property hereby conveyed. The real property described an Exhibit "A" attached hereto is hereby incorporated herein by reference to the same extent as if set forth herein in its entirety.

Submitted electronically by "Lorenz & Creed Law Firm PLLC" in compliance with North Carolina statutes governing recordable documents and the terms of the submitter agreement with the Moore County Register of Deeds.

This property herein described does not include the primary residence of the Grantor.

And being the same property conveyed to Grantor in instrument recorded in Book 92, Page 649, in the Moore County, North Carolina, Register of Deeds. The attorney preparing this instrument has not searched the title to the real property hereby conveyed and makes no opinion relative to the status of the title to the real property hereby conveyed.

This conveyance is made subject to (i) the lien of the County of Moore for taxes and other assessments for the current year, which taxes or other assessments shall be pro-rated as of the date of closing and which Grantee by acceptance of this deed expressly agrees to pay; (ii) utility easements of record; and (iii) unviolated restrictive covenants of record that do not materially affect the value of the property.

TO HAVE AND TO HOLD the aforesaid lot or parcel of land and all privileges and appurtenances thereto belonging to the Grantee in fee simple.

And the Grantor covenants with the Grantee, that Grantor has done nothing to impair such title as Grantor received, and Grantor will warrant and defend the title against the lawful claims of all persons claiming by, under or through Grantor, other than the exceptions hereinabove set forth.

(remainder of page intentionally left blank)

(signature and notary acknowledgement to follow)

IN WITNESS WHEREOF, the said Grantor has hereunto set their hand and seal the day and year first
above written.
MAN St + Hh (SEAL)
MICHAEL SCOTT BALKCUM, VICE PRESIDENT, WEALTH DIVISION OF BRANCH
BANKING AND TRUST COMPANY N/K/A TRUIST BANK, AS TRUSTEE OF THE MARY R
LEWIS REVOCABLE TRUST U/A/D SEPTEMBER 13, 1979
STATE OF MC
STATE OF
COOKIT OF THE PARTY OF THE PART
I certify that the following person(s) personally appeared before me this day and (X) I have
personal knowledge of the identity of the principal(s); () I have seen satisfactory evidence of the
principal's identity, by a current state or federal identification with the principal's photograph in the form
of a driver's license; () a credible witness has sworn to the identity of the principal(s); the principal(s
acknowledging to me that he or she voluntarily signed the foregoing document for the purpose states
therein and in the capacity indicated:
Name of Brigging (A), Affiches Course B. H Visa Brasident World Windston of Brasid Brasident
Name of Principal(s): Michael Scott Balkcum, Vice President, Wealth Division of Branch Banking and Trust Company n/k/a Trust Bank, as Trustee of the Mary R. Lewis Revocable Trust U/A/I
September 13, 1979.
Date: 4/28/2021 En Montace
140th y Fault
ENEIDA MONTANEZ Eneida Montanez
· 17/10// [
Wake Co., North Carolina Printed or typed name of Notary Public
[SEAL] My Commission Expires Mar. 12, 2024 My commission expires: MAR.12, 2024
My commission expires:

NOTARY PUBLIC: Please place an (X) in the space that describes the method of identifying the principal and (--) in the spaces that do not apply.

EXHIBIT "A"

BEGINNING at a stake Mimms' northeast corner of a 2 acre tract of land and runs thence with a line of the Springs land East 11 chains and 91 links to a stake in the Deaton land; thence as that line South 4 West 4 chains and 85 links to a stake, Von Canons' corner; thence with his line South 81 West 10 chains and 61 links to a stake; thence North 9 West 6 chains and 60 links to the Beginning, containing 5.9 acres more or less. And being the same land as described in Deed dated December 16, 1911, from D.A. McDonald and wife, Ida A. McDonald, to Charles Ritter, recorded in the Public Registry for Moore County in Book of Deeds 49, at Page 445.

Excepting, However, from the above description a small tract of land deeded to Duncan C. Ritter by Charles Ritter in Deed Book 92, Page 371 and now owned by Glennie McInnis Parrott.

